SITE PLAN REVIEW AGENDA

4/19/2023 - 9:00 A.M. (Via Microsoft Teams)

To review supporting documents, click on the "SITE PLAN NO" link, then click on "Record Info" / "Attachments"

ITEM NO: 1 Resubmit
SITE PLAN NO: SPR23037

PROJECT TITLE: Serpa Packaging Soulutions

DESCRIPTION: Building Remodel for Serpa Packaging Soulutions (I-L)

APPLICANT: Aaron Oliver

OWNER: SERPA FERNANDO M (TR)

APN: 077200015

LOCATION: 7020 W SUNNYVIEW AVE

ITEM NO: 2 Resubmit SITE PLAN NO: SPR23057

PROJECT TITLE: Bombshell Beans

DESCRIPTION: Park Bombshell Beans Mobile Coffee Truck Daily 7 am - 7 pm. (C-S)

APPLICANT: Stephen Mohr

OWNER: GALANTE FREDDIE J & KRISTA(TRS)(FJG &

APN: 100030021

LOCATION: 1441 E MINERAL KING AVE

ITEM NO: 3 Added to Agenda

SITE PLAN NO: SPR23059

PROJECT TITLE: Market, Coffee & Pastry Drive-Thru

DESCRIPTION: Proposal is to Construct two New Retail Buildings. (C-N)

APPLICANT: Michael Porter OWNER: TAING SIEN APN: 091161009 091161047 091161052

LOCATION:

ITEM NO: 4 Added to Agenda

SITE PLAN NO: SPR23060

PROJECT TITLE: Gas Station at 100 W. Mineral King Ave

DESCRIPTION: A New 3380 SF. Retail Building with 2 Tenant Spaces (2180 Mini-Mart, 1 new 3380sf Retail Building with

Tenant Spaces (2180 sf & 1200sf) and an Existing 4 Pump Gas Station, Covered Area is 1568 sf. (D-MU

APPLICANT: Parminder Singh

OWNER: JSTLLC APN: 094313010

LOCATION: 100 W MINERAL KING AVE

ITEM NO: 5 Added to Agenda

SITE PLAN NO: SPR23061

PROJECT TITLE: Lady's Chicken and Rice

DESCRIPTION: New 1597 sf Building with Walk-up Restaurant with new Parking Lot/Layout and New Landscaping. (C-W

APPLICANT: Bounleuk and Jimmy Thongseng

OWNER: THONGSENG JIMMY & BOUNLEUK Y

APN: 094130049

LOCATION:

SITE PLAN REVIEW AGENDA

4/19/2023 - 9:00 A.M. (Via Microsoft Teams)

To review supporting documents, click on the "SITE PLAN NO" link, then click on "Record Info" / "Attachments"

ITEM NO: 6 Added to Agenda

SITE PLAN NO: SPR23062

PROJECT TITLE: 2001 S Mooney Commercial Retail Bld Renovation

DESCRIPTION: Exterior Facade and Demising/Remodel and Existing 1 Story Former Bank Building into a Multi-Tenant

Configuration to Accommodate 3 Tenant Suites.

APPLICANT: Matt Nohr

OWNER: 2001 MOONEY WEP LLC

APN: 121160011

LOCATION: 2001 S MOONEY BLVD

ITEM NO: 7 Added to Agenda

SITE PLAN NO: SPR23063
PROJECT TITLE: Free Radical

DESCRIPTION: Provision of Full-Body Infrared Light Immersion for the Purpose of Body Detoxification and overall

well-being.

APPLICANT: Jamaica Gentry


OWNER: ABBOTT DONALD G & H DEE (TRS)

APN: 126480056

LOCATION: 4040 S DEMAREE ST

	Y OF VISALIA SITE PLAN RE	
All .	is application MUST to filled out in its entirely and submitted novemum requirements & submitted details on Page 2). Failure result in rejection of your application and exclusion for	to provide all requested information may sm the Site Plan Review agends.
Site Plan Review most	ings are hold on Wednesdays at \$.00 a.m. ordina utilizing Micros Application automitus deadine are Thursday at 4.00 p.m. to be sof	
	Serpa Packaging Solutions	Oate 4/5/23
Project/Business Name: Project/Descriptor:	building remodel for Serpa Packaging Solution	THE RESIDENCE SHOWING THE PROPERTY OF THE PROP
_		
Site Plan Review Resultin	nital Yes 🕲 No 🔾 If Resubmittel Prevo	nus Site Plan Review Number SPR 23037
Property Owner S	erpa Packaging Solutions	
Applicant(x) Name: Fo	ernando Serpa	
Project Address/Location	7020 W. Sunnyview Ave.	
Assessor Parcel Number	0 7 7 2 0 0 0 1 5	
Percel Size (Acreage or 5	Iquare Foots 5.0 Acres Building o	r Suite Square Footage 9,969 s.f. (Remodel)
Are There Any Processed	Building Modifications Yes (X) No (THIS AREA FOR CITY STAFF USE ONL
Estimated Cost of Modific		4/13/23
	Down del misting man fort	
metal building.	itting Motificatoris Remodel existing manufactu	Zure sira 23-03
	neny Meanumers. Remodel existing manufactu	Zarre: SPR No. 23-03 Historic District Yes No. (
metal building.		Zove SPR No. 23 - 03 Heater's District Yes No. (Flood Zone X AE () XIAE ()
metal building.	MEPARATE, DETAILED OPERATIONAL STATEMENT IS HIGHLY	Zove SPR No. 23 - 03 Heater's District Yes No. (Flood Zone X AE () XIAE ()
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metal building.	Manufacturing Manufacturing 7 A.M-3:30 P.M.	Zove SPR No. 23 - 03 Heater's District Yes No. (Flood Zone X AE () XIAE ()
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metal building.	Manufacturing Manufacturing Manufacturing T.A.M-3:30 P.M. 10 (Grow) So T w To D Sa Day Evening 85	ZuneSPR No. 23-03 Historic DistrictYes No
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1		LAN MINIMUM REQUIREMENT			
	Submit a digital copy of the site prance; and completed application on a flush drive or equivalent (PCF former preferred, hard paper copies not accepted). **Digital copies must be clear, legible, and on a legical sized appropriately to convey all recessary project information.				
4					
	All entiting & proposed site features . Ago Site dimensions, including building . Ref.	sting & proposed structures apart street names Lise endosures & containers ley sak trees (ahow drip line)	- Accessit - Accessit	urloading areas is path of travel from right of way in path of travel from AGA stall and width of drive approaches to sil	
	Public improvements (curbs, sidewalks. Villy poles, hydrants, smed lights, etc.) Parl			maps shall adhers to requirements Municipal Code Section 16	
1	aplicant information (Final comments will be mailed to the re	one and address provided below)			
1	tare Engineers, Inc. 979 N. Blackstone St.	Suprague of Owner or Authorized	Agent.	4/5/23	
10	On Sure Zo Tulare, CA, 93274	Own	-	Date	
1	hore (559) 688-5263	16		4/5/23	
8	mail waif laneengineers.com	Authorized Agent"		Date	
	" if eighted by an euthorized agent, the "Agency Authorization" into				
	Owner Fernando Serpa secio	NCY AUTHORIZATION	rtain real prop	only bearing essessor's	
	Owner. Fernando Serpa escis percel number (APIN) 077-200-015		rtain real prop	erly bearing essessor's	
	Country Fernando Serpa escis partel number (APIG) 077-200-015 AGENT I designate Lane Engineers, Inc. an application for, and strain a parasers Remodel of	ere as follows, I am the owner of cor	_		
	Owner. Fernando Serpa esti percel number (APRI): 077-200-015 AGENT	ore as follows, I am the owner of cer to act as my duly authorized ag existing building for Serpa	_		
	Owner. Fernando Serpa esti percel number (APIN) 077-200-015 ASENT I designate Lanc Engineers, Inc. an application for, and sotain a permit to _Remodel or relative to the property mentioned herein. I declare under penalty of perjury the foregoing is true and	to act as my duly authorized ay content building for Serpa	_		
	CountR. 1 Fernando Serpa esci 2017-200-015 AGENT 1 designate Lanc Engineers, Inc. 21 application for, and sotain a permit toRemodel or relative to the property mentioned heren. 1 declare under penalty of perjury the foregoing is true and	ore as follows, I am the owner of cor to act as my duly authorised as existing building for Serpa	pert for all pur Packaging		
	Owner. [Fernando Serpa esti percel number (APIN): 077-200-015 activi 1 designare Lanc Engineers, Inc. an application for, and setain a permit to _Remodel or relative to the property mentioned herein. I declare under penalty of perjury the foregoing in true and tivecuted this	to ACI as the during of certaining building for Serpa constring building for Serpa connect 20.71. beparation	pert for all pur Packaging	poses necessary to the Solutions.	
	CountR. Fernando Serpa esti percel number (APIN) 077-200-015 ASENT designate Lanc Engineers, Inc. an application for, and sotation a personal to Remodel or relative to the property mentioned herein. declare under penalty of perjury the foreigning is true and become under penalty of perjury the foreigning in true and become under penalty of perjury the foreigning is true and become under penalty of perjury the foreigning in true and become under penalty of perjury the foreigning in true and become under penalty of perjury the foreigning in true and become under the penalty of perjury the foreigning in true and become under the penalty of penalty of the pena	to act as my duly authorized agreement. 20.23 Represent	pert for all pur Packaging	poses necessary to the Solutions.	
	CountR. 1 Fernando Serpa escis parcel number (APRI): 077-200-015 ASSNT 1 designate Lanc Engineers, Inc. 1 designate Inc. 1 designate Lanc Engineers, Inc. 1 designate Inc. 1 designate Lanc Engineers, Inc. 1 designate Lanc Engineer	to act as my duly authorized as containing building for Serpa between 2021 because of agents 979 N. Blackst	poet for all pur Packaging	poses recessory to the Solutions.	



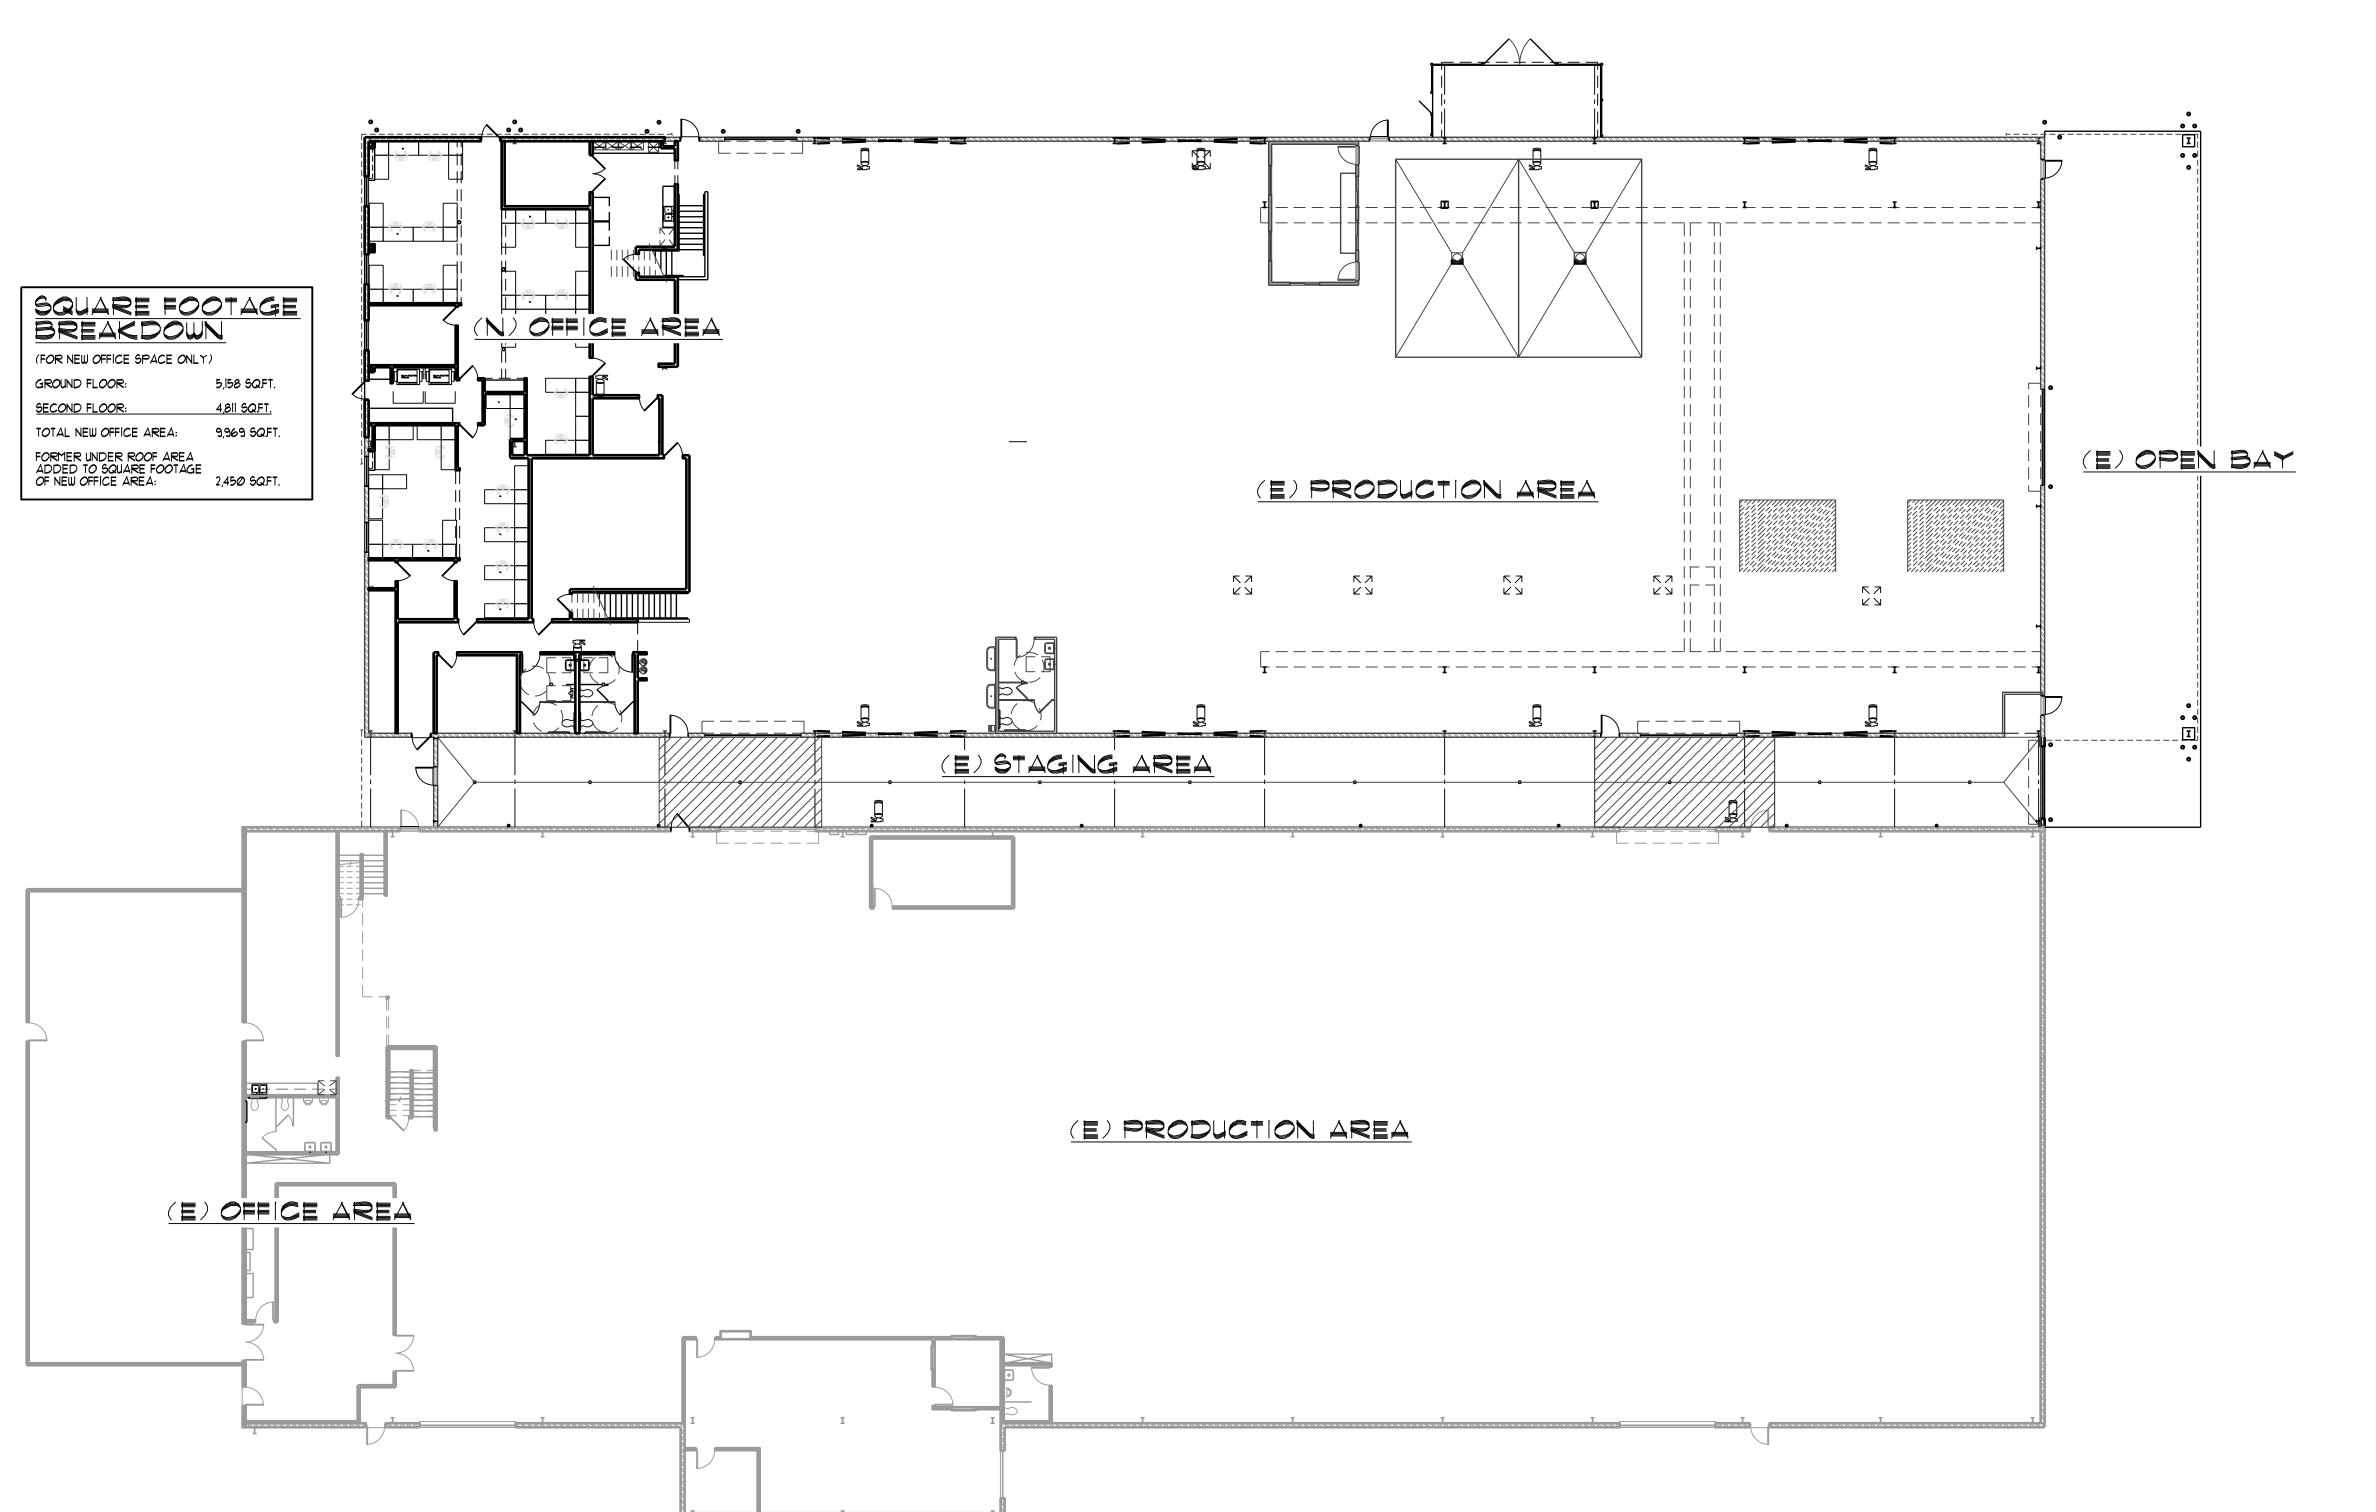

TOTAL PERIMETER: PERIMETER LESS THAN 55': PERIMETER MORE THAN 55':

802 / 1102 = .73 OR 73% PER TABLE 506.3.3

ALLOWABLE AREA INCREASE FACTOR BASED ON FRONTAGE, Ir = .50 F-I OCC., TYPE II-B CONST., SPRINKLERED: 62,000SF. MAX. ALLOWED AREA INCREASE ALLOWED + BASE ALLOWED = MAX. ALLOWED SF. $(.50 \times 62,000) + 62,000 = (31,000) + 62,000 = 93,000 \text{ SF}.$

BUILDING INFORMATION ADDRESS: 1020 W. SUNNYVIEW AVENUE VISALIA , CA 93291 Ø77-200-015 A.P.N.:

LOT AREA: 217,822 S.F., 5 ACRES SITE PLAN REVIEW: 2023-037 MANUFACTURING AREA OCCUPANCY:

CONSTRUCTION TYPE: II - B

BUILDING *1

OFFICE AREA (GROUND FLOOR): OFFICE AREA (SECOND FLOOR): FACTORY AREA: PRODUCTION AREA: COVERED AREA: TOTAL: TOTAL AREA UNDER ROOF: 38,559 SF. 4,**0**27 S.F.

STAGING AREA:

BUILDING #2 OFFICE AREA (GROUND FLOOR): OFFICE AREA (SECOND FLOOR): FACTORY AREA: PRODUCTION AREA: COVERED AREA: TOTAL:


TOTAL AREA UNDER ROOF: BASE SQUARE FOOTAGE ALLOWED: SQUARE FOOTAGE ALLOWED W/ AREA INCREASE: ACTUAL SQUARE FOOTAGE:

METHOD OF SANITARY DISPOSAL: CITY OF VISALIA

OFFICE SPACE TO TOTAL BUILDING AREA PERCENTAGE: OFFICE SPACE (TOTAL) = 6,886 SF + 9,969 SF = 16,855 SF TOTAL SQUARE FOOTAGE = 77,818 SF

WATER:

PERCENTAGE = 16,855/77,818 = 0.22 < 0.25 CUP NOT REQUIRED

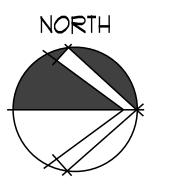

35,232 S.F.

62,000 S.F.

93,*000* S.F.

77,818 S.F.

CAL WATER SERVICE

ARCHITECTURE AND PLANNING 120 N. "L" STREET
TULARE, (ALIFORNIA 93274
PH: (559) 688-2071
FAX: (559) 688-2073
MIKEP@TAEIN(.COM

AFFILIATIONS:

• LEADERSHIP IN ENERGY AND
ENVIRONMENTAL DESIGN

ARCHITECT:

MICHAEL PORTER
LEED AP
STATE OF (ALIFORNIA LIC. NUM. - (-28927

CONSULTANT:

PROJECT:

RING

VISALIA, A DATE REVISION


THIS IS AN ORIGINAL UNPUBLISHED WORK AND MAY NOT BE REPRODUCED DUPLICATED, PUBLISHED OR OTHERWISE USED IN PART OR WHOLE WITHOUT WRITTEN (ONSENT OF MICHAEL P. PORTER, ARCHITECT, TAE ⊚


SHEET DESCRIPTION: FLOOR PLAN -OVERALL FACILITY


1/4" = 1'-0"


PROJECT NUMBER: A.114.21

OVERALL GROUND FLOOR PLAN

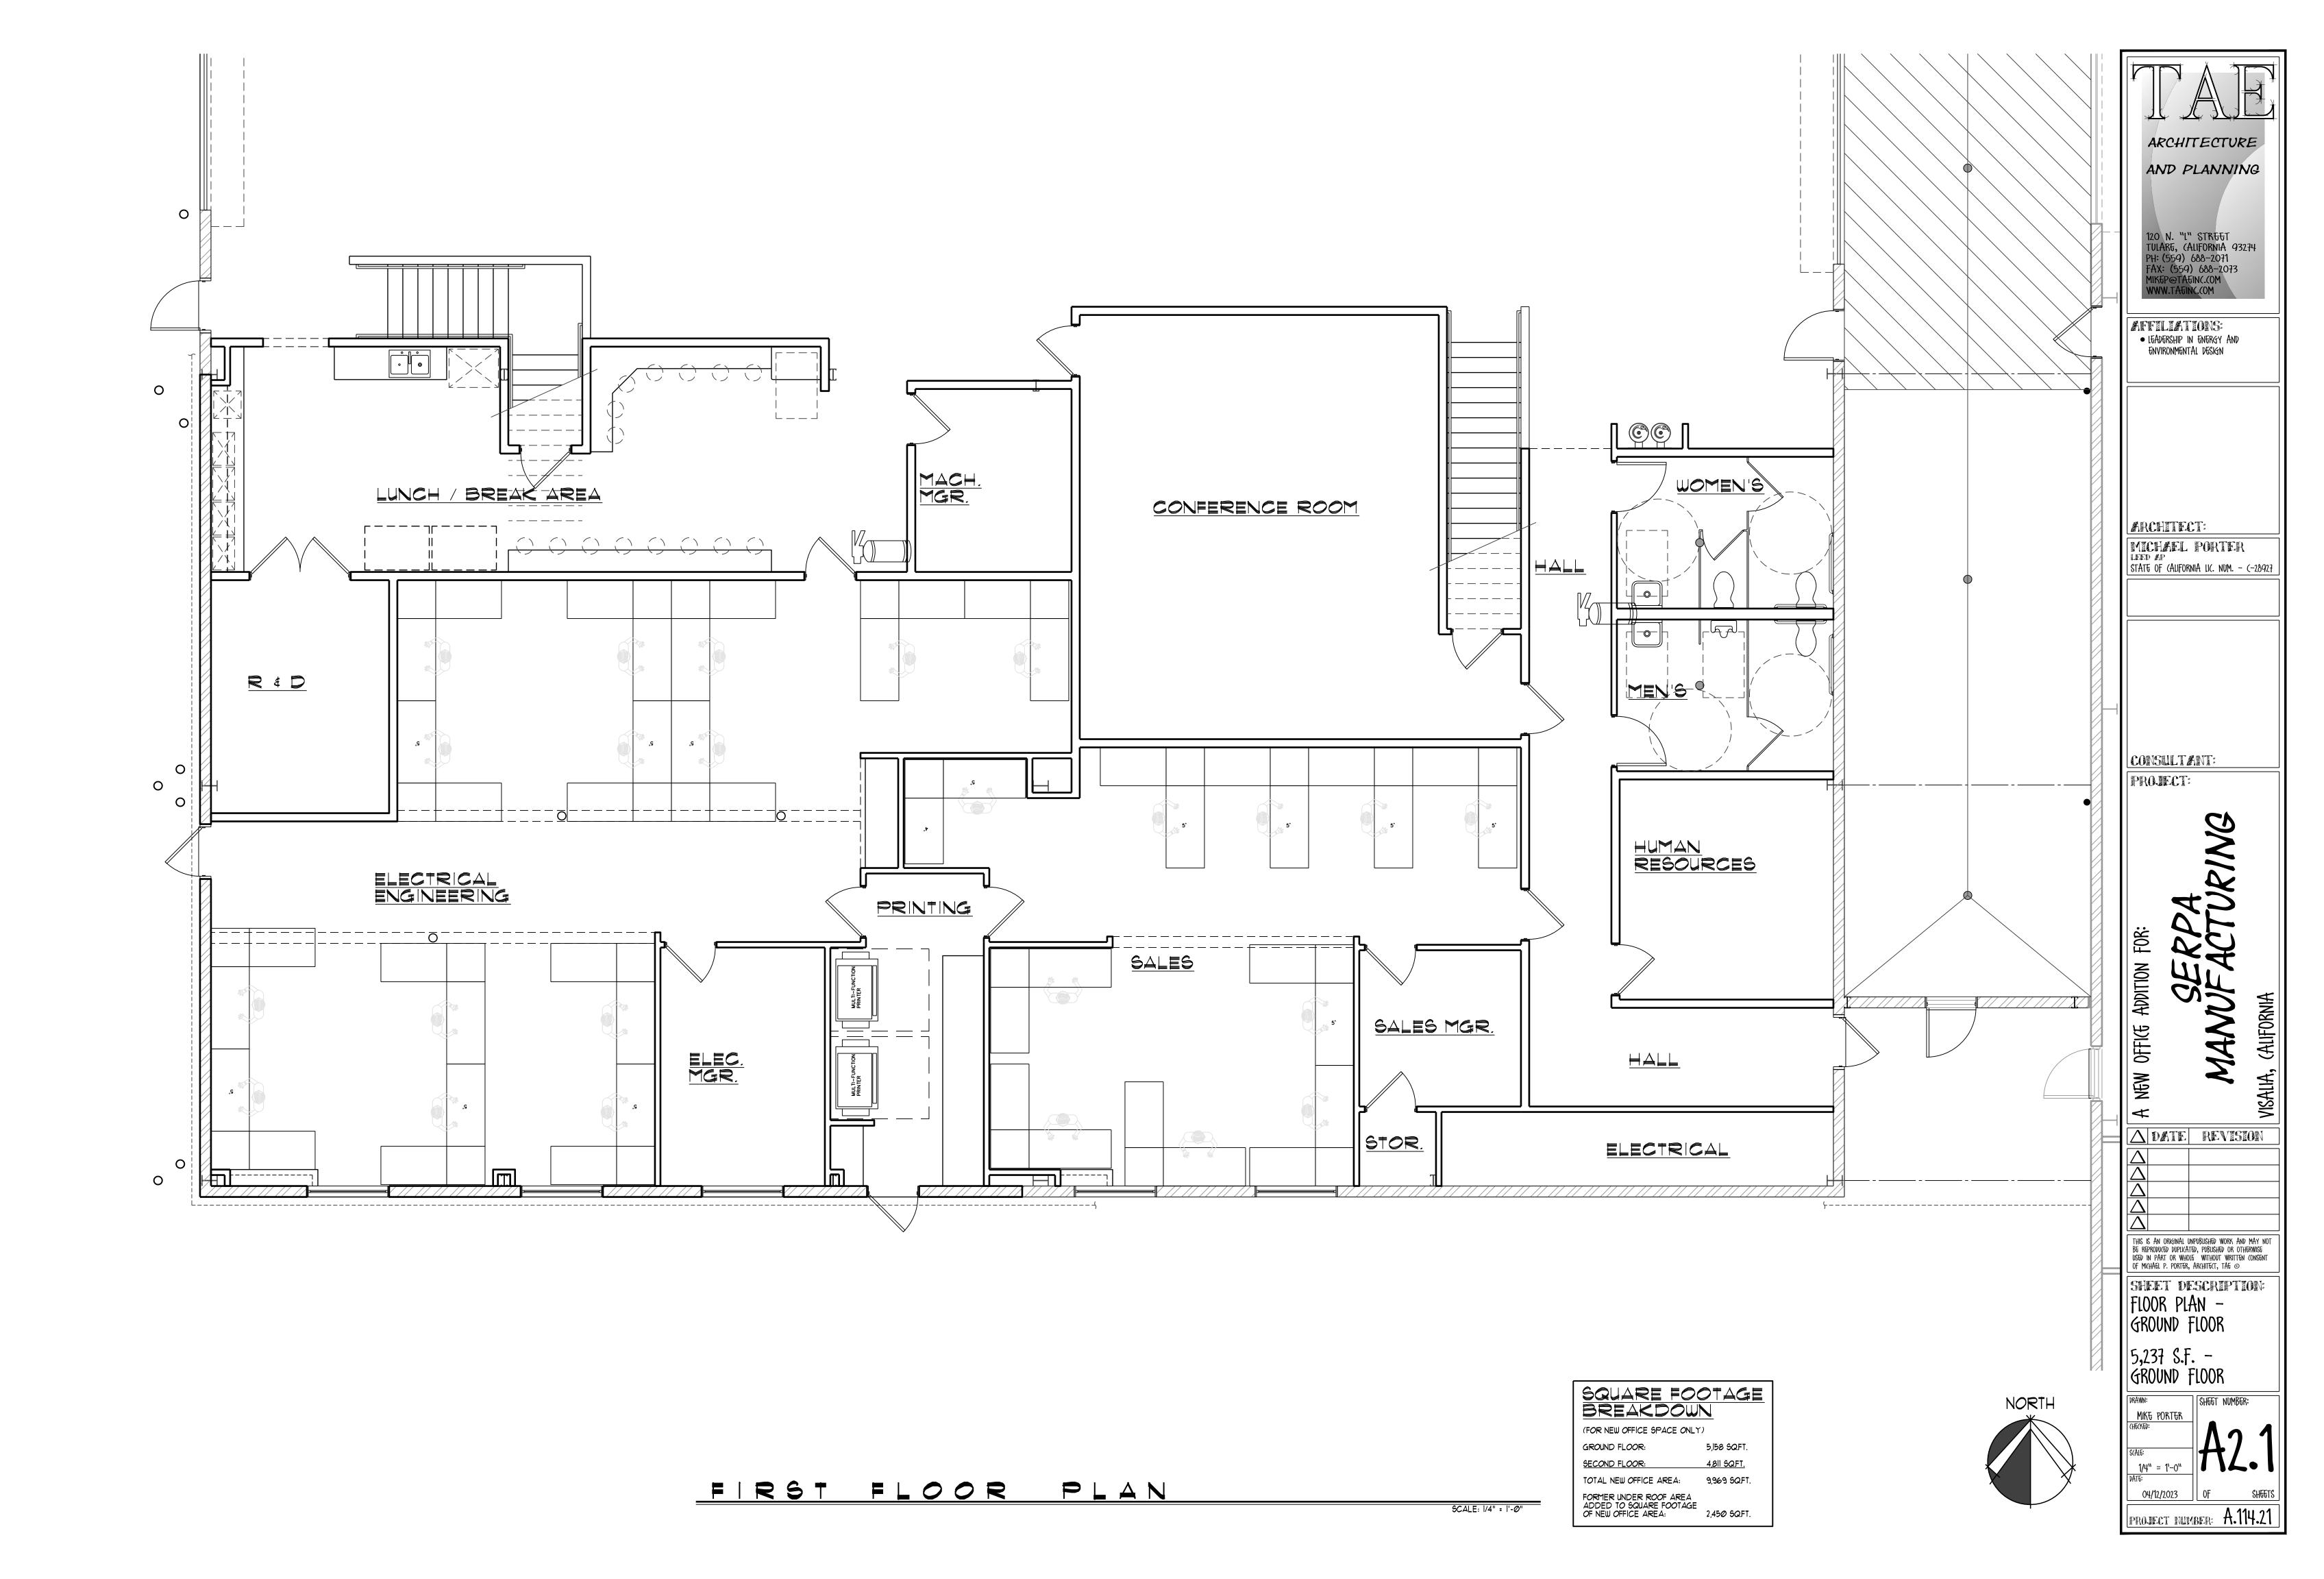

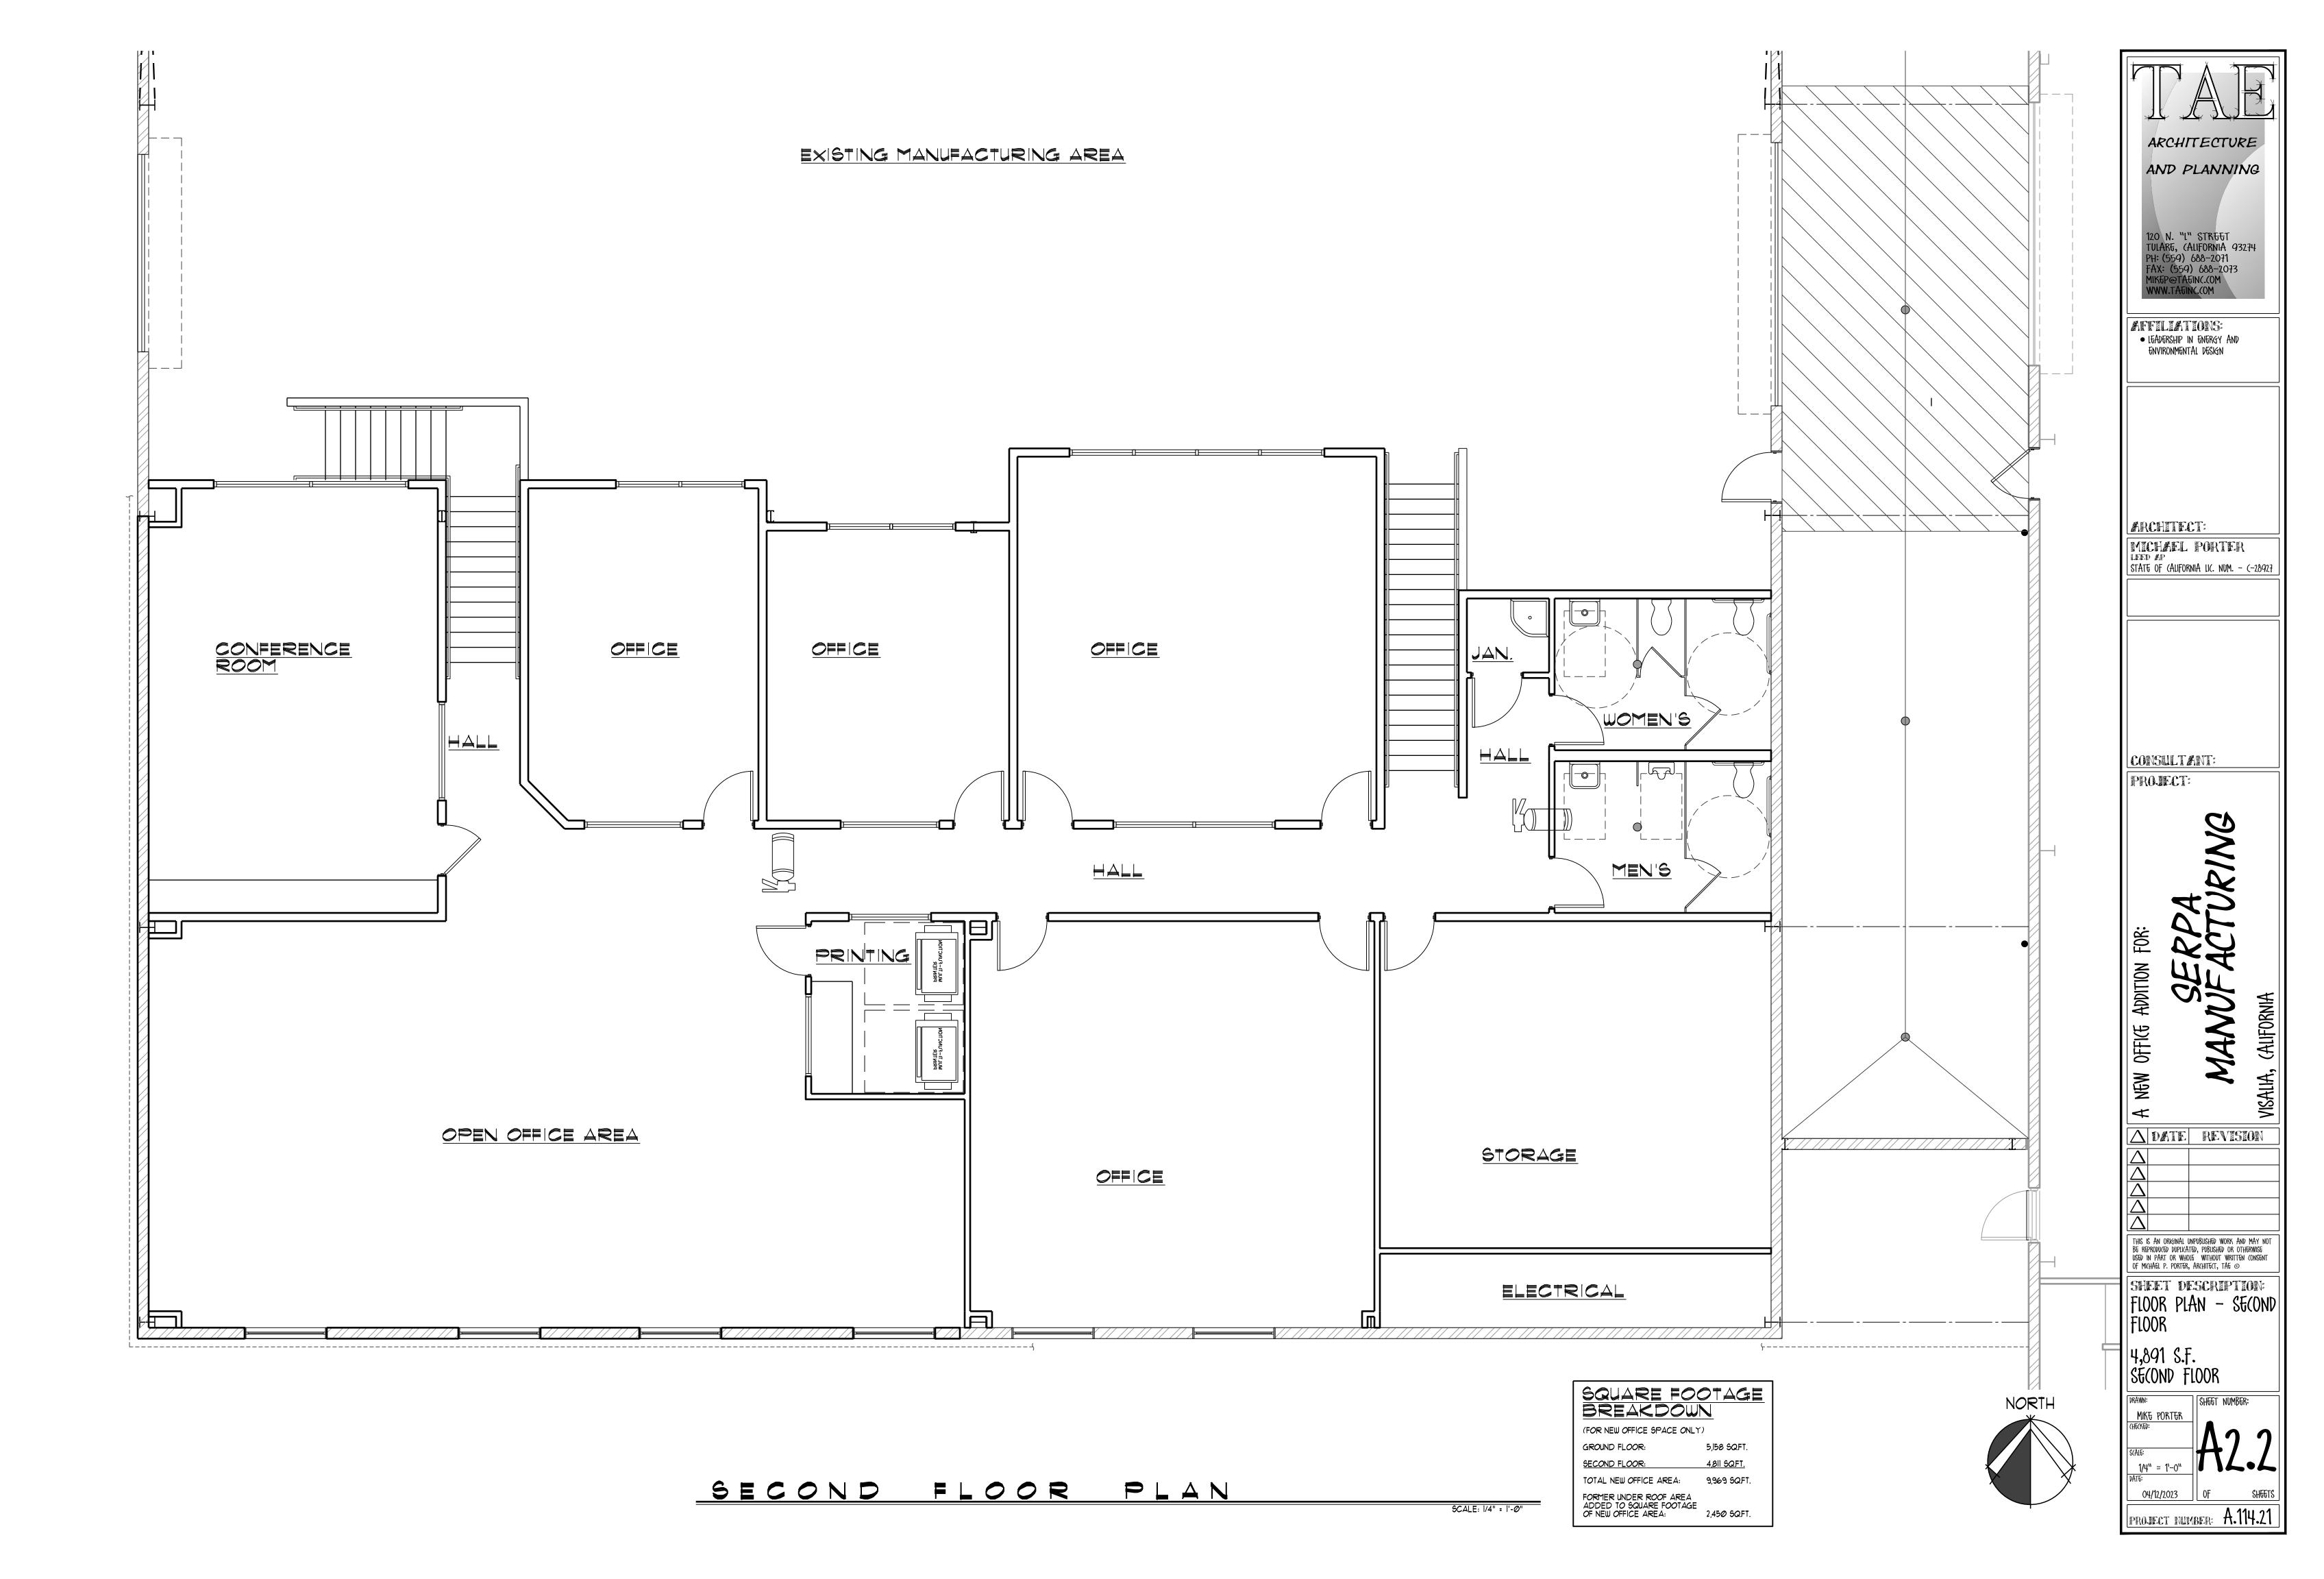

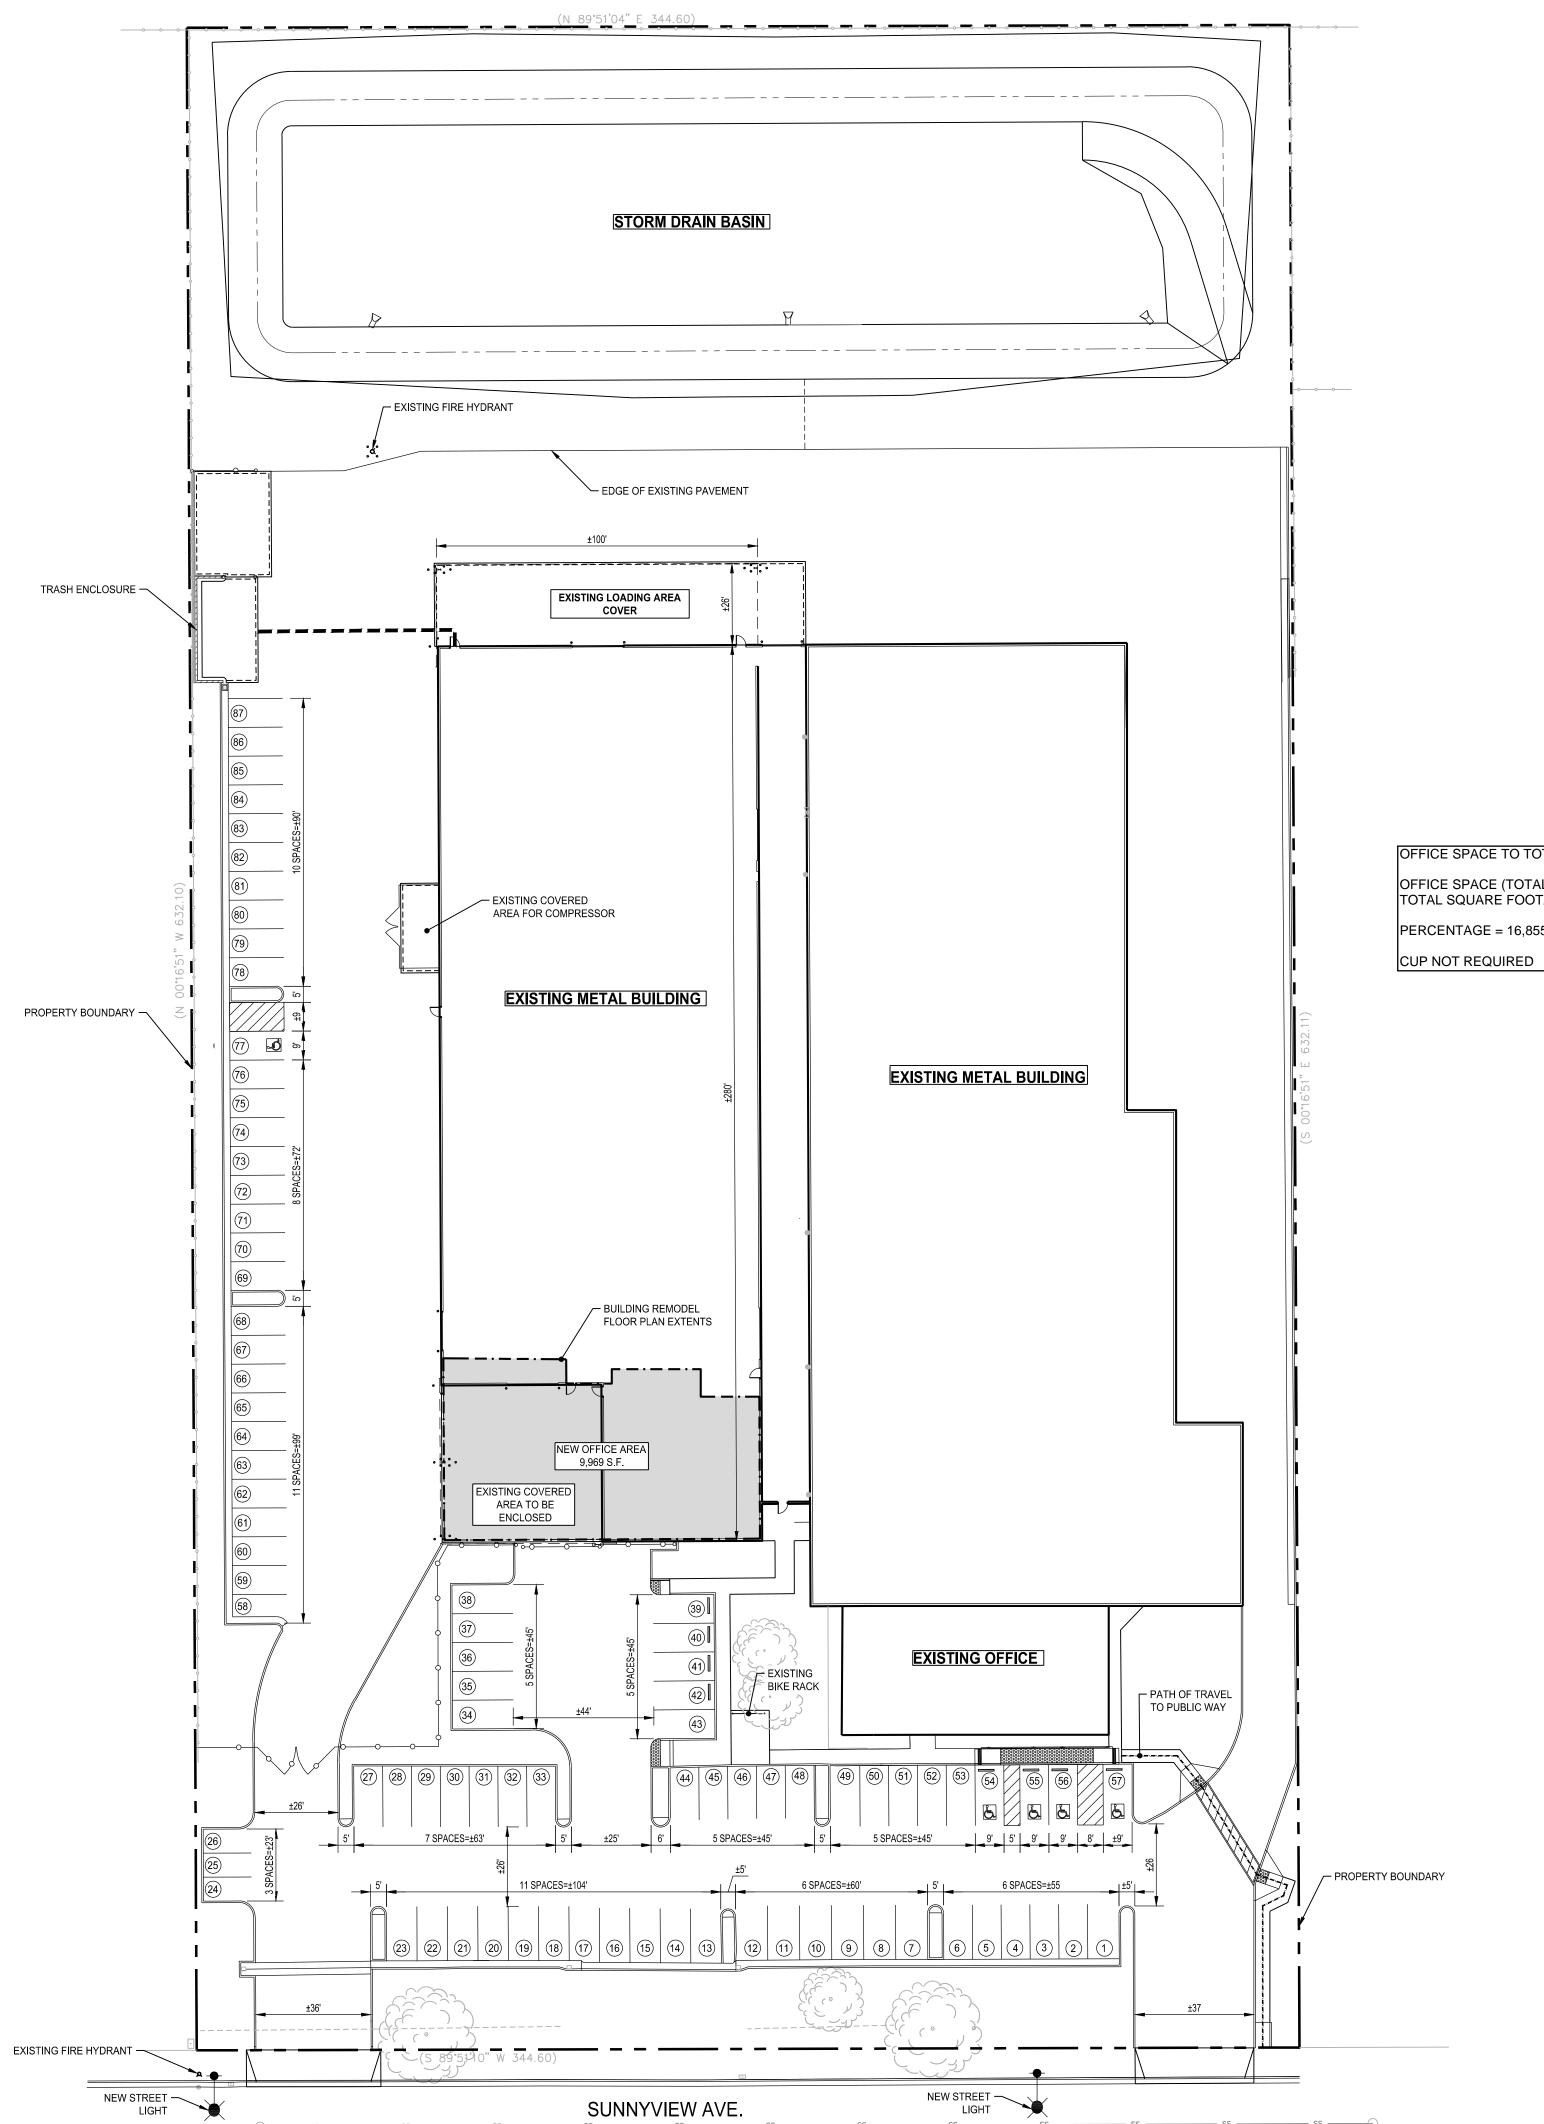

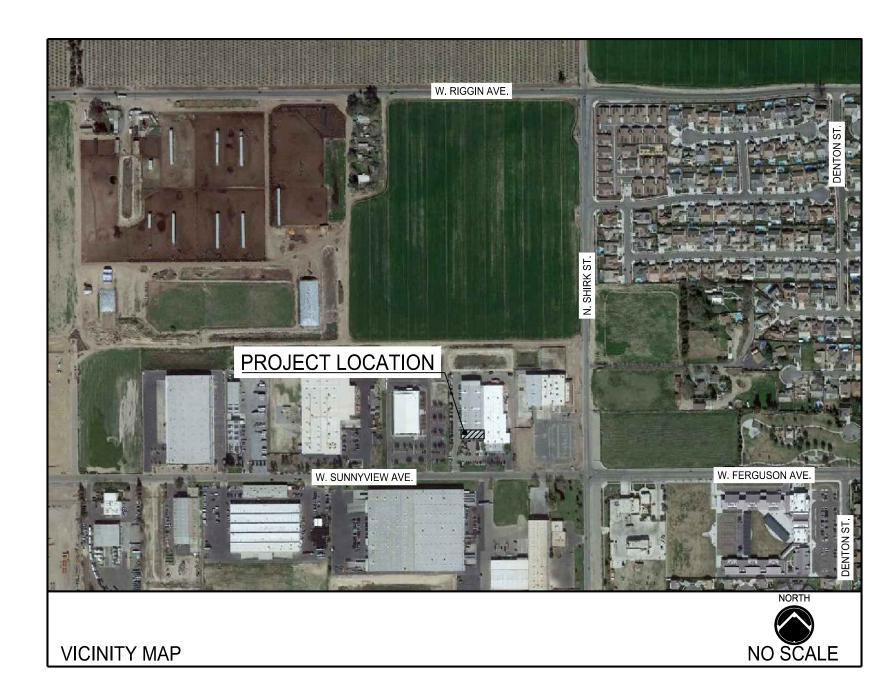

OFFICE SPACE TO TOTAL BUILDING AREA PERCENTAGE: OFFICE SPACE (TOTAL) = 6,886 SF + 9,969 SF = 16,855 SF TOTAL SQUARE FOOTAGE = 77,818 SF

PERCENTAGE = 16,855/77,818 = 0.22 < 0.25

SITE DATA GROSS SITE AREA

077-200-015 ±5.0 ACRES LIGHT INDUSTRIAL (I-L) EXISTING ZONING GEN. PLAN LAND USE FLOOD ZONE X (SHADED) SOUTHERN CALIFORNIA EDISON CO. ELECTRIC WATER CALIFORNIA WATER SERVICE CO.

GAS SEWER SOUTHERN CALIFORNIA GAS CO. CITY OF VISALIA STORM PRIVATE BASIN SOLID WASTE CITY OF VISALIA MINIMUM BUILDING SETBACKS FRONT*: 25'

REAR: 20' (ABUTTING AN R-1 OR R-M ZONE) REAR:

PARKING REQUIREMENTS
CURRENT MAX. EMPLOYEES PER SHIFT = 85 MAX. EMPLOYEES PER SHIFT AFTER REMODEL = 85 REQUIRED PARKING STALLS = 85

EXISTING STANDARD PARKING STALLS = 79
EXISTING COMPACT PARKING STALLS = 3 EXISTING ACCESSIBLE PARKING STALLS = 5 (TWO VAN ACCESSIBLE) TOTAL EXISTING PARKING STALLS = 87 STALLS EXISTING 87 STALLS > REQUIRED 85 STALLS OK

OWNER/DEVELOPER

SERPA PACKAGING SOLUTIONS 7020 W. SUNNYVIEW AVENUE VISALIA, CA 93291 CONTACT PERSON: JUSTIN NEECE (559) 651-2339

ENGINEER


LANE ENGINEERS, INC. 979 N. BLACKSTONE ST. TULARE, CA 93274 CONTACT PERSON: (559) 688-5263

LEGEND PROPERTY BOUNDARY

TRASH ENCLOSURE ACCESS

PATH OF TRAVEL TO PUBLIC WAY

SITE PLAN REVIEW (TENANT IMPROVEMENT)

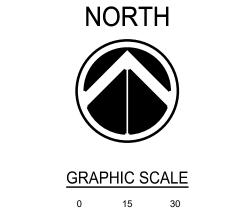


1 INCH = 30 FT.

BUILDING REMODEL

7020 W. SUNNYVIEW AVE. VISALIA, CALIFORNIA

Prepared For SERPA PACKAGING SOLUTIONS

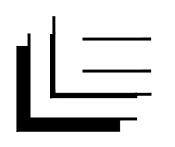

LANE ENGINEERS, INC. CIVIL • STRUCTURAL • SURVEYING

979 North Blackstone Street Tulare, California 93274 559.688.5263

www.laneengineers.com

Description

All reproduction & intellectual property rights reserved © 2023 Professional Seal

PRELIMINARY R.C.E. 73146 NOT FOR

Release Date

No.	Revision			Date
	1 (0 (101011			Date
	•		•	

Drawn by: W.V./T.C Reviewed by: W.V.

Sheet Title

SITE PLAN REVIEW

Original drawing is 24 x 36. Do not scale contents of this drawing. Sheet Number

SPR-2

Project No: 21199

CITY OF VISALIA SITE PLAN REVIEW APPLICATION

Additional information and assistance in filling out this application can be found at the City of Visalia website (www.visalia.city) or by calling (559) 713-4440.




This application MUST be filled out in its entirety and submitted with an acceptable site plan (see site plan minimum requirements & submittal details on Page 2). Failure to provide all requested information may result in rejection of your application and exclusion from the Site Plan Review agenda.

Site Plan Review meetings are held on Wednesdays at 9:00 a.m. online utilizing Microsoft Teams. The applicant or representative must be present.

Application submittal deadline are Thursday at 4:00 p.m. to be scheduled for the next available meeting.

	Project/Business Name: Free Radical	Date: <u>4/13/2023</u>	
_	Project Description: Provision of full-body infrared light immersion fo	r the purpose of body detoxification	
INFORMATION	and overall well-being.		
ORM	Site Plan Review Resubmittal: Yes No X If Resubmittal, Previous Site Pl	lan Review Number:	
I INF	Property Owner: Abbott Family Revocable Trust		
OJEC	Applicant(s) Name: Jamaica Gentry		
GENERAL PROJECT	Project Address/Location: 4040 S. Demaree Avenue, Suite A		
ENER/	Assessor Parcel Number: **\(\frac{126-480}{2}\) **\(\f		
9	Parcel Size (Acreage or Square Feet): Building or Suite So	quare Footage: 2,256	
	Are There Any Proposed Building Modifications: Yes No 🗙	THIS AREA FOR CITY STAFF USE ONLY	
	Estimated Cost of Modifications to Building:	Date Received:	
	Describe All Proposed Building Modifications:	SPR Agenda: 04/19/2023 Item No	
		Zone: <u>O-P</u> SPR No. <u>23-063</u>	
		Historic District: Yes No	
		Flood Zone: X X AE X/AE	
	A SEPARATE, DETAILED OPERATIONAL STATEMENT IS HIGHLY RECOM	MENDED FOR ALL SUBMITTALS	
	Existing/Prior Building Use: Rehab Therapy Office		
	Proposed Building Use: Infrared Therapy Office		
	Proposed Hours of Operation: 10am - 5pm		
TION	Days of Week In Operation (Circle): Su M T W Th F Sa		
C INFORMATION	Number of Employees Per Day: Existing Proposed	d <u>2</u>	
INFO	Number of Customers Per Day (Estimated): Existing Propose	d <u>15</u>	
AFFI	Predicted Peak Operating Hour: 2pm		
& TR	Describe Any Truck Delivery Schedule & Operations: N/A		
IONS			
Describe Any Truck Delivery Schedule & Operations: N/A Please Identify Any Unique or Specific Traffic Patterns That Will Require Accommodations For Operations, Customers, or Employees (Provide Separate Attachment if Necessary): N/A			
Ö	(Provide Separate Attachment if Necessary): N/A		
	Describe Any Special Events Planned for the Facility: N/A		
	Page 1 of 2 - Application continues on back of the	his page	

	SITE PLAN MINIMUM REQUIREMENTS				
	Submit a digital copy of the site plan(s) and completed application on a flash drive or equivalent (PDF format preferred, hard paper copies				
ITS	not accepted).				
SITE PLAN REQUIREMENTS	⇒ Digital copies must be clear, legible, and on a layout sized appropriately to convey all necessary project information.				
JUF	⇒ Site plan shall provide for and indicate all of the following:				
RE(- North arrow - Existing & proposed structures - Loading/unloading areas				
LAN	- All existing & proposed site features - Adjacent street names - Accessible path of travel from right of way				
re p	- Site dimensions, including building - Refuse enclosures & containers - Accessible path of travel from ADA stall				
-IS	- Existing and proposed fencing at site - Valley oak trees (show drip line) - Location and width of drive approaches to site				
	- Public improvements (curbs, sidewalks, - Existing & proposed landscaping - Tentative maps shall adhere to requirements				
	utility poles, hydrants, street lights, etc.) - Parking stalls (include ADA) of Visalia Municipal Code Section 16				
	Applicant Information (Final comments will be mailed to the name and address provided below)				
JRE	Name: Jamaica Gentry Signature of Owner or Authorized Agent*				
IATL	Address: 3024 W Orchard Ave Jamaica Gentry 04/13/23				
NDIS	Ounce Data				
ED §	City, State, Zip <u>Visalia, CA 93277</u> Phone: (559) 362-2017				
REQUIRED SIGNATURE	A. (b				
REC	Email: jamaicag23@gmail.com				
	* If signed by an authorized agent , the "Agency Authorization" information below must be completed for this application to be considered acceptable.				
	AGENCY AUTHORIZATION				
	OWNER:				
	I,, declare as follows; I am the owner of certain real property bearing assessor's				
	parcel number (APN):				
	AGENT:				
	I designate, to act as my duly authorized agent for all purposes necessary to file				
Σ	I designate, to act as my duly authorized agent for all purposes necessary to file an application for, and obtain a permit to				
FOR	relative to the property mentioned herein.				
NOI					
AGENCY AUTHORIZATION FOR	I declare under penalty of perjury the foregoing is true and correct.				
10R	Executed this day of, 20				
\UT					
(C <i>Y</i> /	OWNER Signatures AGENT				
GEN	<u></u>				
A					
	Signature of Owner Signature of Agent				
	Owner Mailing Address Agent Mailing Address				
	<u> </u>				
	Owner Phone Number Agent Phone Number				
	Page 2 of 2				
	I QUE & VI &				

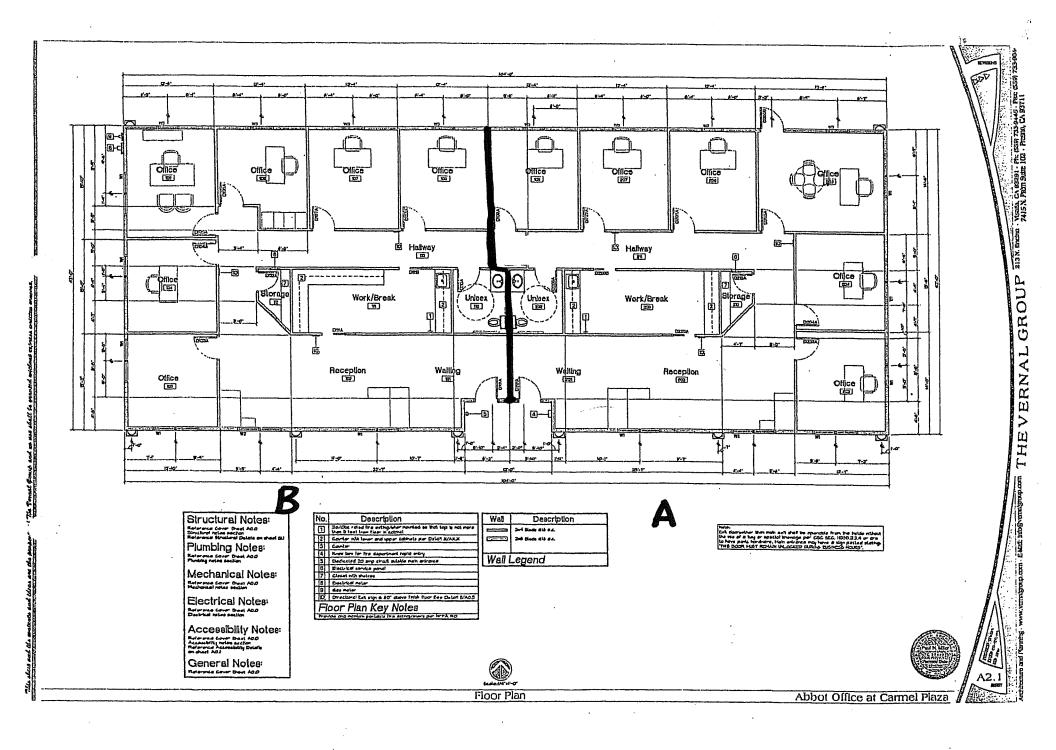

CITY OF VISALIA SITE PLAN REVIEW APPLICATION

- Additional information and assistance in filling out this application can be found at the City of Visalia website (www.visalia.city) or by calling (559) 713-4440-



This application MUST be filled out in its entirety and submitted with an acceptable site plan (see site plan minimum requirements & submittal details on Page 2). Failure to provide all requested information may result in rejection of your application and exclusion from the Site Plan Review agenda.

Site Plan Review meetings are held on Wednesdays at 9am at City Hall East - 315 E Acequia Ave - Applicant(s) or Representative(s) must be present -- Application submittal deadline is 4pm on Thursdays to be scheduled for the next available meeting -Project/Business Name: Project Description: INFORMATION Site Plan Review Resubmittal: If Resubmittal, Previous Site Plan Review Number: Property Owner: PROJECT Applicant(s) Name: Project Address/Location: Assessor Parcel Number: Parcel Size (Acreage or Square Feet): Building or Suite Square Footage: Are There Any Proposed Building Modifications: --- THIS AREA FOR CITY STAFF USE ONLY ---Estimated Cost of Modifications to Building Date Received: Describe All Proposed Building Modifications: SPR Agenda: Item No. Zone: SPR No. Historic District: Yes (No Flood Zone: AE () X/AE () - - A SEPARATE, DETAILED OPERATIONAL STATEMENT IS HIGHLY RECOMMENDED FOR ALL SUBMITTALS - -Existing/Prior Building Use: EANS MOBILE COFFEE TRUC Proposed Building Use: Proposed Hours of Operation: OPERATIONS & TRAFFIC INFORMATION Days of Week In Operation (Circle): Su M T W Th F Number of Employees Per Day: Existing Proposed Number of Customers Per Day (Estimated): Existing Proposed Predicted Peak Operating Hour: Describe Any Truck Delivery Schedule & Operations: Please Identify Any Unique or Specific Traffic Patterns That Will Require Accommodations For Operations, Customers, or Employees (Provide Separate Attachment if Necessary): Describe Any Special Events Planned for the Facility: Page 1 of 2 - Application continues on back of this page

	SITE PLAN MINIMUM REQUIREMENTS				
	Submit a digital copy of the site plan(s) and completed application on a flash drive or equivalent (PDF format preferred, hard paper copies				
NTS	not accepted).				
ME	Digital copies must be clear, legible, and on a layout sized appropriately to convey all necessary project information.				
UIR					
SITE PLAN REQUIREMENTS	 ⇒ Site plan shall provide for and indicate all of the following: North arrow Existing & proposed structures Loading/unloading areas 				
PLAI	- All existing & proposed site features - Adjacent street names - Accessible path of travel from right of way				
SITE	- Site dimensions, including building - Refuse enclosures & containers - Accessible path of travel from ADA stall				
	 Existing and proposed fencing at site Public improvements (curbs, sidewalks, Existing & proposed landscaping Location and width of drive approaches to site Tentative maps shall adhere to requirements 				
	- Public improvements (curbs, sidewalks, utility poles, hydrants, street lights, etc.) - Existing & proposed landscaping - Tentative maps shall adhere to requirements of Visalia Municipal Code Section 16				
	of Vicalia Marilopal Gode Section 10				
(4)	Applicant Information (Final comments will be mailed to the name and address provided below)				
LURE	Name: STEPHEN MOHR Signature of Owner or Authorized Agent*				
REQUIRED SIGNATURE	Address: 1505/ ANE 296 3/6/23				
D SIC	City, State, Zip VISALIA IA 93290 Owner				
UIRE	Phone: 559 909 9752, STEPHEN MAHR 3/6/33				
REQ	Email: STEPHAL MO HR 84 (a Abl. Com) Authorized Agent* Date				
	* If signed by an authorized agent, the "Agency Authorization" information below must be completed for this application to be considered acceptable.				
	AGENCY AUTHORIZATION				
,	OWNER: 1, Krista Galante, GA ASSET Management WC 1, knista Galante, GA ASSET Management WC 1, declare as follows: I am the owner of certain real property bearing accessor's				
	I, Knsta Galante, declare as follows; I am the owner of certain real property bearing assessor's				
	parcel number (APN):				
	100 030 02				
	AGENT:				
	I designate STEATHANNAK to act as my duly authorized agent for all purposes				
FORM	an application for, and obtain a permit to PARK DOMBSHTIC BEHUS MIBILE (DEEPE TO LIVE)				
	relative to the property mentioned herein. DAILY TAM - TIM				
AGENCY AUTHORIZATION	I declare under penalty of perjury the foregoing is true and correct.				
IORIZ	Executed this 6th day of March , 2023.				
ACT.					
NC	OWNER Signatures AGENT				
AGE	AGENT				
	11/20				
	Signature of Owner Signature of Agent				
	2321 E Mobic Ave 15051 AVE 294				
	VISALIA CA 93292 Agent Mailing Address VISAUA CA 93292				
	559.734.4313 549 970 9754				
	Owner Phone Number Agent Phone Number				

Page 2 of 2

TCUP	NO	
. 00		The second secon



APPLICATION FOR TEMPORARY CONDITIONAL USE PERMIT

	1	Name of Applicant (s): STEDHEN MOHR Phone: 559 909 975
	2.	Applicant is the X Agent of the property owner Owner
	au	Note: If the applicant is not the current owner (e.g., property is in escrow), an agency thorization from the current owner is required.
1		Name of all owners, partners, proprietors, principals, etc.: Fred + Krista Galante, Anthony + Dava Galante
X		Address of Property: 1441 E Mineral King
1		Assessors Parcel No.: 100 030 021
X		Location of Property: Mineral King Street, between Bin Maddox
		and Lover's Lane
	7.	Legal Description of Property:
	8.	Existing Zoning of Property:
	10. and	the following purposes: ARK DOMBSHELL BEAUS MOBILE COFFEE TRUCK DAILY 1AM - 1FM Description of the proposed operation including days displayed hours of operation, number of employees, and any other pertinent information regarding your use at will assist in evaluation of your request.
		Plans and Drawings: Attach sketches or drawings to clearly show proposal.
	12.	declare under penalty of perjury, that I have mpleted this application and all other documents to the best of my ability, and all statements and cuments are true and correct to the best of my knowledge. I also declare under penalty of perjury it I am the legal owner, lessee or authorized agent of the property involved in this application. Dated
		15051 AVE 296 Address VISAUA VA 93292
		VISAUA 0A 93292 City and Zip Code

Pursuant to Zoning Ordinance Section 17.38.070, the City Planner, may refer this application to the Planning Commission for consideration, which will generate additional fees and time to process the application.

AGENCY AUTHORIZATION

OWNER: I, KISTA GU (Owne	dauke, declare as follows:
I am the owner of certain re	eal property bearing assessor's parcel number (APN):
AGENT: I designate STEPHEN (Agent	MOHR, to act as my duly authorized
agent for all purposes nece	essary to file an application for, and obtain a permit to AUS MBUE LIFEE TRUCK DAILY 7AM-1PM (Action Sought)
relative to the property men	
1 11A	perjury the foregoing is true and correct. day of
A Alakan	AGENT
(Signature of Owner) 2321 ENoble (Owner Mailing Address	Ave 15051 Avr. 2910
Visalia (A 559.734.4 (Owner Telephone)	
APPROVED:	'(Agent Telephone)
CITY OF VISALIA	
By:(Signature)	Date:
	IGNATURE MUST BE NOTARIZED. Attach acknowledgment of by Notary Public.


Temporary Conditional Use Permit for:

Operational Statement:

Days: Monday through Sunday (7 days a week)

Hours: 7am – 7pm

Bombshell Beans Mobile Coffee Truck on premise to provide coffee and tea with 1 barista operating the truck.

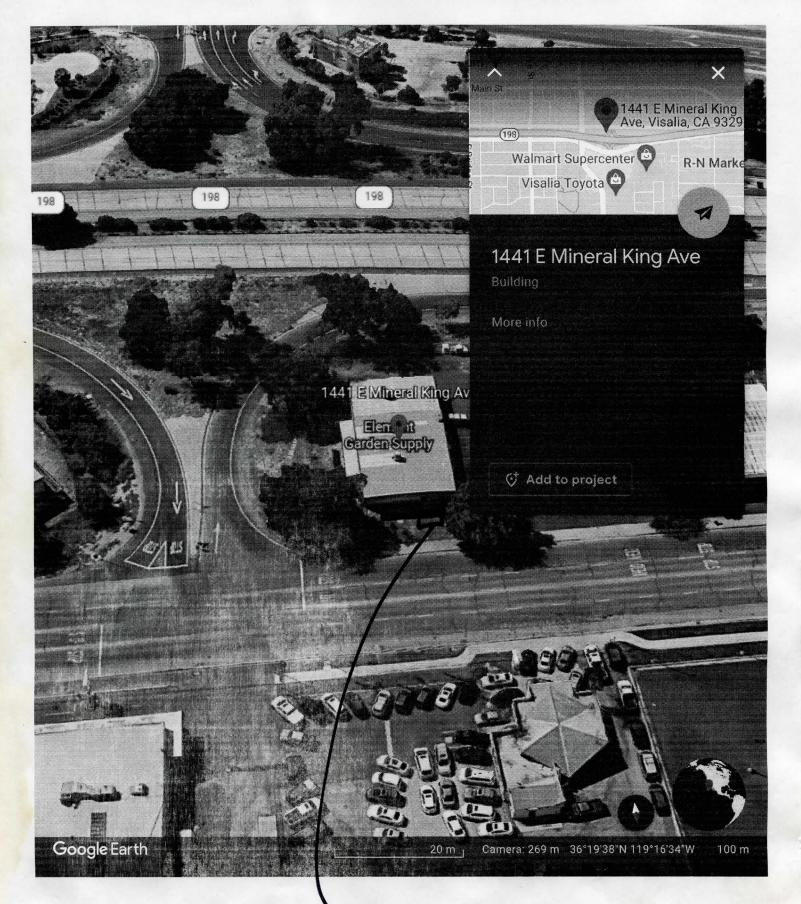

Sombshell Coffee Truck

CALIFORNIA ALL-PURPOSE ACKNOWLEDGMENT

A notary public or other officer completing this certificate verifies only the identity of the individual who signed the document to which this certificate is attached, and not the truthfulness, accuracy, or validity of that document.				
State of California County of Tulove On 3 6 2023 before me, Show Date RISTA RAG	Here Insert Name and Title of the Officer			
personally appeared	Name(s) of Signer(s)			
who proved to me on the basis of satisfactory ev subscribed to the within instrument and acknowled his her/their authorized capacity(ies), and that by his or the entity upon behalf of which the person(s) acted	ged to me that he/she/they executed the same in ter/their signature(s) on the instrument the person(s),			
I co	ertify under PENALTY OF PERJURY under the laws the State of California that the foregoing paragraph rue and correct.			
SHAUKAT N. LOKHANDWALA	nature Signature of Notary Public			
Place Notary Seal Above	DNAL -			
Though this section is optional, completing this inf fraudulent reattachment of this fo	formation can deter alteration of the document or rm to an unintended document.			
Description of Attached Document Title or Type of Document: Document Date: Signer(s) Other Than Named Above:	Authorization Number of Pages: (1)			
Capacity(ies) Claimed by Signer(s) Signer's Name:	Signer's Name:			
Signer's Name: ☐ Corporate Officer — Title(s):	☐ Corporate Officer — Title(s): ☐ Partner — ☐ Limited ☐ General ☐ Individual ☐ Attorney in Fact ☐ Trustee ☐ Guardian or Conservator ☐ Other:			
Signer Is Representing:	Signer Is Representing:			

Weification of Bostroom for Mobile Food Facility (MFF)	FA#
Verification of Restroom for Mobile Food Facility (MFF) Verificación de baños para instalaciones móviles de alimentos (MFF)	PR#
A Mobile Food Facility (MFF) shall be operating within 200 feet travel distance of an approved and readily available	e toilet and hand-washing facility sested. This form shall be

A Mobile Food Facility (MFF) shall be operating within 200 feet travel distance of an approved and readily available toilet and hand-washing facility when parked in any location for longer than one hour. (Chapter 10, Sec. 114315). Please provide all information requested. This form shall be completed and submitted for every location conducting business. NOTE: Porta-potties are not approved.

Completed and submitted for every location conducting business. NOTA: Los baños portátiles no están aprobados.

Este formulario debe completarse y enviarse para cada ubicación que realice no	Section 110 111. 200 banks p. 1
WELL Selection allow the marion de Monte	
MFF Name (DBA): Nombre de MFF (DBA) DIM DSHELL BEAUS	4 2 4 4 7 2 2 4 6
Address or Cross Street of Operation: Dirección o calles que cruzan de la operación Street Address	Dirección City City VISALA 95292 Zip Code Código postal
Hours of Operation: Horas de operación Am - Im	Days of Operation: 1/04-504
License Plate #: LUPADAY	
A RECORDED TO SERVED A MINIMARION (IN BURE) SPENOUS.	
Owner Name: Nombre del dueño STAHA MOHR	12100
Address of Owner: Dirección del dueño 15051 Att 1946 Street Address Dirección	City Cindad City
I have access to the restroom facilities at the following business during my business h I will be responsible for maintaining the restroom as listed below. Tengo access a los estacionado a menos de 200 pies de distancia de los baños. Seré responsable de maniente.	ours and I am parked less than 200 lect away from the trabajo y estoy s baños en el siguiente negocio durante mis horas de trabajo y estoy sener el baño como se indica a continuación.
Sm the	2/7/23 Date Fecha
Signature of MFF Operator Firma del operador MFF	
Respondentations and information de Ballo	D.
Business Name: Nombre del Negocio	Phone:
Owner Name: Nombre del dueño	19010
Address: Dirección 1441 E MINERAL KING	City Cindad 93494 Tip Code Código postal
Restroom Requirements: Requisitos de baños	Handwashing sink with hot and cold water Lavamanos con agua fria y caliente
Toilet facilities in good repair Baño el bueno estado/ higiénico Smooth cleanable surfaces	Paper towels in a dispenser Toallas de papel en un dispensador
superficies lisas que se pueden limpiar	Liquid soap in a dispenser
papel higienico en un dispensador Ventilation fan or openable window	Hours that restroom is available. Horas que el baño está disponible. ANET et my business and I understand that the restroom
Ventilation fan or openable window ventilador o ventinad abierta I, the business owner/operator, can and will provide restroom facilities for the operator facilities are subject to Environmental Health Department inspection. Yo, el propieta los operadores del MFF mencionado anteriormente en mi empresa y entiendo que las	ors of the above-mentioned MFF at tily obstites and t antologian that the visit rio/operador de la empresa, puedo y proporcionaré instalaciones sanitarias para instalaciones sanitarias están sujetas a la inspección del Departamento de Salud
Ambiental.	Date Fecha
Signature of Business Owner Firma del Propietario del negocio	
Approved by:	Date:

Temporary Conditional Use Permit for:

Operational Statement:

Days: Monday through Sunday (7 days a week)

Hours: 7am – 7pm

Bombshell Beans Mobile Coffee Truck on premise to provide coffee and tea with 1 barista operating the truck.



CITY OF VISALIA SITE PLAN REVIEW APPLICATION

Additional information and assistance in filling out this application can be found at the City of Visalia website (www.visalia.city) or by calling (559) 713-4440.



This application MUST be filled out in its entirety and submitted with an acceptable site plan (see site plan minimum requirements & submittal details on Page 2). Failure to provide all requested information may result in rejection of your application and exclusion from the Site Plan Review agenda.

Site Plan Review meetings are held on Wednesdays at 9:00 a.m. online utilizing Microsoft Teams. The applicant or representative must be present.

Application submittal deadline are Thursday at 4:00 p.m. to be scheduled for the next available meeting.

	Project/Business Name: MARKET, COFFEE & PASTRY DRIVE-THRU	Date: 04/05/2023							
7	Project Description: RETAIL SPACE FOR A SPECIALTY MARKET & A DRIVE-THRU COFFEE & PASTRY FACILITY								
GENERAL PROJECT INFORMATION	Site Plan Review Resubmittal: Yes No If Resubmittal, Previous Site Property Owner: SIEN Y. TAING	lan Review Number: 2021-155 Ref							
JECT	Applicant(s) Name: TAE ARCHITECTURE & PLANNING								
L PRC	Project Address/Location: 1526 N. DINUBA BLVD.								
GENERA	Assessor Parcel Number: 091-161-052, 047 & 009 Parcel Size (Acreage or Square Feet): 0.6 ACRES Building or Suite S	BUILDING "A": 1297 S.F. BUILDING "B": 3268 S.F.							
	Are There Any Proposed Building Modifications: Estimated Cost of Modifications to Building: Describe All Proposed Building Modifications: NEW RETAIL BUILDINGS Yes No No \$ 1.2 MILLION PROPOSAL IS TO CONSTRUCT TWO	THIS AREA FOR CITY STAFF USE ONLY Date Received: 04/06/2023 SPR Agenda: 04/19/2023 Item No Zone: C-N							
	A SEPARATE, DETAILED OPERATIONAL STATEMENT IS HIGHLY RECOM								
	Existing/Prior Building Use: SITE IS VACANT, LAST USE WAS RESIDENTIAL								
	Proposed Building Use: RETAIL STORE & COFFEE & PASTRY								
	Proposed Hours of Operation:								
& TRAFFIC INFORMATION	Days of Week In Operation (Circle): Su M T W Th F Sa SEE ATTAC Number of Employees Per Day: Existing Propose								
INFO	Number of Customers Per Day (Estimated): Existing Proposed								
AFFIC	Predicted Peak Operating Hour:								
	Describe Any Truck Delivery Schedule & Operations:								
OPERATIONS	Please Identify Any Unique or Specific Traffic Patterns That Will Require Accommodations For ((Provide Separate Attachment if Necessary): NONE	Operations, Customers, or Employees							
	Describe Any Special Events Planned for the Facility: N/A								
	Page 1 of 2 - Application continues on back of t	his page							

T							21	IE PLAN	MINIMUMI	REQUIREME	ENTS					
¢	Subm	nit a c	digital o	opy of t	ie site p	lan(s) and	complete	ed applica	tion on a flast	drive or equi	ivalent (PDF form	at prefer	red, hard	paper copi	98
	not at															
□	Digita	al cop	ies mu	st be cl	ar, legi	ble, and o	n a layout	sized app	ropriately to	convey all nec	essary p	oroject info	ormation			
₽	Siten	olan s	shall on	vide fo	and in	dicate all c	if the follo	winn:								
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N	ame:		TAE A	RCHIT	CTUP	E & PLA	NNING	(s	gnalure/o/ O	mer or Aulhou	nzed Ag	ent*				
A	ddress:	-		OX 117				- \	Mul				2	-6- 8	2023	
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PI	hone;	559	9.688.2	071				-								
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	own		Y. TAI	NG						ORIZATIO		n real proj	perty bea	aring asse	essor's	
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First Step Market

Hours:

8:00am - 9:00pm Mon - Sat

9:00am - 7:00pm Sun

First Step Market is a specialty produce market. We plan to sell staple foods and other cooking ingredients. Our focus will be on fresh produce, dairy products, grains, fresh meat/poultry, seasoning and to-go prepared food. No alcohol or tobacco.

The type of equipment used for this operation are produce stands/fridge, walkin in cooler with display swing doors, meat/poultry display case, grill top and cooktop combo, cook hood, mop sink, commercial sink, display rack and checkout registers.

We expect 75 customers a day. Peak hours from 4pm - 7pm. All customers will be walk-in with no delivery service.

Based on the customer count, we will have 2-3 employees throughout the day.

Vendor deliveries will be once a week.

The current use of the site was 2 residential homes and 1 1,500 sq ft candle store.

Ace Coffee & Pastry

Hours:

5:00am - 5:00pm Mon - Fri

5:00am - 5:00pm Sat

6:00am - 4:00pm Sun

Ace will serve hot & cold coffee in different blends. Ace will also serve fresh baked croissants in different varieties—including muffins and danish.


Equipment needed are ovens, cook hood, coffee brewers, blenders, prep-counter, mop sink, commercial sink, glass display cases and checkout counter.

Expected customer count is 100 a day. Peak hours from 6:00am - 11:00am.

Based on the customer count, we will have 2-3 employees throughout the day.

Vendor deliveries will be once a week.

The current use of the site was 2 residential homes and 1 1,500 sq ft candle store.

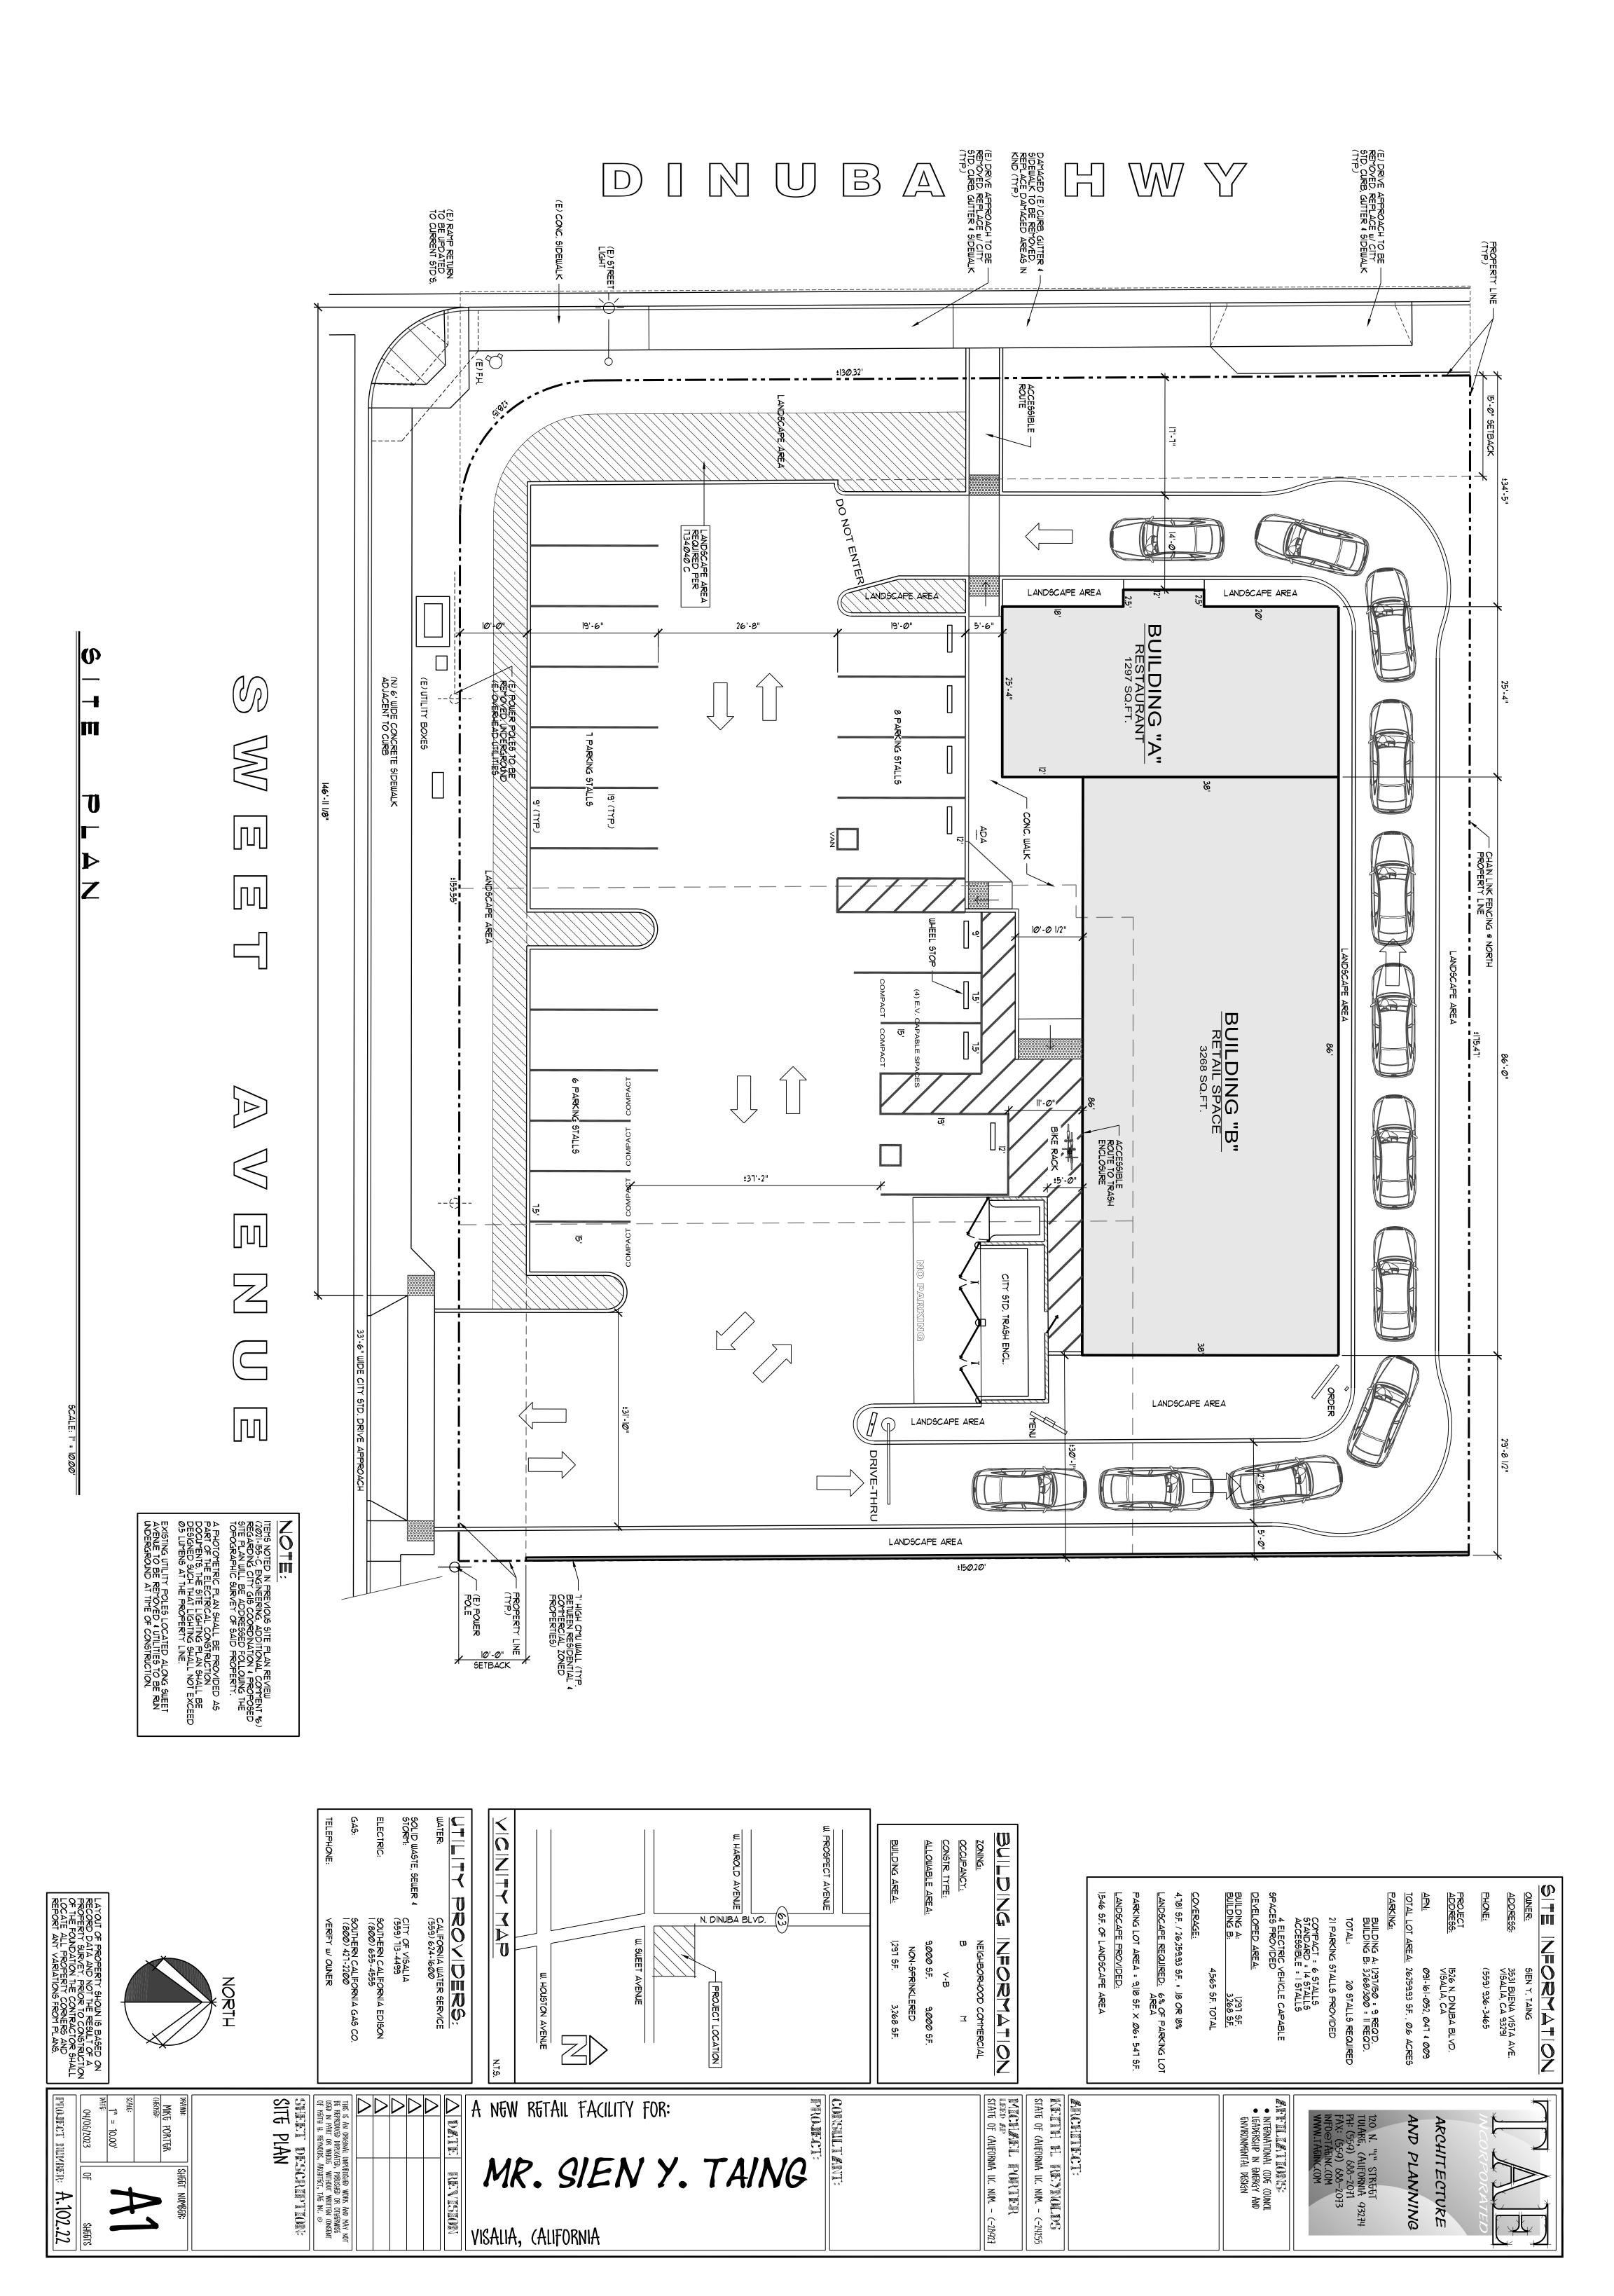



Technical Memorandum

September 21, 2022

То	Keith Reynolds, TAE	File Name	12590465-GHD-MEM-V002.DOCX				
Copy to		Email	Gary.Mills@ghd.com				
From	Gary Mills, Joe Ramirez	Project No.	12590465				
Project Name	Traffic Action Plan – N. Visalia Donut Shop						
Subject	Queueing Analysis						

1. Introduction

GHD has been obtained by TAE Architecture and Planning, Inc., to provide professional transportation planning and traffic engineering services for a proposed retail project in northern Visalia in Tulare County, California. Specifically, the project proposes a 1,330 square foot donut shop with a drive-thru and a 3,484 square foot retail pad and is located at the northeast corner of Sweet Avenue and Dinuba Boulevard (State Route 63). Currently, this lot is vacant.

1.1 Purpose of this Memorandum

The purpose of this memorandum is to analyze queueing that will result from this project, specifically related to the drive-thru donut shop. Prior to this memorandum, GHD prepared a technical memorandum related to project trip generation, which was used to determine incoming trips into the drive-thru lane. In summary, the proposed project is estimated to generate approximately 58 incoming vehicles and 56 outgoing vehicles during the AM peak hour period between 7:00 a.m. and 9:00 a.m.



1.2 Queueing Methodology

According to the ITE Manual of Transportation Engineering Studies, the macroscopic approach to measuring queues is to count the arrival and departure volumes for facility aggregated to five-minute intervals. The count should start before any queues are present and it should not end until the queues have all cleared. The difference between the cumulative five-minute arrivals and the five-minute departures is the number of vehicles in queue. The arrival data must be counted just upstream of the end of the longest expected queue.

The 2000 Highway Capacity Manual (HCM) defines a Queue as: "A line of vehicles, bicycles, or persons waiting to be served by the system in which the flow rate from the front of the queue determines the average speed within the queue. Slowly moving vehicles or people joining the rear of the queue are usually considered part of the queue. The internal queue dynamics can involve starts and stops. A faster-moving line of vehicles is often referred to as a moving queue or a platoon."

For purposes of this analysis, GHD used ITE trip generation numbers to estimate incoming and outgoing trips, as discussed above. To estimate the average queue length, GHD developed a spreadsheet

This Technical Memorandum is provided as an interim output under our agreement with TAE, Inc. It is provided to foster discussion in relation to technical matters associated with the project and should not be relied upon in any way.

12590465

simulation model for a single server queueing system (commonly referred to as M/M/1 queueing system). The spreadsheet inputs take into consideration the arrival rate (number of vehicles per hour) and average service time. The actual simulation model includes time (minutes 1 through 59), arrivals that observe Poisson distribution, service time that follows an exponential distribution, and number in the queue (whether the customer exited, the number in the queue at the previous minute, and if there is an arrival at this time). The simulation calculates the server time considering the following scenarios: 1) if the server is busy, 2) time remaining with customer, and 3) if customer exits. Finally, the outputs include arrivals, server utilization rate and average number in the queue.

1.3 Similar Sites in Visalia

GHD identified four (4) donut [doughnut] shops in Visalia that had drive-thru service, including:

- Dunkin' Donuts
- Scotty's Donuts (Walnut Avenue)
- Doughboy Donuts
- Scotty's Donuts (Houston Avenue)

Figures 1-4 identify photographs of the drive-thru locations that were taken on Friday, August 8, 2022. The weather this day was clear and Visalia Unified School District (VUSD) was in session (2nd day of school). Friday was chosen to capture workers who grab a box of donuts for the office or worksite. 7:00 a.m. to 8:00 a.m. was selected to capture any trips prior to the traditional 8:00 a.m. start time and fall within the adjacent street AM Peak Period (7:00 a.m. to 9:00 a.m.).

Based upon field visits, no queueing impacts were observed. In fact, a small sample of vehicles in drive-thru indicate that wait times range between 45 and 90 seconds. This is a result of pre-made donuts and coffee that are ready to go. Cash versus debit/credit card transactions generally do not result in additional delay, according to industry publications.

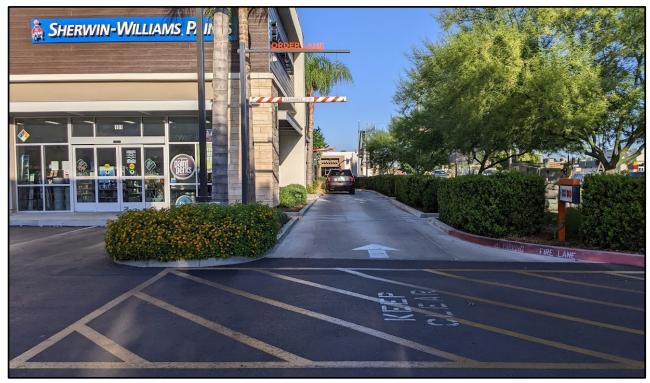


Figure 1 Dunkin' Donuts (Walnut/Mooney; Friday, August 8, 2022; 7:18 AM)



Figure 2 Scotty's Donuts (Walnut/Court; Friday, August 8, 2022; 7:23 AM)



Figure 3 Doughboy Donuts (Houston/Park; Friday, August 8, 2022; 7:32 AM)



Figure 4 Scotty's Donuts (Houston/Hall; Friday, August 8, 2022; 7:39 AM)

1.4 Queueing Analysis

Table 1 shows the queue length by service time. This was developed by using the spreadsheet simulation model as discuss in Section 1.2 (shown on following page). Note, the average vehicle length used was calculated in *SimTraffic*, which calculates the distance between vehicles to be 19.5 ft., whereas the average vehicle length is approximately 15 ft

Table 1 - Queue Length by Service Time

Service Time	1 Minute	1.5 Minutes	2 Minutes	2.5 Minutes	3.0 Minutes	3.5 Minutes	4 Minutes	4.5 Minutes
Average Queue Length	8.52	14.03	16.79	19.84	22.77	24.26	25.93	27.03
Vehide Queue (Feet)	166	274	327	387	444	473	506	527
Available Storage (Feet)	341	341	341	341	341	341	341	341

Based upon the site plan, there is approximately 341 ft of storage capacity. Using the *SimTraffic* average vehicle length of 19.5 ft, which is considered greater than the average car length of 15 ft., the storage capacity could accommodate 17 vehicles. As shown in Table 1, service times of 1 minute, 1.5 minutes and 2 minutes can accommodate the 341 ft of storage capacity per site plan. Waiting service time greater than 2.5 minutes would exceed storage capacity based upon assumptions used in this analysis.

1.5 Conclusions

Based upon the spreadsheet simulation model developed by GHD, if service wait times exceed 2.5 minutes, then the vehicle queue will exceed the available storage of 341 feet. This assumes that the ITE trip generation rate of approximately 1 vehicle per minute would enter the queue for the entire hour. Based upon field review of four (4) drive-thru local donut shops in Visalia, this demand [1 vehicle per minute] was not observed. Further, wait times for donut shops tend to be far less than typical drive-thru fast-food restaurants because the food is not made to order, i.e., donuts are already prepared, and your options are what is available. Short wait times at the local donut shops of less than 2 minutes were observed during the field review. As a result, **queueing impacts** at this donut shop will be **less than significant**.

Spreadsheet Simulation Model

	nput Variables (Green)			-				Simulation Results (Output)			
	rrival Rate		per hour	From Trip Gen.				Arrivals	59 per ho	ur	
	verage Service Time		minutes	Ind. Avg. or Survey				Server Utilization	100.00%		
S	ervice Rate	60	per hour					Average Number in the Queue	7.66		
								-			
						_					
_					_	Server					22.85
Day	Time (Minutes)	Random #	Arrival	Number in Queue	Busy	Time Left	Exit	Iterations - 1 minute	5.80	Iterations - 3 minutes	
1	0:00	0.966868098	0	0	0	0	0		6.10		21.85
1	0:01 0:02	0.282297339	1	1	1	3 2	0		9.60 8.74		18.72 17.98
- 1	0:02	0.102853132	1	2	1	1	1		5.59		19.25
- 1	0:03	0.476046627	1	2	1	1	1		12.56		22.11
- 1	0:05	0.90864218	1	2		1	1		9.16		22.28
- 1	0:08	0.784203181	1	2		1	1		4.92		23.66
- 1	0:07	0.175588866	1	2	1	- 1	1		6.89		20.46
- 1	0:08	0.894411863	i	2	1	3	ò		9.13		19.00
- 1	0:09	0.462999487	1	3	i i	2	ō		6.70		19.51
- 1	0:10	0.647562813	1	4	1	1	1	Total 10 Iterations	85.19	Total 10 Iterations	227.67
- 1	0:11	0.938375722	1	4	1	- 1	- 1	Avg. Queue Length	8.52	Avg. Queue Length	22.77
1	0:12	0.251877454	i	4	1	1	i	g. water tengel		ring. Queue Ecilytii	
1	0:13	0.825978026	1	4	1	1	1	Iterations - 1.5 minutes	12.10	Iterations - 3.5 minutes	24.43
1	0:14	0.282382972	1	4	i	i	1		6.65	The state of the s	20.89
- 1	0:15	0.678731587	1	4	1	1	i	1	13.80	1	25.25
1	0:16	0.196500961	1	4	1	i	i	1	13.89	1	19.36
- 1	0:17	0.794658305	1	4	1	1	1		11.90		20.69
- 1	0:18	0.544010975	1	4	1	3	ò		13.74		19.39
- 1	0:19	0.666881259	i	5	i	2	ŏ		16.05		22.62
- 1	0:20	0.614818097	1	6	1	1	1		11.03		23.77
- 1	0:21	0.536658442	1	6	i	1	- 1		14.97		22.10
1	0:22	0.705664322	1	6	1	1	1		13.70		21.93
- 1	0:23	0.426009518	1	6	1	1	1		12.51		22.13
- 1	0:24	0.646380901	1	6	i i	1	1	Total 10 Iterations	140.34	Total 10 Iterations	242.56
- 1	0:25	0.95499865	1	6	1	1	1	Avg. Queue Length	14.03	Avg. Queue Length	24.26
1	0:26	0.496219938	1	6	1	1	1				
1	0:27	0.468735674	1	6	1	1	1	Iterations - 2 minutes	14.70	Iterations - 4 minutes	23.13
1	0:28	0.435201738	1	6	1	1	1		16.75		23.05
1	0:29	0.66679431	1	6	1	1	1		15.20		25.31
1	0:30	0.231514411	1	6	1	1	1		16.79		24.18
1	0:31	0.896477858	1	6	1	2	0		11.41		26.30
1	0:32	0.392618408	1	7	1	1	1		14.28		22.70
1	0:33	0.786828809	1	7	1	1	1		17.79		25.44
1	0:34	0.613009284	1	7	1	1	1		13.74		20.39
1	0:35	0.360650976	1	7	1	2	0		13.28		21.49
1	0:36	0.447005094	1	8	1	1	1		16.67		24.87
1	0:37	0.44919488	1	8	1	1	1	1	17.28	1	22.48
1	0:38	0.814476423	1	8	1	2	Ó	Total 10 Iterations	167.89	Total 10 Iterations	259.34
1	0:39	0.21915491	1	9	1	1	1	Avg. Queue Length	16.79	Avg. Queue Length	25.93
1	0:40	0.503172874	1	9	1	1	1				
1	0:41	0.330393081	1	9	1	1	1	Iterations - 2.5 minutes	19.89	Iterations - 4.5 minutes	25.70
1	0:42	0.342062862	1	9	1	2	Ó		15.48		22.92
1	0:43	0.260885431	1	10	1	1	1	1	18.84	1	25.61
1	0:44	0.607280994	1	10	1	1	1	1	18.08	1	24.10
1	0:45	0.214101726	1	10	1	7	0	1	17.16	1	25.80
1	0:46	0.727085767	1	11	1	6	Ō	1	18.02	1	26.33
1	0:47	0.366697239	1	12	1	5	Ō	1	18.18	1	23.00
1	0:48	0.852828392	1	13	1	4	0	1	19.00	1	26.05
1	0:49	0.392730215	1	14	1	3	0		18.18		23.41
1	0:50	0.993720633	0	14	1	2	0	1	19.10	1	22.61
1	0:51	0.587166498	1	15	1	1	1	1	16.48	1	24.74
1	0:52	0.848014256	1	15	1	1	1	Total 10 Iterations	198.41	Total 10 Iterations	270.27
1	0:53	0.117582358	1	15	1	1	1	Avg. Queue Length	19.84	Avg. Queue Length	27.03
1	0:54	0.553206362	1	15	1	1	1				
1	0:55	0.552335162	1	15	1	1	1	1			
1	0:56	0.908150506	1	15	1	2	0	1			
1	0:57	0.181096895	1	16	1	1	1	1			
1	0:58	0.810216353	1	16	1	2	0	1			
1	0:59	0.920294346	1	17	1	1	1	1			
1	1:00	0.519804163	1	17	1	1	1	I			

CITY OF VISALIA SITE PLAN REVIEW APPLICATION

- Additional information and assistance in filling out this application can be found at the City of Visalia website (www.visalia.city) or by calling (559) 713-4440-




This application MUST be filled out in its entirety and submitted with an acceptable site plan (see site plan minimum requirement details below). Failure to provide all requested information may result in rejection of your application and exclusion from the Site Plan Review agenda.

- Site Plan Review meetings are held on Wednesdays at 9am at City Hall East - 315 E Acequia Ave - Applicant(s) or Representative(s) must be present -

Application submittal deadline is 4pm on Thursdays to be scheduled for the next available meeting

- Application submittal deadline is 4pm on Thursdays to be scheduled for the flext available meeting -							
Project/Business Name:	GAS STATION	N AT 100 W. MI	NERAL KING	3 AVE.	Date:	11/20/2020	
	A NEW 3,380 SQ.FT. 1,200 SF) AND AN EX						QSR
Site Plan Review Resub	omittal: Yes No) If Resubr	nittal, Previous S	Site Plan Re	view Number:	2021-009 Ref	
Property Owner:	PARMINDER SINGH				•		
Applicant(s) Name:	PARMINDER SINGH	1					
– Project Address/Locatio	n: 100 W. MIN	ERAL KING AVE.					
Assessor Parcel Number	313 er: <u>094-X½0×010</u>	•					
Parcel Size (Acreage or	Square Feet): 0.4 AC	,	Building or Su	ite Square	Footage: S	EE PROJECT DESC	RIP.
Are There Any Propose	d Building Modifications:	Yes No 🚫		4-7-6	- THIS AREA I	FOR CITY STAFF USE ON	 LY
Estimated Cost of Modif	fications to Building:	N/A		Dat	e Received: 0	4/10/2023	<u> </u>
Describe All Proposed E	Building Modifications:	 N/A		- SPI	R Agenda: <u>04</u>	/19/2023 Item No	
				– Zor	ne: <u>D-MU</u>	SPR No. 23-60	
				– Hist	toric District:	Yes O No (<u>X</u>)
				 Floo	od Zone:	X ⋘ AE ◯ X/AE	0
Existing/Prior Building Proposed Building Use		pe building to	operate gas			JONNITTALS	
Proposed Hours of Op	eration: 6am to 11pr	<u>n</u>					
Days of Week In Opera	tion (Circle): Su M (_				
Number of Employees F	Per Day:	Existing3	Pro	posed	15		
Number of Customers F	Per Day (Estimated):	Existing1	00 Pro	posed	400		
Predicted Peak Operation	ng Hour:	8am to 8p	<u>om</u>				
Describe Any Truck Del	ivery Schedule & Operations:	Grocery del	iveries thru n	nedium-c	duty trucks.	Delivery times mos	tly_
in the am.							
Please Identify Any Unio	que or Specific Traffic Pattern	s That Will Require A	Accommodations	For Opera	tions, Custome	rs, or Employees	
(Provide Separate Attac	chment if Necessary): No	such accommo	odations are	reguired			
Describe Any Special E	vents Planned for the Facility:	No specia	l events plar	nned			
		Page 1 of 2 - Application	n continues on bac	ck of this pag	ne T		

## Plans (a) must be clear, legible, and on a sheet size appropriate to easily convey all necessary project information. Suggested minimum sheet size for site plans is 11'x1''' ("Caudies tendrive parcel and final maps) ## Site plans is plans is 11'x1''' ("Caudies tendrive parcel and final maps) ## Site plans is plans is 11'x1''' ("Caudies tendrive parcel and final maps) ## Site plans the provide for and indicate all of the following: - North arrow - All existing & proposed site features - Site demensions, including building - Refuse enclosures & containers - Accessible path of fravel from right of way. - Accessible path of fravel from right of way. - Accessible path of fravel from right of way. - Accessible path of fravel from right of way. - Accessible path of fravel from right of way. - Accessible path of fravel from right of way. - Accessible path of fravel from right of way. - Accessible path of fravel from right of way. - Accessible path of fravel from right of way. - Accessible path of fravel from right of way. - Accessible path of fravel from right of way. - Accessible path of fravel from right of way. - Accessible path of fravel from right of way. - Accessible path of fravel from right of way. - Accessible path of fravel from right of way. - Accessible path of fravel from right of way. - Accessible path of fravel from right of way. - Accessible path of fravel from right fravel from right of way. - Accessible path of fravel from right of way. - Accessible path of fravel from right fravel fravel fravel fravel fravel frave		SITE PLAN MINIMUM REQUIREMENTS						
## WOUNDER:		Plan(s) must be clear, legible, and on a sheet size appropriate to easily convey all necessary project information. Suggested minimum						
Utility poles, hydrants, street lights, etc.) - Parking stals (include ADA) of Visalia Municipal Code Section 16 ⇒ Submit 20 copies of the site plan with this application, folded to a legal size of 9" x 12" with the print on the outside (no rolled plans) Applicant Information (Final comments will be mailed to the name and address provided below) Name: Parminder Singh Name: Parminder Singh Name: 100 W. Mineral King Ave. City, State, Zip Visalia, Ca. 93291 Phone: 550-392-5045 Emai: visaliagasino@gmail.com Authorized Agent* Date Authorized Agent* Owner AGENCY AUTHORIZATION OWNER:	NTS	sheet size for site plans is 11"x17" (Excludes tentative parcel and final maps)						
Name: Parminder Singh Address: 100 W. Mineral King Ave. City, State, Zip Visalia, Ca, 93291 Phone: 550-392-5045 Email: visaliagasinc@gmail.com *If signed by an authorized agent, the "Agency Authorization" information below must be completed for this application to be considered acceptable. AGENCY AUTHORIZATION OWNER: I,	SITE PLAN REQUIREME	 North arrow All existing & proposed site features Site dimensions, including building Existing and proposed fencing at site Public improvements (curbs, sidewalks, utility poles, hydrants, street lights, etc.) Existing & proposed structures Adjacent street names Refuse enclosures & containers Valley oak trees (show drip line) Location and width of drive approaches to site Tentative maps shall adhere to requirements of Visalia Municipal Code Section 16 						
Name: Parminder Singh Address: 100 W. Mineral King Ave. City, State, Zip Visalia, Ca, 93291 Phone: 550-392-5045 Email: visaliagasinc@gmail.com *If signed by an authorized agent the "Agency Authorization" information below must be completed for this application to be considered acceptable. AGENCY AUTHORIZATION OWNER: I,		Applicant Information (Final comments will be mailed to the name and address provided below)						
AGENCY AUTHORIZATION OWNER:	QUIRED SIGNATURE >	Name: Parminder Singh Address: 100 W. Mineral King Ave. City, State, Zip Visalia, Ca. 93291 Phone: 550-392-5045 Authorized Agent* Owner Owner or Authorized Agent* Date						
OWNER:	RE							
OWNER: ,		* If signed by an authorized agent , the "Agency Authorization" information below must be completed for this application to be considered acceptable.						
I designate		I,, declare as follows; I am the owner of certain real property bearing assessor's						
I declare under penalty of perjury the foregoing is true and correct. Executed this day of, 20 OWNER)RM	l designate, to act as my duly authorized agent for all purposes necessary to file an application for, and obtain a permit to						
Signature of Owner Owner Mailing Address Agent Mailing Address Owner Phone Number Agent Phone Number	N F	relative to the property mentioned herein.						
Signature of Owner Owner Mailing Address Agent Mailing Address Owner Phone Number Agent Phone Number	Y AUTHORIZATIC	Executed this day of, 20						
Owner Mailing Address Agent Mailing Address Owner Phone Number Agent Phone Number	AGENC	OWNER AGENT						
Owner Phone Number Agent Phone Number		Signature of Owner Signature of Agent						
		Owner Mailing Address Agent Mailing Address						
Page 2 of 2		Owner Phone Number Agent Phone Number						
I AUC E VI E		Page 2 of 2						

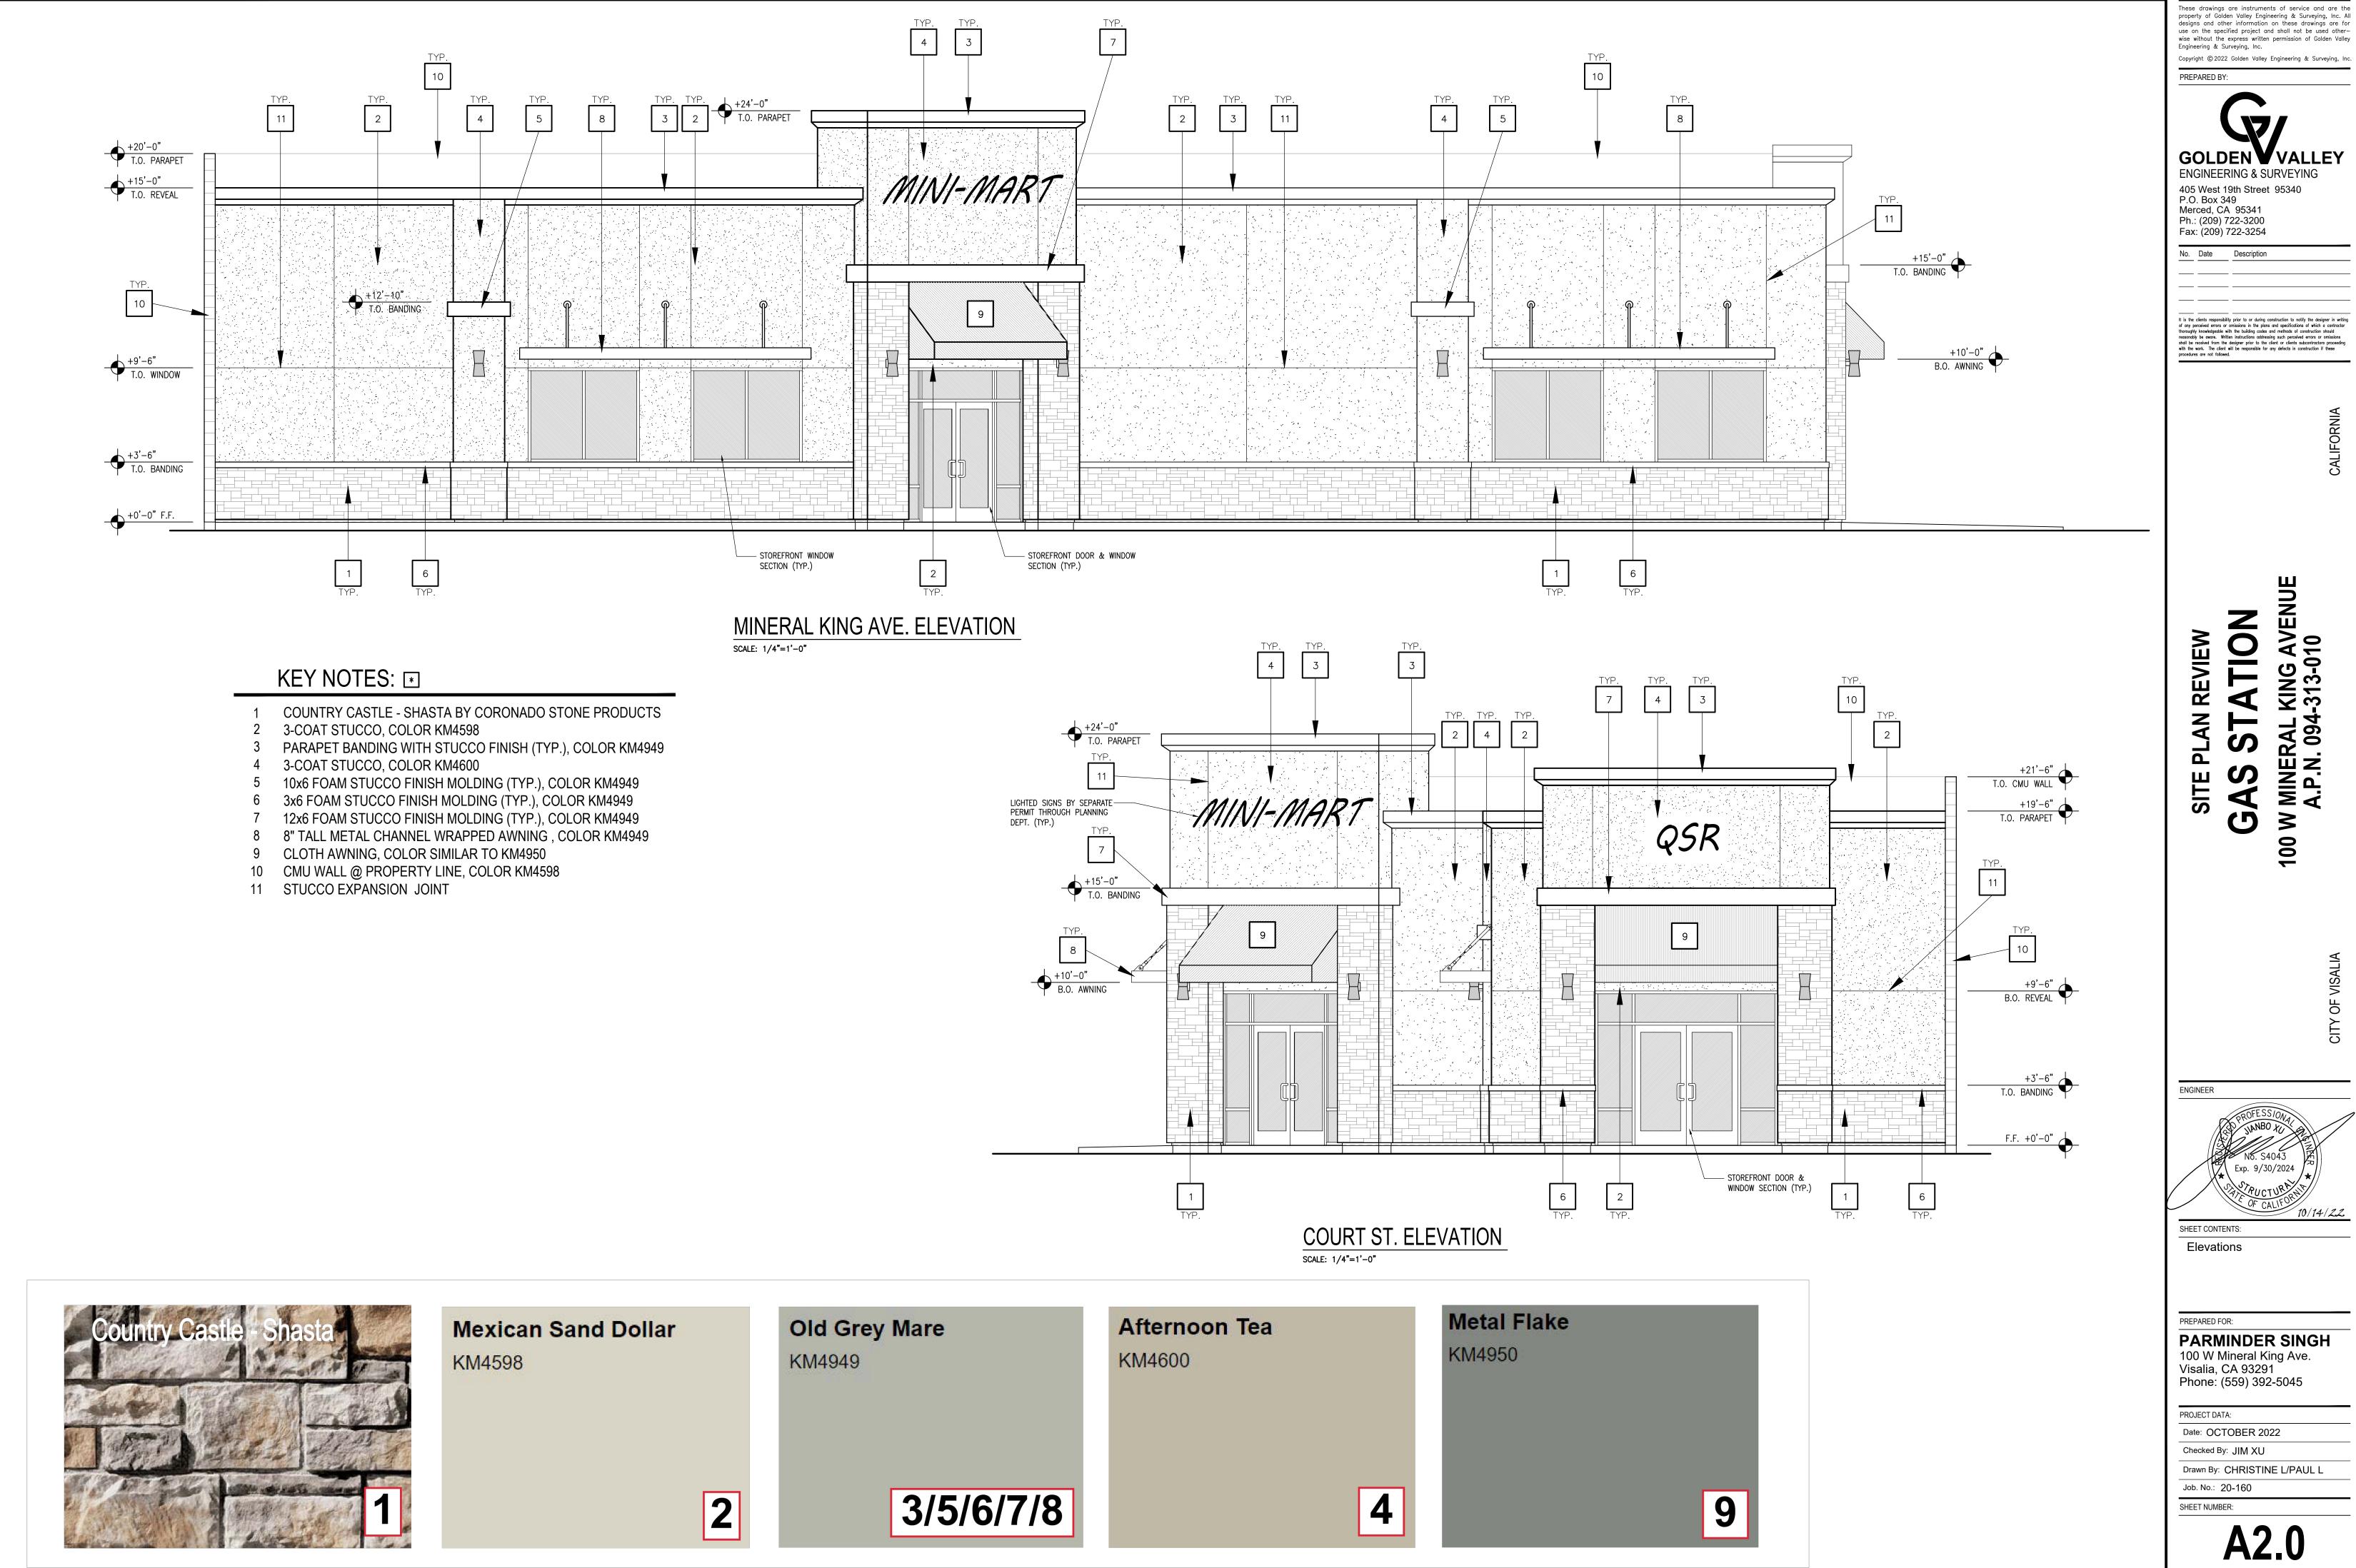

ATION

Date: OCTOBER 2022 Checked By: JIM XU

Drawn By: CHRISTINE L/PAUL L

Job. No.: 20-160

A2.0

Operational Statement

Project Description: A NEW 3,380 SQ.FT. RETAIL BLDG. 2180 SF FOR MINI-MART AND 1 QSR 1200SF.

PROPOSED DESCRIPTION: Existing gasoline station with 4MPD will have 2180 sq.ft. Convenience store. Business will be under the name of Mineral King Mart & Gas. Type of products sold inside store are Ice Cream, Dairy products. Non-Alcoholic Beverages. Fountain drinks. Toiletries and hygiene products, Packaged Snacks and Candy. Lottery Tickets. Tobacco Products. Over the counter medicines. Gas and Automotive supplies.

Deliveries and Storage: Business has 3 Underground storage tanks for unleaded gasoline. Two tanks are 12,000gallons and one is 10,000gallons. Unleaded gasoline is delivered by Red triangle fuel company once a week. Delivery hours vary but mostly it is after hours. Inside store products and inventory will be delivered by the companies like Pepsi, Coke, Frito lay, Coremark. Each company unloads products at designated un-loading area. There is no dock requirement. Product is moved on Hand trucks inside the building. No street traffic will be impacted during deliveries. All the products delivered goes on shelves and rest will be stored in designated storage inside building.

Operation Hours: Business hours for customers shopping inside the store are 5am to 11pm, for all seven days in a week. Gasoline pumps under canopy are available 24/7 for costumers use. Number of customers fueling and shopping inside the store will be approximately 300 to 400 per day.


Employees: Business plan is to hire 6-8 employees to manage daily operations. Currently business has 3 full time employees.

Equipment: Equipment used for daily business needs are HVAC, Walk in cooler compressors. And other merchandize freezer. None of this equipment generate noise above existing level in the area.

Security: Business will have high-definition security system which will be operating 24/7 monitoring surveillance system.

Applicant's Signature

for S

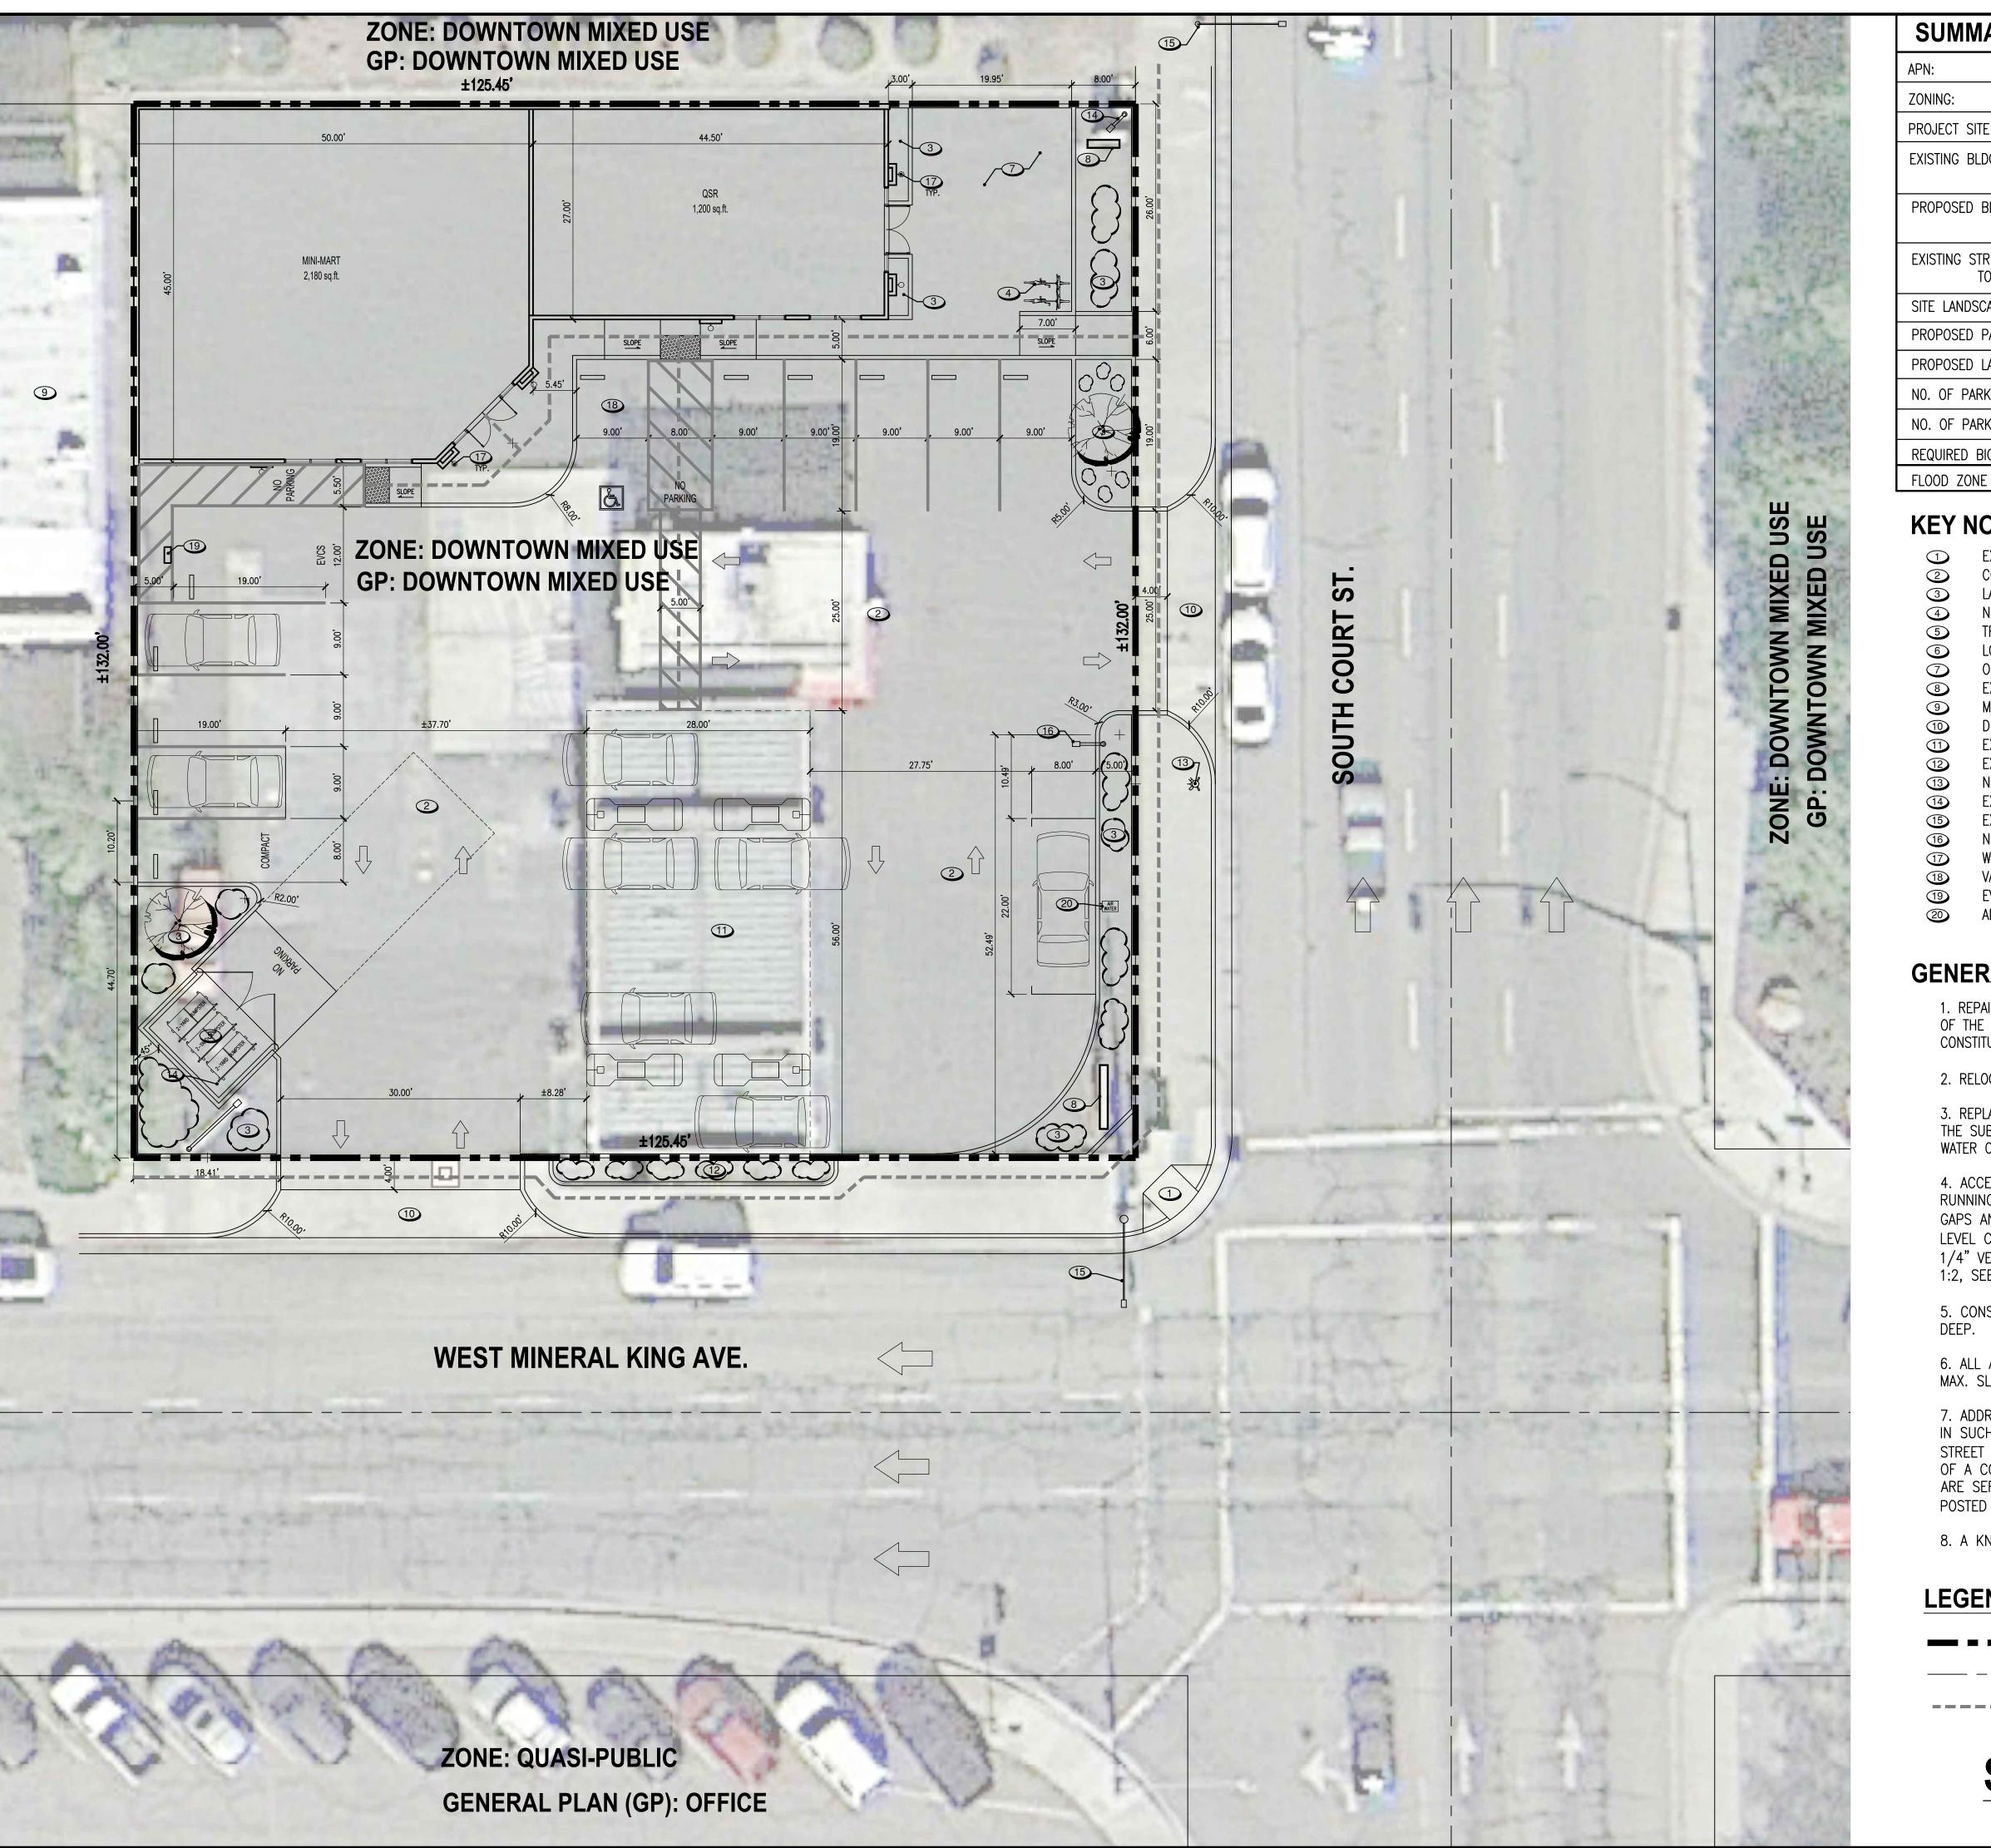

SUMMARY TABLE			
APN:	094-310-010		
ZONING:	D-MU (MIXED USE DOWNTOWN ZONE)		
PROJECT SITE AREA:	16,552 SQ.FT.		
EXISTING BLDG. AREA:	EXISTING 500 SQ.FT. MINI-MART TO BE DEMOLISHED. EXISTING GAS PUMP ISLAND & CANOPY WILL REMAIN		
PROPOSED BLDG. AREA:	MINI-MART 2,180 SQ.FT. (2,180/300 =7 PARKING QSR: 1,200/150 = 8 PARKING)		
EXISTING STRUCTURE: TOTAL AREA:	GAS STATION: 1,568 SQ.FT. (4 PUMPS) 5,568 SQ.FT.		
SITE LANDSCAPING AREA:	965 SQ.FT. 965/16,552=5.8%		
PROPOSED PARKING AREA:	2,040 SQ.FT.		
PROPOSED LANDSCAPING AT PARKING AREA:	232 (232/1420=11%>6% OK)		
NO. OF PARKING REQ'D	13		
NO. OF PARKING PROVIDED:	11 (INCL. 1 EVCS & 1 VAN ACCESSIBLE)		
REQUIRED BICYCLE PARKING	13x0.05=1		
EL 0.0D 70.NE	n ₁ , n		

KEY NOTE:

EXISTING CURB RETURN WITH RAMP. CONCRETE PAVEMENT PER SOILS REPORT, SEE CIVIL PLANS

LANDSCAPING AREA WITH CURBING

NEW DBL. BIKE RACK

TRASH ENCLOSURE w/SOLID SCREENING GATE PER CITY STANDARD

LOADING AREA

OUTDOOR SEATING AREA

EXISTING MONUMENT SIGN

MASONIC TEMPLE, TO BE PROTECTED DURING CONSTRUCTION

DRIVEWAY PER CALTRANS AND CITY STANDARDS

EXISTING GAS PUMP CANOPY TO REMAIN

EXISTING LANDSCAPING PLANTER TO BE REPAIRED AND PROTECTED

NEW FIRE HYDRANT, LOCATION TO BE APPROVED BY FIRE DEPARTMENT EXISTING PARKING LOT LIGHT TO REMAIN

EXISTING STREET LIGHT TO REMAIN

NEW POLE LIGHT

WALL MOUNTED BUILDING LIGHT

18 VAN ACCESSIBLE PARKING STALL & ACCESS AISLE w/CURB RAMP

EV CHARGING STALL

AIR & WATER DISPENSER

GENERAL NOTES:

1. REPAIR AND/OR REPLACE ANY SIDEWALK ACROSS THE PUBLIC STREET FRONTAGES OF THE SUBJECT SITE THAT HAS BECOME UNEVEN, CRACKED OR DAMAGED AND MAY CONSTITUTE A TRIPPING HAZARD.

2. RELOCATE AFFECTED EXISTING UTILITY POLES AND/OR FACILITIES.

3. REPLACE ANY CURB AND GUTTER ACROSS THE PUBLIC STREET FRONTAGES OF THE SUBJECT SITE THAT HAS BECOME UNEVEN AND HAS CREATED AREAS WHERE WATER CAN STAND.

4. ACCESSIBLE ROUTE SHALL HAVE 2% MAX. CROSS SLOPE AND 5% MAX. RUNNING SLOPE. IT SHALL BE STABLE, FIRM AND SLIP-RESISTANT; FREE OF GAPS AND CRACKS THAT ARE GREATER THAN 1/2" WIDE AND 1/4" DEEP; NO LEVEL CHANGE SHALL BE GREATER THAN 1/2" LEVEL CHANGE GREATER THAN 1/4" VERTICAL AND 1/2" BEVELED SHOULD HAVE A SLOPE NO GREATER THAN 1:2, SEE DETAIL 8 ON SHT. ADA-1.

5. CONSTRUCTION JOINT SHOULD BE NO GREATER THAN 1/2" WIDE AND 1/4"

6. ALL ACCESSIBLE ROUTE, INTERSECTIONS AND LANDINGS SHOULD HAVE 2% MAX. SLOPE IN ALL DIRECTIONS

7. ADDRESS NUMBERS MUST BE PLACED ON THE EXTERIOR OF THE BUILDING IN SUCH A POSITION AS TO BE CLEARLY AND PLAINLY VISIBLE FROM THE STREET NUMBERS WILL BE AT LEAST FOUR INCHES (4") HIGH AND SHALL BE OF A COLOR TO CONTRAST WITH THEIR BACKGROUND. IF MULTIPLE ADDRESSES ARE SERVED BY A COMMON DRIVEWAY, THE RANGE OF NUMBERS SHALL BE POSTED AT THE ROADWAY/DRIVEWAY.

8. A KNOX BOX KEY LOCK SYSTEM IS REQUIRED.

LEGEND

PROPERTY LINE

ROAD CENTER LINE

---- ACCESSIBLE WALK, SEE GENERAL NOTES #1, 4, 5 & 6





designs and other information on these drawings are for Engineering & Surveying, Inc.

PREPARED BY:

use on the specified project and shall not be used otherwise without the express written permission of Golden Valley Copyright © 2022 Golden Valley Engineering & Surveying, Inc

ENGINEERING & SURVEYING 405 West 19th Street 95340 P.O. Box 349 Merced, CA 95341

Ph.: (209) 722-3200 Fax: (209) 722-3254 No. Date Description

It is the clients responsibility prior to or during construction to notify the designer in writing It is the clients reported errors or omissions in the plans and specifications of which a contractor thoroughly knowledgeable with the building codes and methods of construction should reasonably be aware. Written instructions addressing such perceived errors or omissions shall be received from the designer prior to the client or clients subcontractors proceeding with the work. The client will be responsible for any defects in construction if these procedures are not followed.

ENGINEER SHEET CONTENTS:

PREPARED FOR:

PARMINDER SINGH

100 W Mineral King Ave. Visalia, CA 93291 Phone: (559) 392-5045

PROJECT DATA:

Date: OCTOBER 2022

Checked By: JIM XU Drawn By: PAUL L

Job. No.: 20-160 SHEET NUMBER:

CITY OF VISALIA SITE PLAN REVIEW APPLICATION

- Additional information and assistance in filling out this application can be found at the City of Visalia website (www.visalia.city) or by calling (559) 713-4440-

NISALIA

This application MUST be filled out in its entirety and submitted with an acceptable site plan (see site plan minimum requirements & submittal details on Page 2). Failure to provide all requested information may result in rejection of your application and exclusion from the Site Plan Review agenda.

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- Site Plan Review meetings are held on Wednesdays at 9am at City Hall East - 315 E Acequia Ave - Applicant(s) or Representative(s) must be pre-							
- Application submittal deadline is 4pm on Thursdays to be scheduled for the next available meeting -							
Project/Business Name: Lady's Chicken and Rice	Date: 7-18-2022						
Project Description:							
Site Plan Review Resubmittal: Yes No If Resubmittal, Previou Property Owner: Brand new 1597 sf drive-thru and walk-up resta	us Site Plan Review Number: Ref: 22-124 R&P						
	urant with new parking lot/layout						
Applicant(s) Name: Alex Ceballos (AGD, Inc.)							
Applicant(s) Name: Alex Ceballos (AGD, Inc.) Project Address/Location: 519 E Houston Ave. Visalia Ca. 9 Assessor Parcel Number: 0 9 4 - 1 3 0 - 0 4 9 Parcel Size (Acreage or Square Foot): Publishers	3292						
Assessor Parcel Number: <u>0 9 4 - 1 3 0 - 0 4 9</u>							
Parcel Size (Acreage or Square Feet): Building or	Suite Square Footage: 1597 sf						
Are There Any Proposed Building Modifications: Yes No	THIS AREA FOR CITY STAFF USE ONLY -						
Estimated Cost of Modifications to Building: \$450,000	Date Received: 04/11/2023						
Describe All Proposed Building Modifications: Brand new, ground up	SPR Agenda: 04/19/2023 Item No						
Brand new 1597 sf drive-thru and walk-up restaurant with new	Zone: <u>C-MU</u> SPR No. 23-061						
parking lot/layout and new landscape.	Historic District: Yes No						
	Flood Zone: X AE X/AE						
A SEPARATE, DETAILED OPERATIONAL STATEMENT IS HIGHLY	RECOMMENDED FOR ALL SUBMITTALS						
Existing/Prior Building Use: Vacant land							
Proposed Building Use: Drive-thru and walk-up restaurant							
Proposed Hours of Operation: 10am to 5pm							
Days of Week In Operation (Circle): Su M T W Th F Sa							
Number of Employees Per Day: Existing	Proposed 3-5						
Number of Customers Per Day (Estimated): Existing	Proposed 100-200						
Predicted Peak Operating Hour:							
Describe Any Truck Delivery Schedule & Operations:							
Please Identify Any Unique or Specific Traffic Patterns That Will Require Accommodation	ons For Operations, Customers, or Employees						
(Provide Separate Attachment if Necessary):							
Describe Any Special Events Planned for the Facility:							
Page 1 of 2 - Application continues on the	back of this page						

	SITE PLAN MINIMUM REQUIREMENTS						
Submit a digital copy of the site plan(s) and completed application on a flash drive or equivalent (PDF format preferred, hard p							
SITE PLAN REQUIREMENTS	Digital copies must be clear, legible, and on a layout sized appropriately to convey all necessary project information.						
S S	Site plan shall provide for and indicate all of the following:						
N RE	- North arrow - Existing & proposed structures - Loading/unloading areas						
PLA	- All existing & proposed site features - Adjacent street names - Accessible path of travel from right of way						
SITE	 Site dimensions, including building Refuse enclosures & containers Accessible path of travel from ADA stall Existing and proposed fencing at site Valley oak trees (show drip line) Location and width of drive approaches to site 						
	- Public improvements (curbs, sidewalks, - Existing & proposed landscaping - Tentative maps shall adhere to requirements						
	utility poles, hydrants, street lights, etc.) - Parking stalls (include ADA) of Visalia Municipal Code Section 16						
	Applicant Information (Final comments will be mailed to the name and address provided below)						
JRE	Name: Bounleuk And Jimmy Thongseng Signature of Owner or Authorized Agent*						
VAT	Address: 519 E Houston Ave. — Authentision 07/18/2022						
SIG	City State Zin Visalia CA 93292 Ownstimmy Thongseng Date						
RED	Phone: 559-471-9084						
REQUIRED SIGNATURE	Email: visaliachickenandrice@gmail.com Autho idate General Date						
R	* If signed by an authorized agent , the "Agency Authorization" information below must be completed for this application to be considered acceptable.						
	AGENCY AUTHORIZATION						
	OWNER:						
	I, Bounleuk And Jimmy Thongseng declare as follows; I am the owner of certain real property bearing assessor's						
	parcel number (APN):						
	094-130-049-000						
	AGENT:						
	I designate Alex Ceballos (AGD, Inc.) , to act as my duly authorized agent for all purposes necessary to file						
FORM	an application for, and obtain a permit to SRP and building permit						
	relative to the property mentioned herein.						
ATIO	I declare under penalty of perjury the foregoing is true and correct.						
ORIZ	50000000 Abis 18 dougle July 2022						
UTH	Executed this 18 day of July , 2022 .						
I declare under penalty of perjury the foregoing is true and correct. Executed this 18 day of July , 2022. OWNER Signatures AGENT							
AGE							
	Authentisign Signatu Junion Signatu le GASCA: Cebullus						
	Signature the difference in the state of the						
	Owner Mailing Address Agent Mailing Address						
	559-471-9084 559-359-8789 Owner Phone Number Agent Phone Number						
	Agent Fluite Number						
	Page 2 of 2						

LADY'S CHICKEN AND RICE

131 W ORANGE AVE. PORTERVILLE, CA. 93257 APN: 094-130-049

A/C	AIR CONDITIONER	INT	INTERIOR
AFCI	ARC FAULT INTERRUPTER	ID.	IIINOTION BOY
A/A A.H.	ATTIC ACCESS ARCHED HEAD	JB	JUNCTION BOX
		LED	LIGHT EMITTING DIODE
В	BASE	LIT	LIGHT
BTU	BRITISH THERMAL UNIT	LS	LEFT SLIDER
B.O. B/W	BOX ONLY NO WIRING BOX AND WIRING	NFVA	NET FREE VENT AREA
C-CLG	CEILING OR CEILINGS	MD	MAN DOOR
CNC	CONCRETE	MES	MAIN ELECTRICAL SERVICE
CNC LND	CONCRETE LANDING	MGS	MAIN GAS SERVICE
CLO	CLOSET DACK SHELF & DOD	MWS M.O.	MAIN WATER SERVICE MICROWAVE OVEN
CLOS COMP	CLOSET PACK, SHELF & ROD COMPOSITION SHINGLES	IVI.O.	WICKOWAVE OVEN
CM	CARBON MONOXIDE ALARM	ОН	OVER HEAD
CU	CONDENSING UNIT	O.H.	OVERHANG
CT	COOKTOP	O/CLG	OPEN CEILING
CFH	CUBIC FEET PER HOUR	O.P.	ORANGE PEEL
COL	COLUMN	O.S.	OCCUPANCY SENSOR
СВ	COLUMN BASE		
CC	COLUMN CAP	PHEV	PLUG-IN HYBRID ELECTRIC
C/D	CLOTHES DRYER		VEHICLE
Ъ	DIMMER SWITCH	RS	RIGHT SLIDER
D D.F.	DOUGLAS FIR	RCSF	RECESSED SHOWER FLOOR
DISC	DISCONNECT	R.C.	RIDGE CAP
D/W	DISHWASHER		
DOR, DOP	DOOR,	SL	SLIDER
DORT	DOOR OPENING, DOOR TRIM	SLD	SLIDING DOOR
		SH	SINGLE HUNG
E.A.	EACH	SD	SMOKE ALARM
E.W.	EACH WAY	S&P	SHELF AND POLE
EVC	ELECTRIC VEHICLE CAPABLE	STUD4	INTERIOR 2X4 WALL
EAO	EAVE OUTLET	STU STU4	STUCCO EXTERIOR 2X4 WALL
EAV	EAVE VENT	STU6	EXTERIOR 2X4 WALL EXTERIOR 2X6 WALL
EQ EV	EQUAL ELECTRIC VEHICLE	SD	SMOKE DETECTOR
LV	ELECTRIC VEHICLE	SDG	SIDING
F.F.	FINISH FLOOR ELEVATION	SV	SOFFIT VENT
F.O.W.	FACE OF WALL		
F.O.S.	FACE OF STUD	TEMP	TEMPERED GLASS
FAU	FORCED AIR UNIT		
F.P.	FIBER GLASS	T	TILE
FL	FLUORESCENT	TM	TRIM
FN	FAN	TR TN	TAMPER RESISTANT TOP NAIL, TOE NAIL
FNL	FAN WITH LIGHT	IN	TOP NAIL, TOE NAIL
FX FO	FIXED GLASS FLOOR OUTLET	UG	UNDER GROUND
FC	FIBER CEMENT		
FTG	FOOTING	V	VAULTED
FRND	FRENCH DOOR	V.S.	VACANCY SENSOR
F.Q.	FLAT HEAD	VTR, VTO	VENTS TO ROOF,
CD A A	CAC DANCE AND MUSTU		VENTS TO OUT
GR 0-0 GDO	GAS RANGE AND WIDTH GARAGE DOOR OPENER	W	WALL OR WALLS
GFCI	GROUND FAULT INTERRUPTER	W.C.	WALLS AND CEILINGS
GV	GABLE VENT	W/H	WATER HEATER
GD	GARBAGE DISPOSER	C/W	WASHER
-	· ·	WO	WALL OVEN
H.H.	HEADER HEIGHT	WP	WATER PROOF COVER
H	HOOD	v	EVTERIOR
H.F.	HEM FIR	X +18"	EXTERIOR DISTANCE ABOVE FLOOR
HT	HAND TEXTURE	. 10	DISTANCE ABOVE FLOOR
HB	HOSE BIB HEATING VENTILATION		
HVAC	AIR CONDITIONER		

1. THESE PLANS, NOTES AND DETAILS COMPLY WITH ALL MINIMUM REQUIREMENTS OF THE: CBC2019, CRC2019, CEC2019, CPC2019, CMC2019, CGBS2019, CFC2019, BEES2019, NEC2014, FRESNO COUNTY ORDINANCE CODE TITLE 15 AND CURRENT LOCAL CODES AND ORDINANCES.

2. THESE PLANS AND RELATED DOCUMENTS MUST BE AVAILABLE AT THE JOB SITE DURING ANY INSPECTION ACTIVITY. 2019 CRC R106.3.1

3. STREET ADDRESS NUMBERS SHALL BE CLEARLY POSTED AND UNOBSTRUCTED PRIOR TO CONSTRUCTION AND INSPECTIONS. R319.1 ADDRESS NUMBER SHALL BE A MINIMUM OF 4 INCHES (102 MM.) HIGH WITH A MINIMUM STROKE WIDTH OF 1/2 INCH.

4. IT IS THE RESPONSIBILITY OF THE GENERAL CONTRACTOR, SUBCONTRACTORS, AND OR AGENTS TO REVIEW THESE PLANS PRIOR TO START WORK. ANY DISCREPANCIES, ERRORS AND/OR OMISSIONS SHALL BE NOTED AND DIRECTED IMMEDIATELY TO THE DESIGNER FOR CORRECTION. THE DESIGNER SHALL NOT BE LIABLE FOR ERRORS AND OMISSIONS TO THE PLANS AFTER AND DURING

5. WORK SHALL BE INSTALLED IN ACCORDANCE WITH THE APPROVED CONSTRUCTION DOCUMENTS AND SPECIFICATIONS, AND ANY CHANGES MADE DURING CONSTRUCTION THAT ARE NOT IN COMPLIANCE WITH THE APPROVED CONSTRUCTION DOCUMENTS AND SPECIFICATIONS SHALL BE RESUBMITTED FOR APPROVAL AS AN AMENDED SET OF CONSTRUCTION DOCUMENTS. [CRC R106.4]

6. IF PERMITS ARE TO BE ISSUED TO ANYONE OTHER THAN A LICENSED CONTRACTOR, AN OWNER - BUILDER VERIFICATION MUST BE COMPLETED BY THE OWNER AND SUBMITTED PRIOR TO ISSUANCE OF PERMITS. THE PERMITTEE WILL HIRE EMPLOYEES SUBJECT TO WORKER'S COMPENSATION LAW REQUIREMENTS AND PROVIDE CURRENT, VALID CERTIFICATE OF WORKER'S COMPENSATION INSURANCE.

7. REPAIR ALL DAMAGED AND/OR OFF GRADE CONCRETE STREET IMPROVEMENTS AS DETERMINED BY THE CONSTRUCTION MANAGEMENT ENGINEER PRIOR TO

8. ANY SURVEY MONUMENTS WITHIN THE AREA OF CONSTRUCTION SHALL BE PRESERVED OR RESET BY A PERSON LICENSED TO PRACTICE LAND SURVEYING IN THE STATE OF CALIFORNIA.

9. TWO WORKING DAYS BEFORE COMMENCING EXCAVATION OPERATIONS WITHIN THE STREET RIGHT OF WAY AND/OR UTILITY EASEMENTS, ALL EXISTING UNDERGROUND FACILITIES SHALL HAVE BEEN LOCATED BY UNDERGROUND SERVICES ALERT (USA)

10. LOCATE AND EXPOSE ALL PROPERTY CORNERS AND STRING PROPERTY LINES PRIOR TO THE FOUNDATION INSPECTION.

11. A CHEMICAL TOILET IS REQUIRED ON-SITE DURING CONSTRUCTION. [CBC 3305.1]

12. PROVIDE A CONSTRUCTION WASTE MANAGEMENT PLAN. PLAN MUST BE FINALIZED PRIOR TO OCCUPANCY.

GENERAL REQUIREMENTS (CONT.) GENERAL REQUIREMENTS

13. WATERPROOFING AND DAMP PROOFING AS AMENDED: A BUILDING SHALL HAVE THE FOUNDATION WALL OR CONCRETE FLOOR SLAB CONSTRUCTED ABOVE THE CROWN OF THE ADJOINING STREET, UNLESS OTHERWISE APPROVED BY THE BUILDING OFFICIAL. THE GROUND AROUND THE STRUCTURE SHALL BE SLOPED TWO PERCENT (2%) FOR A DISTANCE OF FIVE FEET (5') TO PROVIDE DRAINAGE AWAY FROM THE STRUCTURE. CBC 1805, CRC R406, SURFACE WATER DRAINING. R300.1, R300.2

14. FINISHED FLOOR ELEVATION SHALL BE ABOVE THE CROWN OF THE STREET.

15. PROJECTS LOCATED IN THE FLOOD HAZARD AREA SHALL HAVE A FINISHED FLOOR ELEVATION OF NOT LESS THAT 1" ABOVE THE 100 YEAR FLOOD LEVEL. CRC R106.1.1

16. THE PERMIT OF THIS PROJECT REQUIRES FIRE SPRINKLER (CRC R 313.2). LAYOUT AND DETAILS THE THE FIRE SPRINKLER SYSTEM SHALL BE DESIGNED IN ACCORDANCE WITH NFPA 13 OR CRC SECTION 313.3 (CRC R 313.1., R 313.2), RECEIVED AND APPROVED BY THE APPLICABLE FIRE MARSHALL PRIOR TO PERMITTING THE PLAN FROM FRESNO COUNTY. THE FIRE SPRINKLER SYSTEM SHALL BE INSTALLED BY A LICENSED FIRE SPRINKLER CONTRACTOR OR OWNER OCCUPIED OWNER BUILDERS, AND SHALL BE INSPECTED AND APPROVED BY THE FIRE MARSHALL PRIOR TO APPROVAL OF OCCUPANCY OF THE BUILDING (B & P CODE CONTRACTORS LICENSE LAW SECTION 7026).

17. AFTER INSTALLING INSULATION, THE INSULATION INSTALLER SHALL POST IN A CONSPICUOUS LOCATION IN THE BUILDING A CERTIFICATE SIGNED BY THE INSTALLER AND THE BUILDER STATING THAT THE INSTALLATION CONFORMS WITH THE REQUIREMENTS OF TITLE 24, PART 2, CHAPTER 253, SUB CHAPTER 4, ARTICLES.

18. THE CERTIFICATE SHALL STATE THE MANUFACTURER'S NAME AND MATERIALS INSTALLED "R" VALUE, AND (IN APPLICATIONS OF LOOSE FILL INSULATION). THE MINIMUM INSTALLED WEIGHT PER SQUARE FOOT CONSISTENT WITH THE MANUFACTURER'S LABELED DENSITY FOR THE DESIRED "R" VALUE. SECTION 1403 (D) TITLE 24

19. REGISTERED FORMS OF THE CF-2R AND CF-3R FORMS SHALL BE SUBMITTED PRIOR TO FINAL INSPECTION, SIGNED BY CERTIFIED INSTALLER(S) FOR THE CF-2R FORM, AND THE HERS RATER, FOR FIELD VERIFICATION AND DIAGNOSTIC TESTING ON THE CF-3R FORM. PRIOR TO THE REQUEST FOR A FINAL INSPECTION, IT IS UNDERSTOOD THAT NO FINAL INSPECTION WILL BE MADE UNTIL THESE FORMS ARE SUBMITTED. (BEES2019 SECTION 10-103 (A) (3) AND 10-103 (A)(5))

20. THERMAL AND SOUND INSULATING MATERIALS, AS AMENDED: I - INSULATION DEPTH MARKERS SHALL BE PROVIDED IN ATTIC SPACES WHERE PNEUMATICALLY PLACED ("BLOWN") INSULATION IS TO BE INSTALLED. A SUFFICIENT NUMBER OF MARKERS SHALL BE INSTALLED TO ALLOW AN INSPECTOR TO REASONABLY SUBSTANTIATE INSULATION DEPTH FROM THE ATTIC OPENINGS WITHOUT CRAWLING IN THE ATTIC. MARKERS SHALL BE PLACED WITH THE BOTTOMS EVEN WITH THE BOTTOM OF CEILING JOISTS. THEY SHALL BE OF REASONABLY SUBSTANTIAL MATERIAL (SUCH AS HEAVY-GAUGE CARDBOARD OR WOOD) TO PREVENT BENDING OR DISLODGEMENT DURING PLACEMENT OF INSULATION, MARKERS SHALL BE TRI-COLORED AS

BOTTOM OF MARKER TO PLUS SIX INCHES (+6") — BLUE. FROM PLUS SIX INCHES (+6") TO PLUS NINE INCHES (+9") — RED. FROM PLUS NINE INCHES (+9") TO TWELVE INCHES (12") — WHITE.

II - PNEUMATICALLY-PLACED INSULATION SHALL BE PLACED IN ACCORDANCE WITH THE MANUFACTURER'S RECOMMENDATIONS.

21. CONTINUOUS VAPOR BARRIER REQUIRED ON CONDITIONED SIDE OF ALL INSULATION IN ALL EXTERIOR WALLS, ON THE FLOORS ON UNVENTED ATTICS AND FLOORS OVER UNVENTED CRAWL SPACES TO PROTECT AGAINST MOISTURE

CONDENSATION.

22. FOAM PLASTIC PROTECTION. IN AREAS WHERE THE PROBABILITY OF TERMITE INFESTATION IS "VERY HEAVY" AS INDICATED IN FIGURE R301.2(6), EXTRUDED AND EXPANDED POLYSTYRENE, POLYSOCYANURATE AND OTHER FOAM PLASTICS SHALL NOT BE INSTALLED ON THE EXTERIOR FACE OR UNDER INTERIOR OR EXTERIOR FOUNDATION WALLS OR SLAB FOUNDATIONS LOCATED BELOW GRADE. THE CLEARANCE BETWEEN FOAM PLASTICS INSTALLED ABOVE GRADE AND EXPOSED EARTH SHALL BE NOT LESS THAN 6 INCHES. R318.4

23. THE ATTIC ACCESS SHALL BE WEATHER-STRIPPED AND INSULATION EQUIVALENT TO THAT OF THE CEILING SHALL BE INSTALLED ON THE ACCESS PANEL. (SECT. 117 OF

24. FINGER JOINTED STUDS MUST BE GRADE STAMPED BY AN APPROVED ICC INSPECTION AGENCY AND CLEARLY SPECIFIED ON PLANS.

25. FINGER JOINTED STUDS IN STRUCTURAL WALLS (BEARING OR SHEAR) SHALL BE APPROVED AND ARE NOT ALLOWED AT HOLD DOWN LOCATIONS.

26. MIN. NET HEIGHT OF THE REQUIRED EGRESS DOOR TO BE NOT LESS THAN 78" MEASURED FROM THE TOP OF THRESHOLD TO BOTTOM OF DOORSTOP

27. THE MAXIMUM HOT WATER TEMPERATURE DISCHARGE SHALL BE LIMITED FOR THE FOLLOWING: BATHTUBS AND WHIRLPOOL BATHTUBS SHALL BE LIMITED TO 120F BY A

CONSIDERED AS MEETING THIS PROVISION.)

THAT CONFORMS TO ASSE 1070 OR CSA B125.3 (CPC SECTION 415.5) (THE WATER HEATER THERMOSTAT SHALL NOT NOT BE

SHOWER AND TUB/SHOWER MIXING VALVES SHALL PROVIDE SCALD AND THERMAL SHOCK PREVENTION. (CPC SECTION 418.0).

ALL HOSE BIBS SHALL BE EQUIPPED WITH NON- REMOVABLE BACK FLOW PREVENTERS. (CPC 603.4.7)

ALL PLUMBING CONVEYING OR DISPENSING WATER FOR HUMAN CONSUMPTION SHALL COMPLY WITH AB 1953 FOR LEAD CONTENT

28. FLAME SPREAD INDEX. WALL AND CEILING FINISHES SHALL HAVE A FLAME SPREAD INDEX OF NOT GREATER THAN 200. R302.9.1 FLAME SPREAD INDEX AND SMOKE-DEVELOPED INDEX FOR INSULATION.


29. INSULATION MATERIALS, INCLUDING FACINGS, SUCH AS VAPOR RETARDERS AND VAPOR-PERMEABLE MEMBRANES INSTALLED WITHIN FLOOR-CEILING ASSEMBLIES, ROOF-CEILING ASSEMBLIES, WALL ASSEMBLIES, CRAWL SPACES AND ATTICS SHALL HAVE A FLAME SPREAD INDEX NOT TO EXCEED 25 WITH AN ACCOMPANYING SMOKE-DEVELOPED INDEX NOT TO EXCEED 450 WHERE TESTED IN ACCORDANCE WITH ASTM E84 OR UL 723. R302.10.1 SEE EXCEPTIONS.

30. SMOKE DEVELOPED INDEX. WALL AND CEILING FINISHES SHALL HAVE A SMOKE-DEVELOPED INDEX OF NOT GREATER THAN 450. R302.9.2

31. IF A SPECIAL INSPECTION IS REQUIRED BY THE GEOTECHNICAL ENGINEER FOR COMPLIANCE WITH THE GEOTECHNICAL REPORT, THE SPECIAL INSPECTION REPORT SHALL BE SUBMITTED TO AND APPROVED BY THE COUNTY BUILDING DEPARTMENT PRIOR TO THE FOUNDATION INSPECTION.

32. ORIGINAL SIGNED AND STAMPED PERMIT SHALL BE RETURNED TO THE COMMUNITY AND ECONOMIC DEVELOPMENT/BUILDING DEPARTMENT FOR REVIEW, MODIFICATION AND ACCEPTANCE PRIOR TO MAKING ANY CHANGES TO THE APPROVED DESIGN. NEW SUPPORTING DOCUMENTATION AND ENGINEERING CALCULATIONS, AS REQUIRED, SHALL ACCOMPANY THE ORIGINAL PLANS.

33. PROVIDE CONSTRUCTION SITE ADDRESS "APPROVED NUMBERS OR ADDRESS SIGNS SHALL BE PROVIDED AT CONSTRUCTION SITES. THEY SHALL BE PAINTED ON THE FACE OF THE CURB, ON THE FRONT SIDE OF THE LOT, PRIOR TO THE FIRST INSPECTION. CURB NUMBERS SHALL BE A MINIMUM OF FOUR (4) INCHES IN HEIGHT AND HAVE CONTRASTING OR REFLECTING BACKGROUND AND PERMANENTLY PAINTED ON THE FACE OF THE CURB. TEMPORARY STREET NAME SHALL BE PAINTED ON THE CURBS OF ALL STREETS AT THE STREET INTERSECTIONS. IN THE EVENT THAT NO CURB EXISTS, CONSTRUCTION SIGN ADDRESS SIGNS AND TEMPORARY STREET NAME SIGNS SHALL BE POSTED AT A HEIGHT OF BETWEEN 48" AND 72""

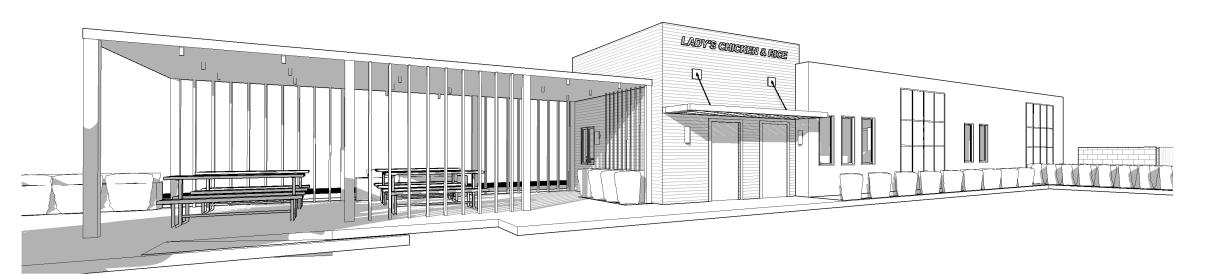

EYE LEVEL PERSPECTIVE

SOILS BEARING CAPACITY 1500B CNC DESIGN STRENGTH @28 DAYS 2500PSI MATERIAL DEAD LOADS

R301.2.2.2.1 WEIGHT OF MATERIALS

AVERAGE DEAD LOADS SHALL NOT EXCEED 15 POUNDS PER SQUARE FOOT (720PA) FOR THE COMBINED ROOF AND CEILING ASSEMBLIES (ON A HORIZÓNTAL PROJECTION). OR 10 POUNDS PER SQUARE FOOT (480PA) FOR FLOOR ASSEMBLIES. EXCEPT AS FURTHER LIMITED BY SECTION R301.2.2 DEAD LOADS FOR WALLS ABOVE GRADE SHALL NOT EXCEED.

FIFTEEN POUNDS (720PA) PER SQUARE FOOT FOR EXTERIOR LIGHT-FRAME WOOD WALLS TEN POUNDS (480PA) PER SQUARE FOOT, OR NITER DR LIGHT-FRAME WOOD WALLS EIGHTY FIVE POUNDS (3830PA) PER QUARE FOOT FOR 6-INCH-THICK CONCRETE WALL SEE EXCEPTIONS.

TABLE R301.5 MININ UM UNIN OPMILY DISTRIBUTED LIVE LOADS

UNINHABITABLE TTICS WITHOUT STORAGE 10 T. 'ER THAN SLEEPING ROOMS GUARD AND HANDRAILS

FOR MATERIAL LOADS BEYOND CONVENTIONAL CONSTRUCTION, REFER TO **ENGINEER'S STRUCTURAL CALCULATIONS**

MATERIAL LOADS

D MATERIAL LIVE LOADS F

THIS PROJECT MUST COMPLY WITH THE LATEST APPLICABLE CODE WHICH HAVE BEEN ADOPTED BY THE GOVERNING AGENCIES HAVING JURISDICTION, INCLUDING BUT NOT LIMITED TO THE FOLLOWING:

2022 CALIFORNIA BUILDING CODE, VOLS 1 & 2 2022 CALIFORNIA ELECTRICAL CODI 2022 CALIFORNIA MECHANICAL CODE 2022 CALIFORNIA PLUMBING CODE 2022 CALIFORNIA ENERGY CODE 2022 CALIFORNIA FIRE CODE 2022 CALIFORNIA GREEN BUILDING CODE 2022 CALIFORNIA REFERENCE STANDARDS CODE

THESE CODES SHALL BE CONSIDERED AN INTEGRAL PART OF THESE DRAWINGS AS IF THEY WERE PRINTED HERE ON THIS SHEET IN THEIR ENTIRETY.

ANDREW GOODWIN DESIGNS

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559-623-4973

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PORTERVILLE, CA. 93257

ANDREW OR ALEX

APPLICABLE CODES

2022 CALIFORNIA RESIDENTIAL CODE

PROVIDE LISTING ON CPVC PIPING, A WRITTEN CERTIFICATE OF COMPLIANCE WITH THE CNDITIONS OR USE AND WRITTEN FLUSHING AND WORKER SAFETY MEASURES FOR CPVC POTABLE WATER PIPING SYSTEMS

ALL INSTALLATIONS OR PEX PIPE WHERE IT IS THE INITIAL PLUMBING PIPING INSTALLED IN NEW CONSTRUCTION SHALL BE FLUSHED TWICE OVER A PERIOD OF AT LEAST ONE WEEK. THE PIPE SYSTEM SHALL BE FIRST FLUSHED FOR AT LEAST 10 MINUTES AND THEN FILLED

AND ALLOWED TO STAND FOR NO LESS THAN 1 WEEK, AFTER WHICH ALL BRANCHES OF THE PIPE SYSTEM MUST BE FLUSHED LONG ENOUGH TO FULLY EMPTY THE CONTAINED VOLUME.

AT THE TIME OF FILL, EACH FIXTURE SHALL HAVE A REMOVABLE TAG APPLIED STATING: " THIS PLUMBING SYSTEM WAS FIRST FILLED AND FLUSHED ON (NAME). THE STATE OF CALIFORNIA REQUIRES THAT THE SYSTEM BE FLUSHED STANDING AT LEAST ONE WEEK AFTER THE FILL DATE SPECIFIED ABOVE. IF THIS SYSTEM IS USED EARLIER THAN ONE WEEK AFTER THE FILL DATE, THE WATER MUST BE ALLOWED TO RUN FOR AT LEAST TWO MINUTES PRIOR TO THE USE FOR HUMAN CONSUMPTION. THIS TAG MA NOT BE REMOVED PRIOR TO THE COMPLETION OF THE REQUIRED SECOND FLUSHING, EXCEPT BY THE BUILDING OWNER OR

PRIOR TO ISSUING A BUILDING PERMIT TO INSTALL PEX PIPE THE BUILDING OFFICIAL SHALL REQUIRE AS PART OF THE PERMITTING PROCESS THAT THE CONTRACTOR, OR THE APPROPRIATE PLUMBING SUBCONTRACTORS, PROVIDE WRITTEN CERTIFICATION THAT HE OR SHE WILL COMPLY WITH THE FLUSIHING PROCEDURES SET FORTH IN THE CODE.

WATER SUPPLY AND DISTRIBUTION

ADDRESS NUMBERS

OCCUPANT.

APPROVED ADDRESS NUMBERS, BUILDING NUMBERS OR APPROVED BUILDING IDENTIFICATION SHALL BE PLACED IN A POSITION THAT IS PLAINLY LEGIBLE AND VISIBLE FROM THE STREET, ROAD, ALLEY, AND WALKWAYS GIVING ACCESS TO AND WITHIN THE PROPERTY. THESE NUMBERS SHALL CONTRAST WITH THEIR BACKGROUND. ADDRESS NUMBERS SHALL BE ARABIC NUMERALS OR ALPHABET LETTERS. NUMBERS SHALL BE A MINIMUM OF 4 INCHES (102 MM) HIGH WITH A MINIMUM STROKE WIDTH OF 0.5 INCH (12.7 MM) AND SHALL BE ILLUMINATED IN AN APPROVED MANNER (IF NUMBERS ARE ON THE EXTERIOR). NUMBER AND STROKE WIDTH SHALL BE INCREASED AS NEEDED FOR LEGIBILITY BASED ON VISIBILITY

FIRE SPRINKLER

PROVIDE A COMPLETE AUTOMATIC FIRE SPRINKLER SYSTEM THROUGHOUT THE STRUCTURE, INCLUDING THE GARAGE, INSTALLED IN ACCORDANCE WITH THE RECOMMENDATIONS OF NFPA 13D AND THE REQUIREMENTS OF THE VENTURA FIRE DEPARTMENT. FIRE SPRINKLER PLANS SHALL BE SUUBMITTED WITHIN 30 DAYS OF ISSUANCE OF THE BUILDING PERMIT. SMOKE ALARM/ DETECTORS:

SMOKE ALARM/DETECTORS SHALL BE WIRED TO THE BUILDING ELECTRICAL SYSTEM, BE EQUPPED WITH BATTERY BACKUP, AND EMIT A SIGNAL WHEN BATTERIES ARE LOW. SMOKE ALARMS SHALL BE INTERCONNECTED, SO THAT THE ACTIVATION OF ONE ALARM WILL ACTIVATE ALL OTHER ALARMS.


CARBON MONOXIDE ALARM/ DECTECTORS:

SHALL COMPLY WITH UL2034 AND BE INSTALLED IN ACCORDANCE WITH THE CALIFORNIA FIRE CODE AND CALIFORNIA HEALTH AND SAFETY CODE SECTION 17926. CARBON MONOXIDE ALARM/ DECTECTORS SHALL BE WIRED TO THE BUILDING ELECTRICAL SYSTEM AND BE EQUIPPED WITH BATTERY BACKUP. CARBON MONOXIDE ALARMS SHALL BE INTERCONNECTED, SO THAT THE ACTIVATION OF ONE ALARM WILL ACTIVATE ALL OTHER ALARMS.

OVERALL PROJECT:

THE PROJECT CONSITS OF THE CONSTRUCTION OF A NEW 1,597 SF RESTAURANT WITH A DRIVE-THRU AND OUTDOOR EATING AREAS. THE BUILDING IS A TYPE V-B CONSTRUCTION

SITE WORK WILL INVOLVE MODIFICATIONS OF EXISTING DRIVEWAY ENTRIES TO THE SITE, ADDITION OF 14 ON-SITE PARKING SPACES, LOADING ZONES, AND A DRIVE-THRU LANE. THE BUILDING WILL BE CONSTRUCTED ABOVE THE FLOODPLAIN PER CIVIL DOCUMENTS, WITH ACCESSIBLE RAMPS AND LANDINGS AT MAIN ACCESS POINTS PER PLAN. A NEW TRASH ENCLOSURE AND STRIPING AS REQUIRED WILL BE CONSTRUCTED

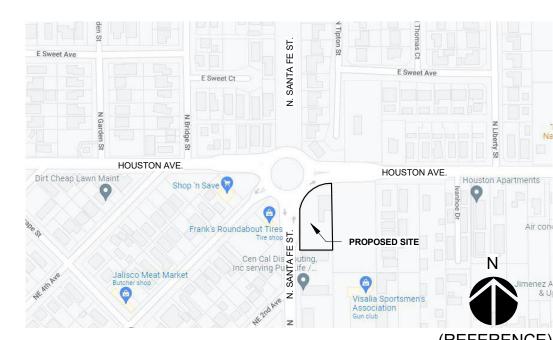

VICINITY MAP

PARCEL INFORMATION					
ADDRESS:	519 E. HOUSTO VISALIA, CA 93		LOT COVE	RAGE: PE COVERAGE:	5.42% 18.17%
APN: ZONING:	094-130-049 C-MU	202		COVERAGE:	8.92%
	(COMMERCIAL	MIXED-USE)	BUILDING	HEIGHT:	15' - 0" M
OCCUPANCY: PARCEL AREA:	A-2 29,445 SF (0.68	ACRES)	PARKING S	STALL COUNT:	14
SETBACKS:	FRONT: REAR, SIDE:	15'-0" 0'-0"	FIRE SPRII	NKLER: :RITY ZONE:	NONE NONE
CONSTRUCTION TYPE: STORIES:	V-B		FEMA LOO	D ZONE:	AE
BUILDING SF:	1,597 SF		UTILITY PF SC	ROVIDERS: E - ELECTRIC	

SOCALGAS - GAS

VISALIA WATER AND SEWER

WM - WASTE MANAGEMENT - TRASH

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> architect: andrew goodwin, aia andrew@andrewgoodwin.us principal: alex ceballos alex@alexceballos.com

SEAL

SHEET INDEX

CITY OF VISALIA DETAILS AND STANDARDS

COVER SHEET

FLOOR PLAN

BUILDING ELEVATIONS

SITE PLAN

Current

Rev Current Rev Date

03/15/2023



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PROJECT

LADY'S CHICKEN AND RICE

519 E. HOUSTON AVE. VISALIA, CA 93292

CLIENT

BOUNLEUK AND JIMMY THONGSENG

REVISIONS

REV # REV DATE REV DESCRIPTION

SHEET TITLE

COVER SHEET

03/30/2023 **TECHNICIAN:**

PROJECT MANAGER:

JOB NUMBER: SHEET NUMBER

ARCHITECT

CONTACT

ADDRESS

WEBSITE

PHONE

EMAIL

OWNER

CONTACT

ADDRESS

ADDRESS

PHONE

EMAIL

PROJECT CONSULTANTS

FOR APN/PARCEL ID{S}: 094-130-049-000

THE LAND REFERRED TO HEREIN BELOW IS SITUATED IN THE CITY OF VISALIA, COUNTY OF TULARE, STATE OF CALIFORNIA AND IS DESCRIBED AS FOLLOWS:

THE NORTH 268 FEET OF LOT 8 OF PRATT VILLA TRACT, IN THE CITY OF VISALIA. COUNTY OF TULARE, STATE OF CALIFORNIA, AS PER MAP RECORDED IN BOOK 7, PAGE 18 OF MAPS IN THE OFFICE OF THE COUNTY RECORDER OF SAID COUNTY.

BEGINNING AT THE NORTHWEST COMER OF SAID LOT 8; THENCE SOUTH 00° 26' 19" EAST 268.00 FEET ALONG THE WEST LINE OF SAID LOT 8; THENCE SOUTH 90° 00' 00" EAST 3.00 FEET ALONG THE SOUTH LINE OF THE NORTH 268.00 FEET OF SAID LOT 8; THENCE NORTH 00° 26' 19" WEST 133.09 FEET ALONG A LINE PARALLEL WITH AND 3.00 FEET EAST OF THE WEST LINE OF SAID LOT 8 TO THE BEGINNING OF A CURVE CONCAVE TO THE SOUTHEAST HAVING A RADIUS OF 118.0 FEET; THENCE NORTHEASTERLY 186.26 FEET ALONG SAID CURVE THROUGH A CENTRAL ANGLE OF 90° 26' 19"; THENCE SOUTH 00° 00' 00" EAST 10.03 FEET ALONG A TANGENT LINE TO SAID CURVE, SAID TANGENT LINE ALSO BEING THE SOUTH LINE OF THE NORTH 16.00 FEET OF SAID LOT 8, TO A POINT ON THE EAST LINE OF SAID LOT 8; THENCE NORTH 00° 26' 13" WEST 16.00 FEET ALONG SAID EAST LINE OF SAID LOT 8; THENCE NORTH 90° 00' 00" WEST 131.94 FEET ALONG THE NORTH LINE OF SAID LOT 8 TO THE POINT OF BEGINNING.

EXCEPTING THEREFROM THAT PORTION OF LAND TO CITY OF VISALIA PER GRANT DEED RECORDED JUNE 08, 2001, INSTRUMENT NO. 2001-0042785, OF OFFICIAL RECORDS, DESCRIBED AS FOLLOWS:

THAT PORTION OF LOT 8 OF PRATT VILLA TRACT IN THE CITY OF VISALIA, COUNTY OF TULARE, STATE OF CALIFORNIA, AS PER MAP RECORDED IN BOOK 7, PAGE 18 OF MAPS, IN THE OFFICE OF THE COUNTY RECORDER OF SAID COUNTY, DESCRIBED AS FOLLOWS:

LEGAL SITE DESCRIPTION

PARKING COUNT

1 SPACE PROVIDED

4 SPACES PROVIDED

14 PROVIDED

(REFERENCE)

1,597 SF / 150 SF = 11 SPACES REQ'D.

REQUIRED PARKING SPACES:

REQUIRED ACCESSIBLE SPACES:

1-25 SPACES = 1 ACCESSIBLE

REQUIRED EV CHARGING CGBSC 5.106.5.3.1

10-25 SPACES = 4 EVCS

LOCAL STORM WATER ORDINANCE A. SECTION 4.106.1 - GENERAL PRESERVATION AND USE OF AVAILABLE NATURAL RESOURCES SHALL BE ACCOMPLISHED THROUGH EVALUATION AND CAREFUL PLANNING TO MINIMIZE NEGATIVE EFFECTS ON THE SITE AND ADJACENT AREAS. PRESERVATION OF SLOPES, MANAGEMENT OF STORM WATER DRAINAGE AND EROSION CONTROLS SHALL COMPLY WITH THIS SECTION B. SECTION 4.106.2 - STORM WATER DRAINAGE AND RETENTION DURING CONSTRUCTION PROJECTS WHICH DISTURB LESS THAN ONE ACRE OF SOIL AND ARE NOT PART OF A LARGER

COMMON PLAN OF DEVELOPMENT WHICH IN TOTAL DISTURBS ONE ACRE OR MORE, SHALL MANAGE STORM WATER DRAINAGE DURING CONSTRUCTION IN ORDER TO MANAGE STORM WATER DRAINAGE DURING CONSTRUCTION ONE OR MORE OF THE FOLLOWING MEASURES SHALL BE IMPLEMENTED TO PREVENT FLOODING OF ADJACENT PROPERTY, PREVENT EROSION AND RETAIN

SOIL RUNOFF ON THE SITE. RETENTION BASINS OF SUFFICIENT SIZE SHALL BE UTILIZED TO RETAIN STORM WATER ON

WHERE STORM WATER IS CONVEYED TO A PUBLIC DRAINAGE SYSTEM, COLLECTION POINT, GUTTER, OR SIMILAR DISPOSAL METHOD, WATER SHALL BE FILTERED BY USE OF A BARRIER SYSTEM, WATTLE, OR OTHER METHOD APPROVED BY THE ENFORCING AGENCY COMPLIANCE WITH A LAWFULLY ENACTED STORM WATER MANAGEMENT ORDINANCE.

SECTION 4.106.3 - SURFACE DRAINAGE' THE SITE SHALL BE PLANNED AND DEVELOPED TO KEEP SURFACE WATER FROM ENTERING BUILDINGS. CONSTRUCTION PLANS SHALL INDICATE HOW THE SITE GRADING OR DRAINAGE SYSTEM WILL MANAGE SURFACE WATER FLOWS. EXAMPLES OF METHODS TO MANAGE SURFACE WATER INCLUDE, BUT ARE NOT LIMITED TO, THE FOLLOWING SWALES.

WATER COLLECTION AND DISPOSAL SYSTEMS. FRENCH DRAINS

WATER RETENTION GARDENS. OTHER WATER MEASURES WHICH KEEP SURFACE WATER AWAY FROM BUILDING AND AID IN GROUNDWATER RECHARGE.

STORM WATER

SITE GRADING AND FOUNDATION ELEVATION

PER R401.3, LOTS SHALL BE GRADED TO DRAIN SURFACE WATER AWAY FROM FOUNDATION WALLS. THE GRADE SHALL FALL A MINIMUM OF 6 INCHES WITHIN THE FIRST 10 FEET. IF PHYSICAL OBSTRUCTIONS OR LOT LINES PROHIBIT 10 FEET (3048 MM) OF HORIZONTAL DISTANCE, A 5-PERCENT SLOPE SHALL BE PROVIDED TO AN APPROVED ALTERNATIVE METHOD OF DIVERTING WATER AWAY FROM THE FOUNDATION. SWALES USED FOR THIS PURPOSE SHALL BE SLOPED A MINIMUM OF 2 PERCENT WHERE LOCATED WITHIN 10 FEET (3048 MM) OF THE BUILDING FOUNDATION. IMPERVIOUS SURFACES WITHIN 10 FEET (3048 MM) OF THE BUILDING FOUNDATION SHALL BE SLOPED A MINIMUM OF 2 PERCENT AWAY FROM THE BUILDING.

EXCEPTION: WHERE CLIMATIC OR SOIL CONDITIONS WARRANT, THE SLOPE OF THE GROUND AWAY FROM THE BUILDING FOUNDATION IS PERMITTED TO BE REDUCED TO NOT LESS THAN ONE UNIT VERTICAL IN 48 UNITS HORIZONTAL (2-PERCENT SLOPE). THE PROCEDURE USED TO ESTABLISH THE FINAL GROUND LEVEL ADJACENT TO THE FOUNDATION

SHALL ACCOUNT FOR ADDITIONAL SETTLEMENT OF THE BACKFILL. 1808.7.4 FOUNDATION ELEVATION. ON GRADED SITES, THE TOP OF ANY EXTERIOR

FOUNDATION SHALL EXTEND ABOVE THE ELEVATION OF THE STREET GUTTER AT POINT OF DISCHARGE OR THE INLET OF AN APPROVED DRAINAGE DEVICE A MINIMUM OF 12 INCHES (305 MM) PLUS 2 PERCENT. ALTERNATE ELEVATIONS ARE PERMITTED SUBJECT TO THE APPROVAL OF THE BUILDING OFFICIAL, PROVIDED IT CAN BE DEMONSTRATED THAT REQUIRED DRAINAGE TO THE POINT OF DISCHARGE AND AWAY FROM THE STRUCTURE IS PROVIDED AT ALL LOCATIONS ON THE SITE.

SITE GRADING/FOUND. ELEV.

- FUGITIVE DUST WILL BE CONTROLLED IN ACCORDANCE WITH THE APPLICABLE RULES OF SAN JOAQUIN VALLEY AIR DISTRICT'S REGULATION VIII. COPIES OF ANY REQUIRED PERMITS WILL BE PROVIDED TO THE CITY.
- ALL REQUIRED WATER/FIRE BACKFLOW APPARATUS SHALL BE INSTALLED ON PRIVATE PROPERTY; NOT WITHIN PUBLIC RIGHT-OF-WAY.
- ADDRESS NUMBERS MUST BE PLACED ON THE EXTERIOR OF THE BUILDING IN SUCH A POSITION AS TO BE CLEARLY AND PLAINLY VISIBLE FROM THE STREET. NUMBERS WILL BE AT LEAST FOUR INCHES (4") HIGH AND SHALL BE OF A COLOR TO CONTRAST WITH THEIR BACKGROUND. IF MULTIPLE ADDRESSES ARE SERVED BY A COMMON DRIVEWAY, THE RANGE OF NUMBERS SHALL BE POSTED AT THE ROADWAY/DRIVEWAY. 2019 CFC 505.1
- CONSTRUCT PARKING PER CITY STANDARDS PK-1 THROUGH PK-4 AT TIME OF DEVELOPMENT.
- CONSTRUCT DRIVE APPROACH PER CITY STANDARDS AT TIME OF DEVELOPMENT
- CITY ORDINANCE 8.28.120-130 (EFFECTIVE 07/19/18) REQUIRES CONTRACTOR TO CONTRACT WITH CITY FOR REMOVAL OF CONSTRUCTION DEBRIS UNLESS TRANSPORTED IN EQUIPMENT OWNED BY CONTRACTOR OR UNLESS CONTRACTING WITH A FRANCHISE PERMITTEE FOR REMOVAL OF DEBRIS UTILIZING ROLL-OFF BOXES.
- NEW STREET STRIPING TO BE INSTALLED AS REQUIRED BY THE CITY ENGINEER. CONTRACTOR TO COORDINATE.

GENERAL NOTES - SITE PLAN

THIS SHEET ONLY #

- MODIFY (E) DRIVE APPROACH TO COMPLY WITH CITY OF VISALIA COMMERCIAL STDS C-24
- (E) DRIVE APPROACH COMPLIES WITH CITY OF VISALIA COMMERCIAL STDS C-24 FOR ONE-WAY DRIVES. REVISE GEOMETRY TO FORCE RIGHT-OUT TURNS ONLY.
- REPLACE CURB AND GUTTER IN-KIND WI DEMO WORK. INSTALL ONSITE AS NECESSARY. TYP.
- REPAIR AND/OR REPLACE ANY SIDEWALK ACROSS THE PUBLIC STREET FRONTAGE(S) OF THE SUBJECT SITE THAT HAS BECOME UNEVEN, CRACKED OR DAMAGED AND MAY CONSTITUTE A TRIPPING HAZARD. TYP.
- REPLACE ANY CURB AND GUTTER ACROSS THE PUBLIC STREET FRONTAGE(S) OF THE SUBJECT SITE THAT HAS BECOME UNEVEN AND HAS CREATED AREAS WHERE WATER CAN
- FINAL FINISH GRADE WILL BE DETERMINED DURING CONSTRUCTION DRAWINGS SUBMITTAL/CIVIL DRAWINGS - RAMP LENGTH WILL BE UPDATED
- PICK-UP WINDOW
- LANDSCAPE CURBING AT PLANTERS PER PLAN. TYP.
- MENU BOARDS
- ORDER STATION
- 2" ASPHALT CONCRETE PAVING OVER 4" CLASS 2 AGG. BASE, OR 4" CONCRETE PAVEMENT OVER 2" SAND MINIMUM PAVING AT PARKING LOT. PAVED AREAS MUST BE ENGINEERED TO WITHSTAND A 55,000 LB. REFUSE TRUCK
- DEMOLISH EXISTING DRIVE APPROACH. PATCH AND REPAIR SIDEWALK TO MATCH SURROUNDING CONDITIONS AND CITY STANDARDS. APPROXIMATE LOCATION SHOWN, FIELD-
- SPACE TO BE EV-CAPABLE. PROVIDE IN ACCORDANCE TO 5.106.5.3.1.
- PROVIDE SIGHT VISIBILITY TRIANGLE (FREE FROM OBSTRUCTIONS) FOR RIGHT TURN ONLY EXITING OF THE EXISTING DRIVEWAY. SIZED BASED ON 20MPH SPEED LIMIT OF ROUNDABOUT AND FHWA TABLE 3.3.1 (3).
- NOTE: CUSTOMER RESPONSIBLE FOR ALL CARDBOARD AND OTHER BULKY RECYCLABLES TO BE BROKEN DOWN BEFORE DISPOSING OF IN RECYCLE CONTAINERS
- 16. ALL REFUSE ENCLOSURES MUST BE R-3 OR R-4
- BIN ENCLOSURES ARE FOR CITY REFUSE CONTAINERS ONLY. GREASE DRUMS OR ANY OTHER ITEMS ARE NOT ALLOWED TO BE STORED INSIDE BIN ENCLOSURES.
- 18. PROVIDE AT MINIMUM A 6" DEEP CONCRETE SLAB IN FRONT OF TRASH ENCLOSURE AS PER CITY STANDARDS, MEASURING THE WIDTH OF THE ENCLOSURE BY TEN(10) FEET.
- GENERAL LANDSCAPING LAYOUT. TO BE LOW-MAINTENANCE TREE/SHRUB

SITE PLAN KEYNOTES



ANDREW GOODWIN DESIGNS 311 N 2ND ST. STE. B7 PORTERVILLE, CA. 93257 t: (559) 359-8789 www.PortervilleArchitect.com

> architect: andrew goodwin, aia andrew@andrewgoodwin.us principal: alex ceballos alex@alexceballos.com

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PROJECT

LADY'S CHICKEN AND RICE

519 E. HOUSTON AVE. VISALIA, CA 93292

CLIENT

BOUNLEUK AND JIMMY THONGSENG

REVISIONS

REV # REV DATE REV DESCRIPTION

07/27/2022 SITE PLAN REV. #1 2 03/15/2023 SITE PLAN REV. #2

SHEET TITLE

03/29/2023

SITE PLAN

ER **TECHNICIAN:**

PROJECT MANAGER: AC

JOB NUMBER:

SHEET NUMBER

NO O

S

HOU

+/- 42' - 0"

PROJECT WILL CONNECT TO EXISTING SS MAIN ON HOUSTON

RAISED PLANTER

NEIGHBORING LOT (EMPTY)

C-MU DESIGNATION

PROPOSED BUILDING=

NEW PAVEMENT TO MEET TRAFFIC

INDEX OF 5.0 MIN. FOR SOLID WASTE TRUCK TRAVEL PATH

___1-STORY-_66'-0"_-

1,597 INTERIOR SF

13

SETBACK

[133.09'

STREET CENTERLINE

N. SANTA FE ST.

FOOD TRUCK

< FOOD TRUCK

FINAL ELEVATIONS WILL BE

DURING THE CONSTRUCTION ,

DETERMINED BY CIVIL

_ DOCUMENTS PHASE


24' TRASH ENCLOSURE

UNDERGROUND ALL EXISTING OVERHEAD UTILITIES WITHIN


OVER 50KV SHALL BE EXEMPT FROM UNDERGROUNDING.


THE PROJECT LIMITS. EXISTING OVERHEAD ELECTRICAL LINES

AVE. TO BE COORDINATED WITH CITY ENGINEER

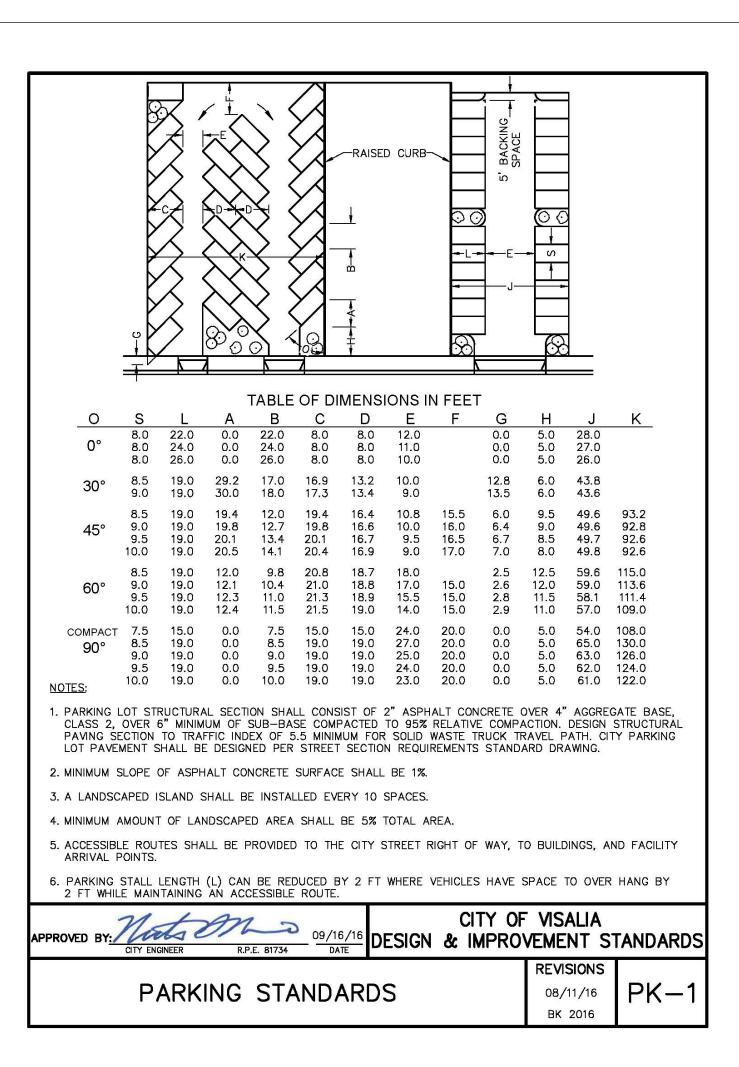


PK-2 PARKING STANDARD DRACHMAN SYSTEM

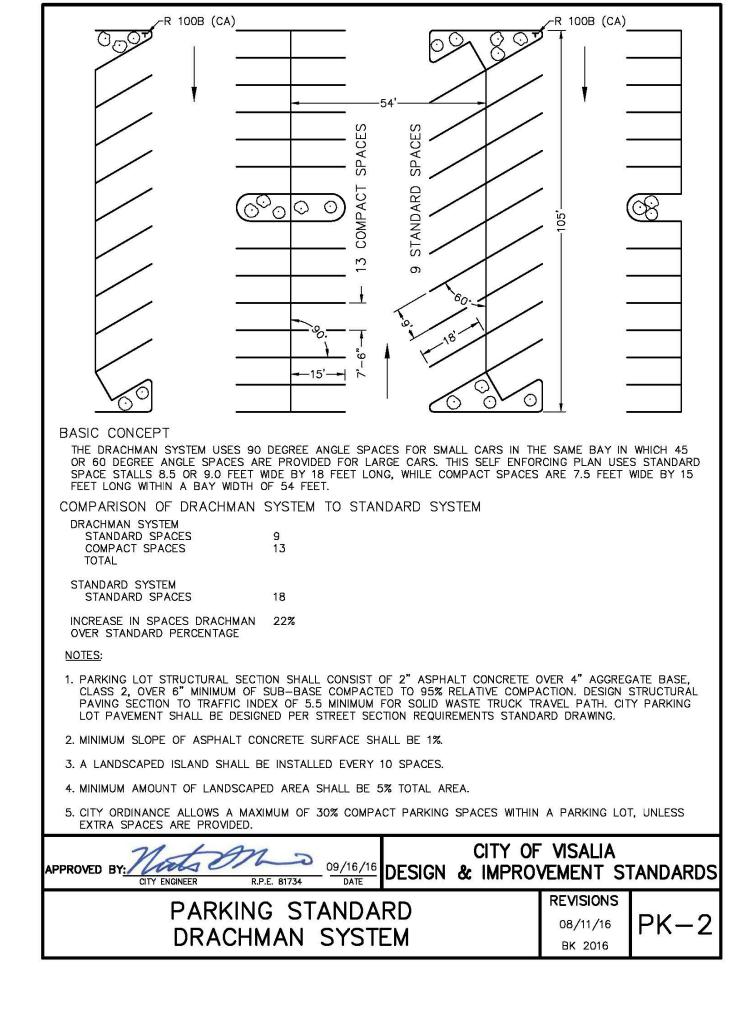


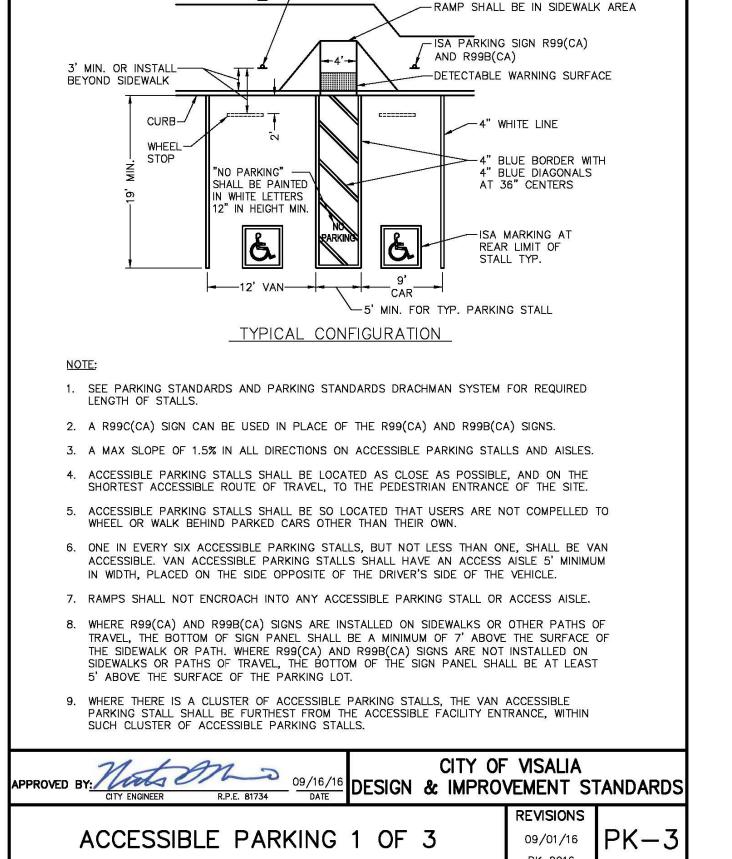

ISA PARKING SIGN R99(CA) AND R99B(CA). VAN ACCESSIBLE STALL SHALL REQUIRE SIGN R7-8b(CA) IN ADDITION, MOUNTED BELOW. SEE NOTE 2

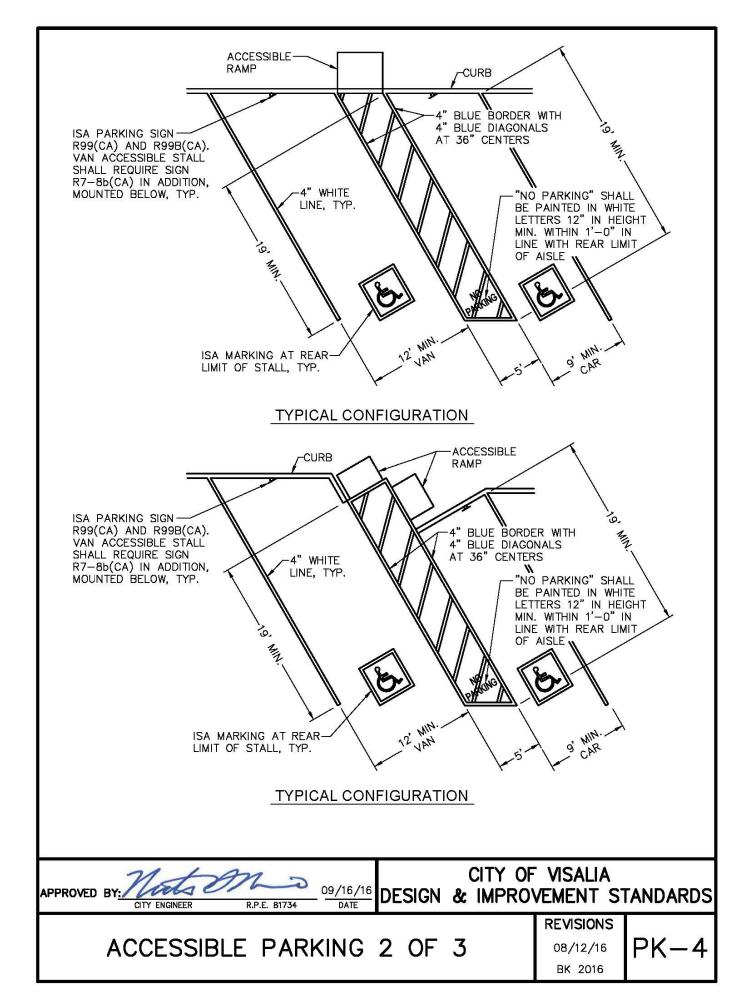



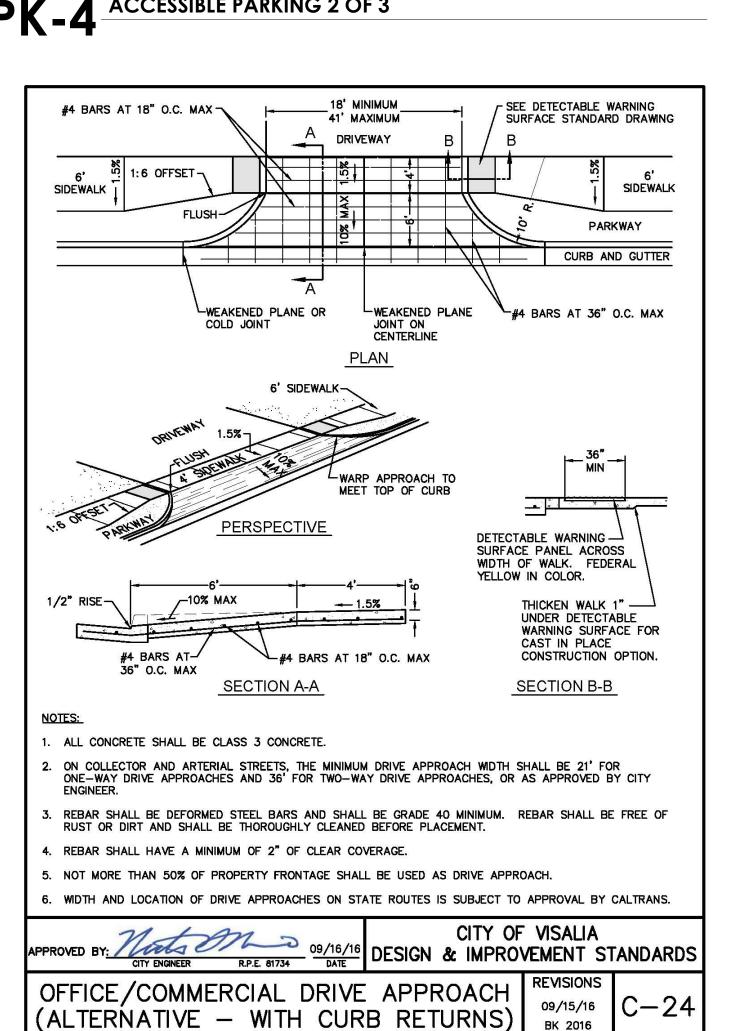

www.PortervilleArchitect.com architect: andrew goodwin, aia andrew@andrewgoodwin.us principal: alex ceballos alex@alexceballos.com

6

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CONSULTANTS

ARCHITECTURE | DESIGN

ANDREW GOODWIN DESIGNS

311 N. 2ND ST. STE. B7

PORTERVILLE, CA 93257

t: (559) 359-8789

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PROJECT

LADY'S CHICKEN AND RICE

519 E. HOUSTON AVE. VISALIA, CA 93292

CLIENT

BOUNLEUK AND JIMMY THONGSENG

REVISIONS

REV # | REV DATE | REV DESCRIPTION

SHEET TITLE

CITY OF VISALIA DETAILS AND STANDARDS

03/02/2023

ER **TECHNICIAN:**

PROJECT MANAGER: AC

JOB NUMBER:

SHEET NUMBER A1.1

R-3 24' REFUSE CONTAINER ENCLOSURE C-24 CONCRETE CONTROL JOINTS

CONCRETE SLAB FLOOR

O.C. BOTH WAYS


R-3

1

REVISIONS

08/15/16

BK 2016

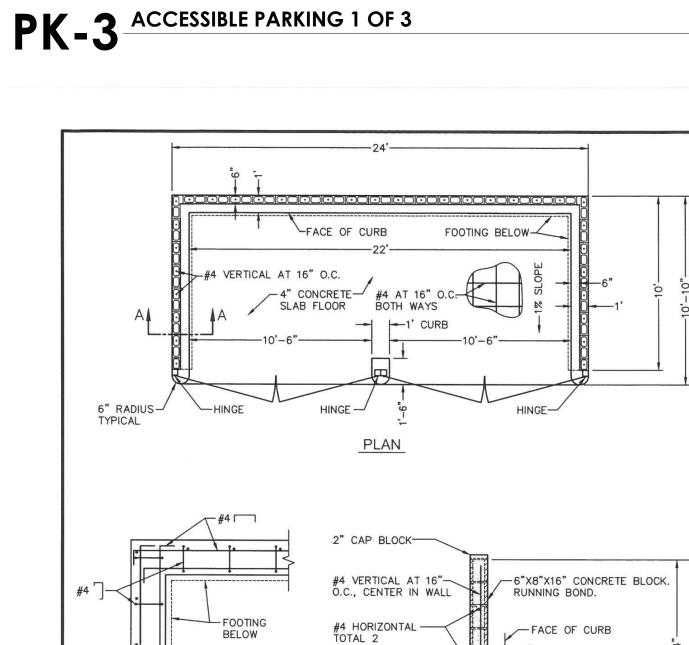

#4 - TOTAL 5 -

#4 → AT 16" O.C.,

PROVED BY: Mate Officer R.P.E. 81734 09/16/16 DESIGN & IMPROVEMENT STANDARDS

SECTION A-A

CENTER IN WALL

PLACE AGAINST UNDISTURBED -SOIL OR ENGINEERED FILL

COMPACTED TO 90%


24' REFUSE CONTAINER ENCLOSURE


RELATIVE COMPACTION

CURB CORNER DETAIL FOOTING CORNER DETAIL SIMILAR


FOR ALL APPLICABLE NOTES, SEE

REFUSE CONTAINER ENCLOSURE NOTES STANDARD DRAWING.

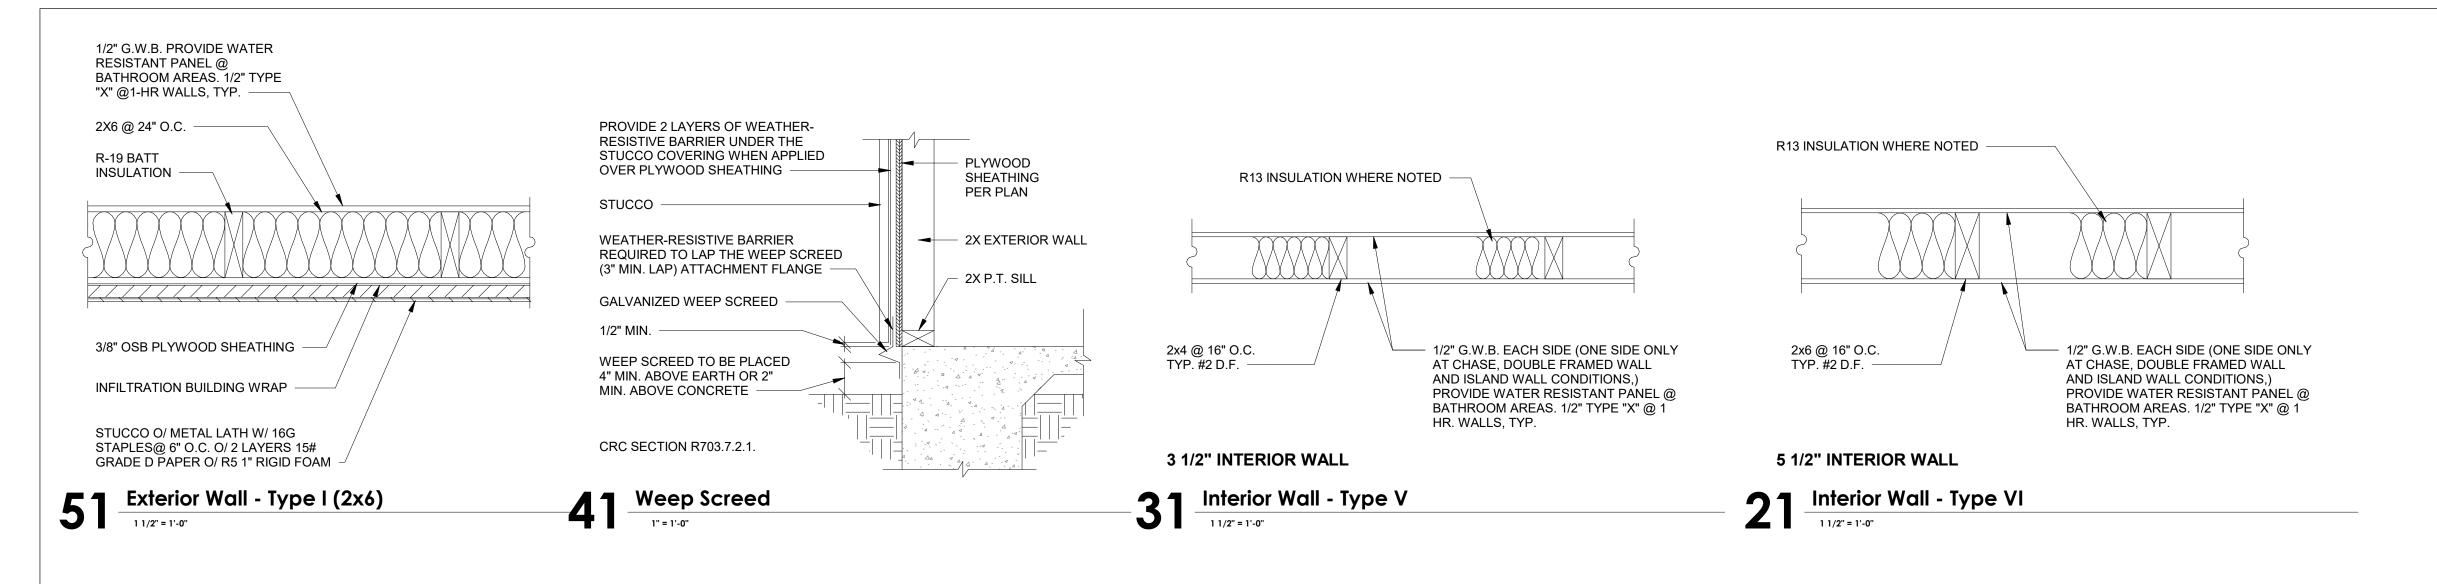

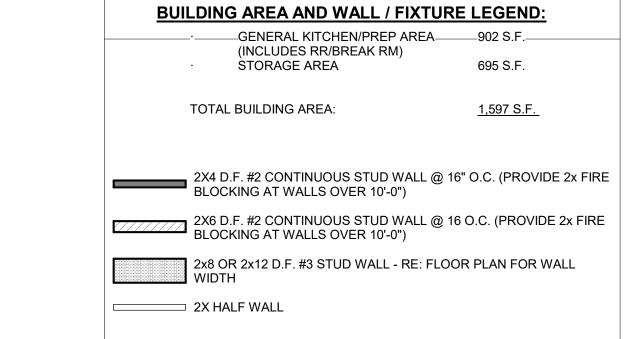

1 FLOOR PLAN - AREAS & WALL LEGEND

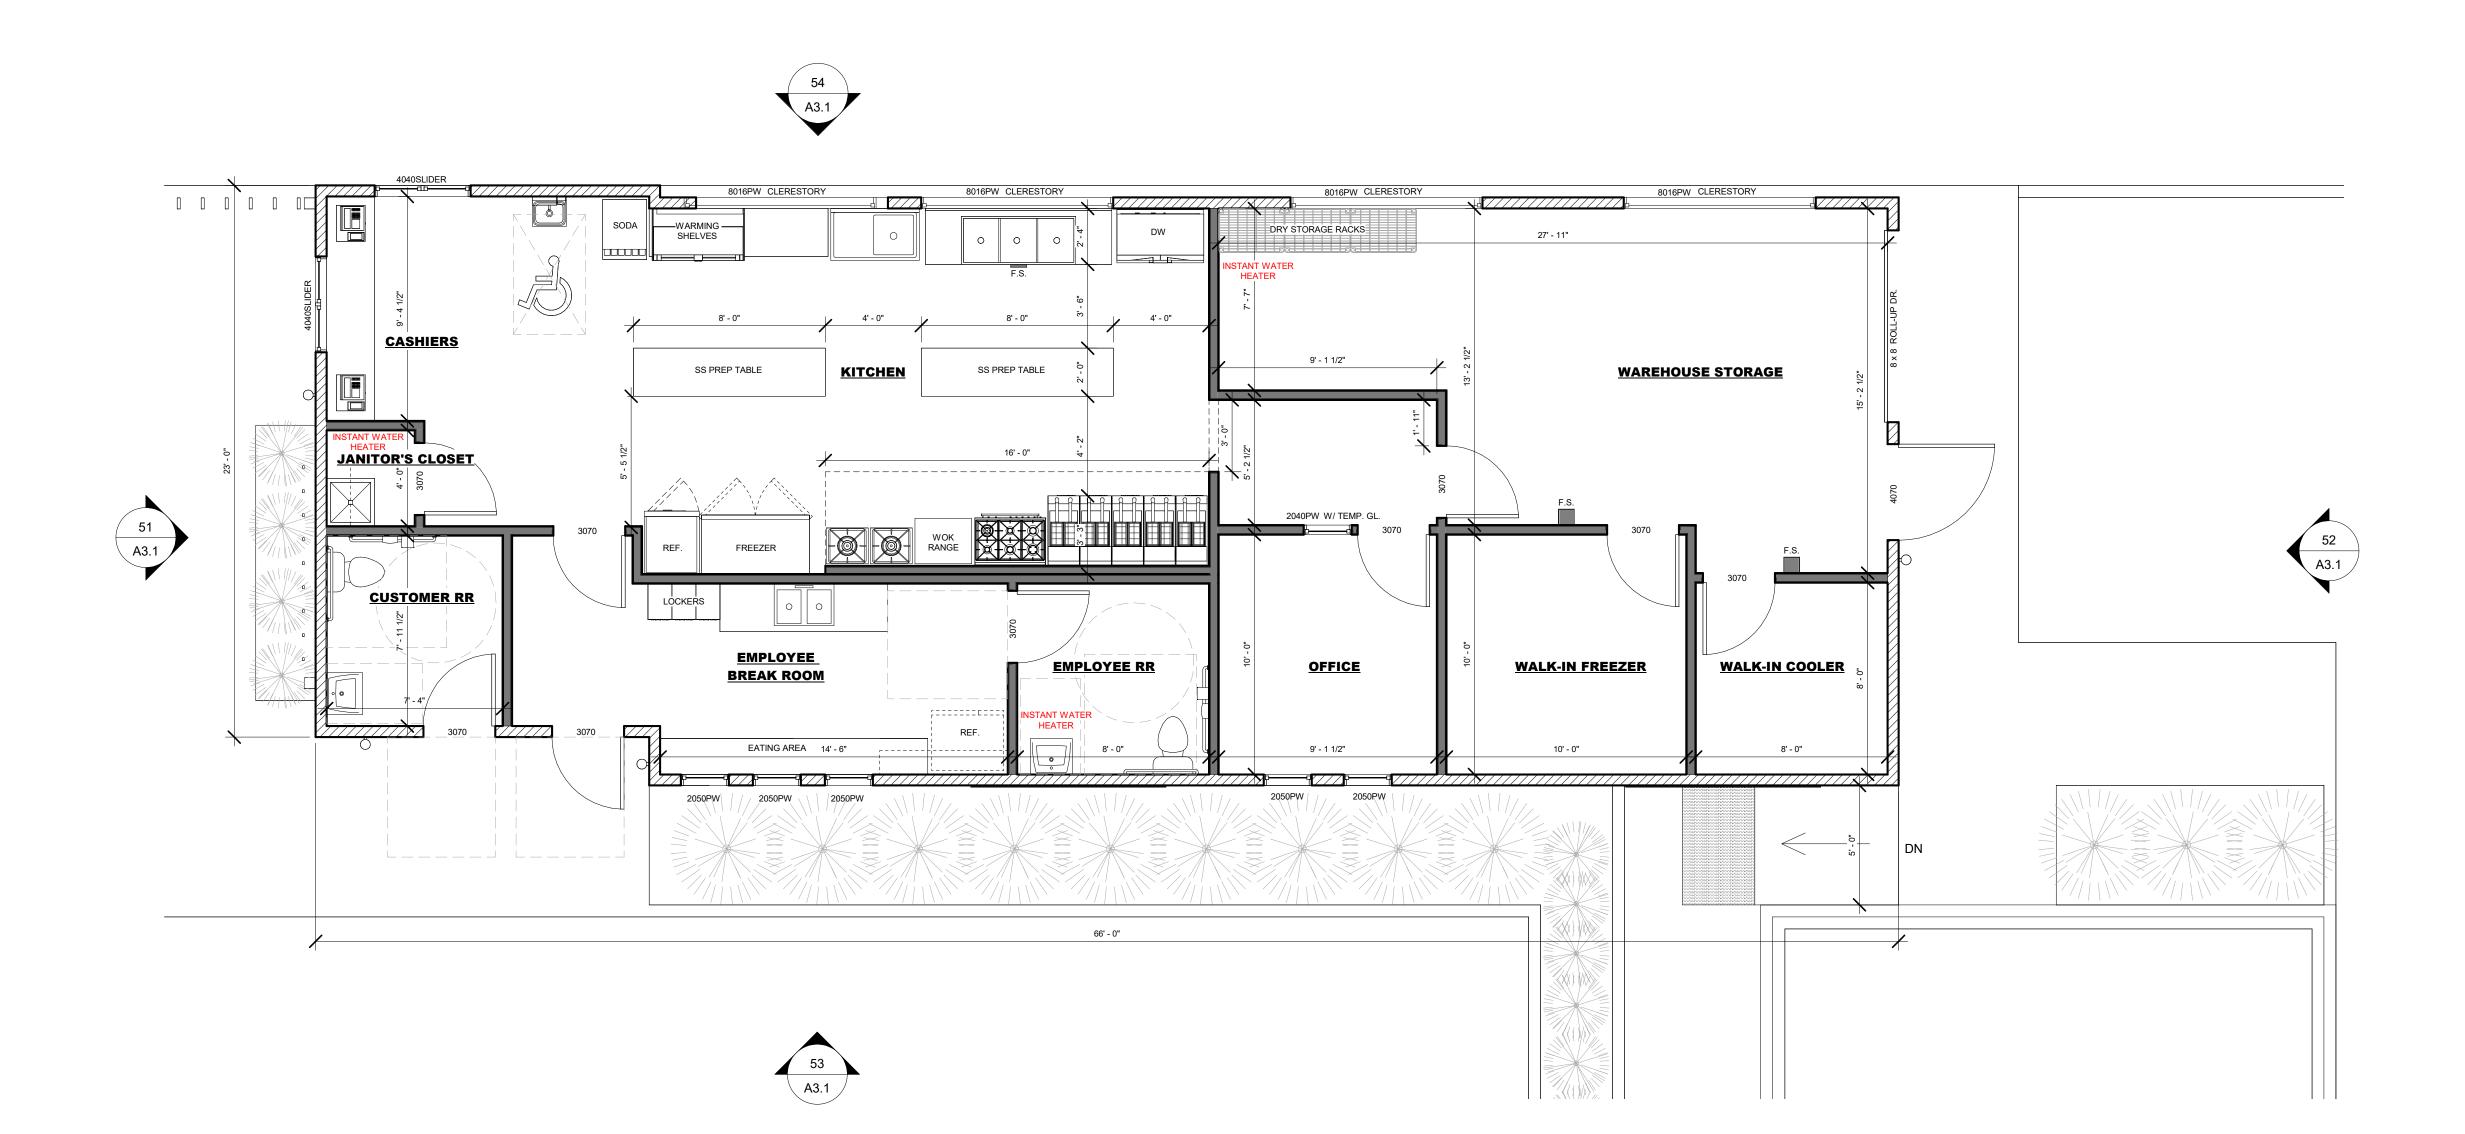

ARCHITECTURE | DESIGN

ANDREW GOODWIN DESIGNS 311 N 2ND ST. STE. B7 PORTERVILLE, CA. 93257 t: (559) 359-8789 www.PortervilleArchitect.com

> architect: andrew goodwin, aia andrew@andrewgoodwin.us principal: alex ceballos alex@alexceballos.com

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PROJECT

LADY'S CHICKEN AND RICE

519 E. HOUSTON AVE. VISALIA, CA 93292

CLIENT

BOUNLEUK AND JIMMY THONGSENG

REVISIONS

REV # REV DATE REV DESCRIPTION

SHEET TITLE

FLOOR PLAN

03/29/2023


TECHNICIAN:

PROJECT MANAGER: AC

JOB NUMBER: SHEET NUMBER

A2.1

54 FLOOR PLAN
1/4" = 1'-0"

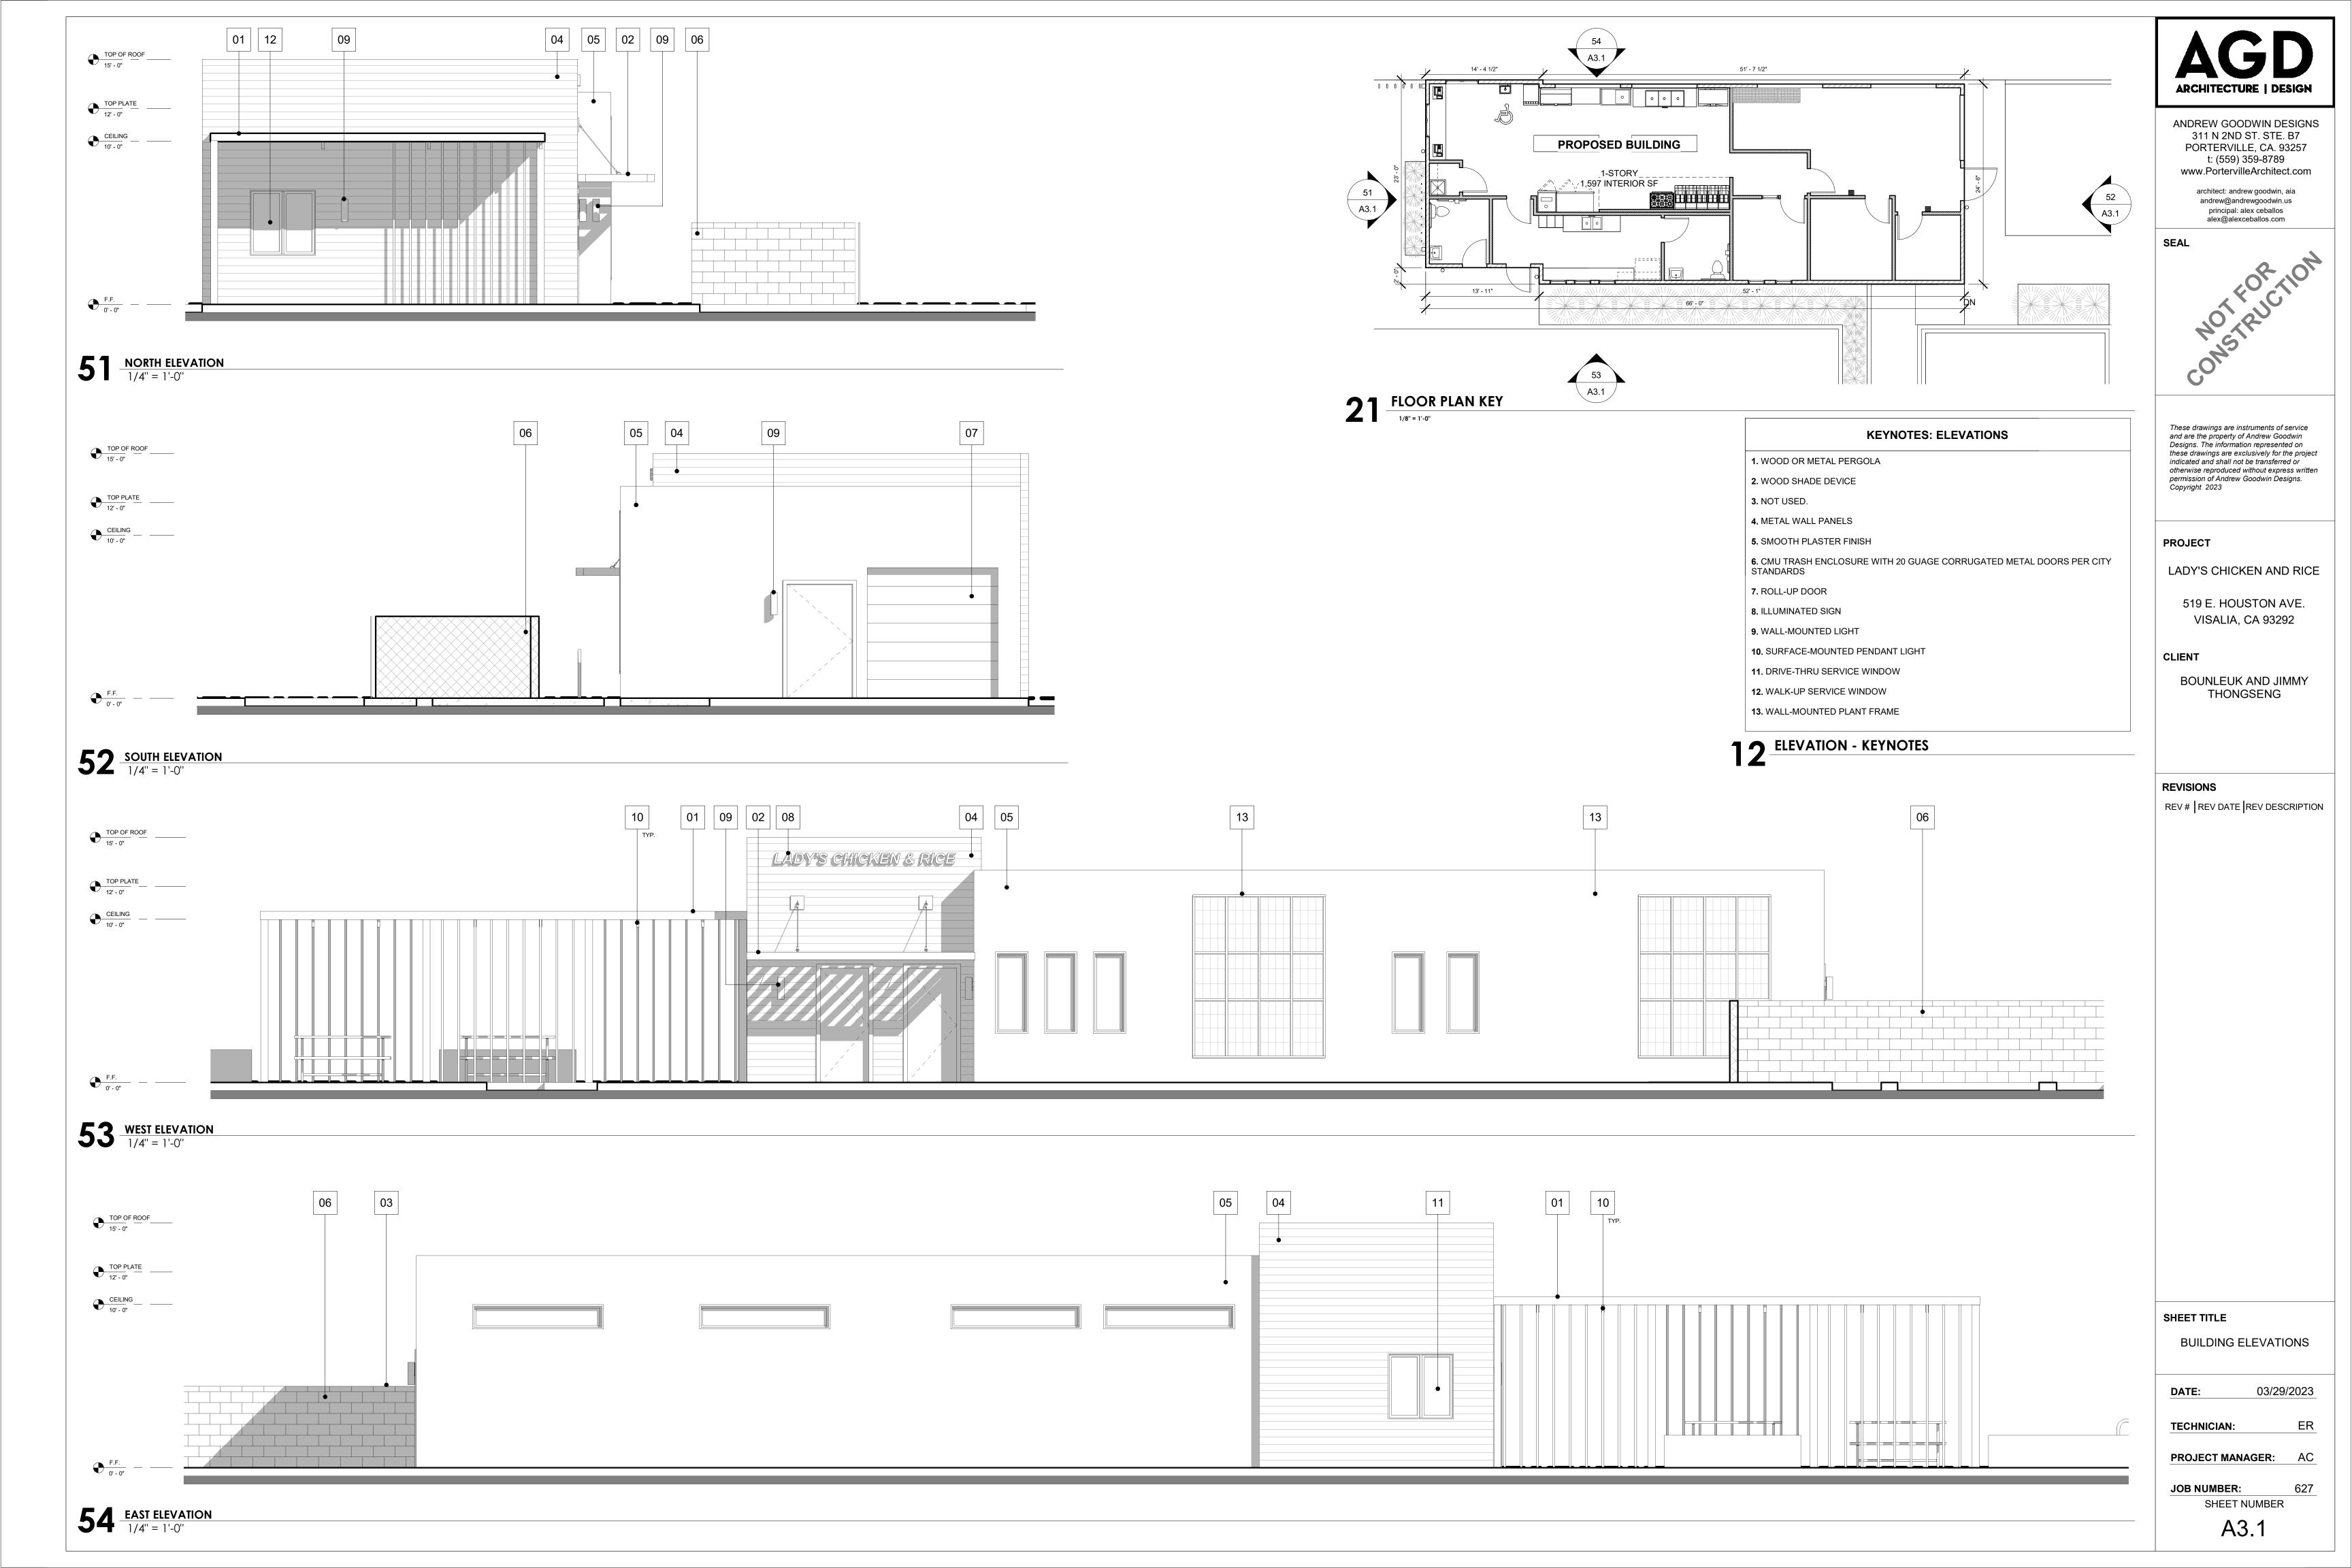







WRAPPING WOOD SHADE STRUCTURE

WOOD PERGOLA

PRECEDENT IMAGERY

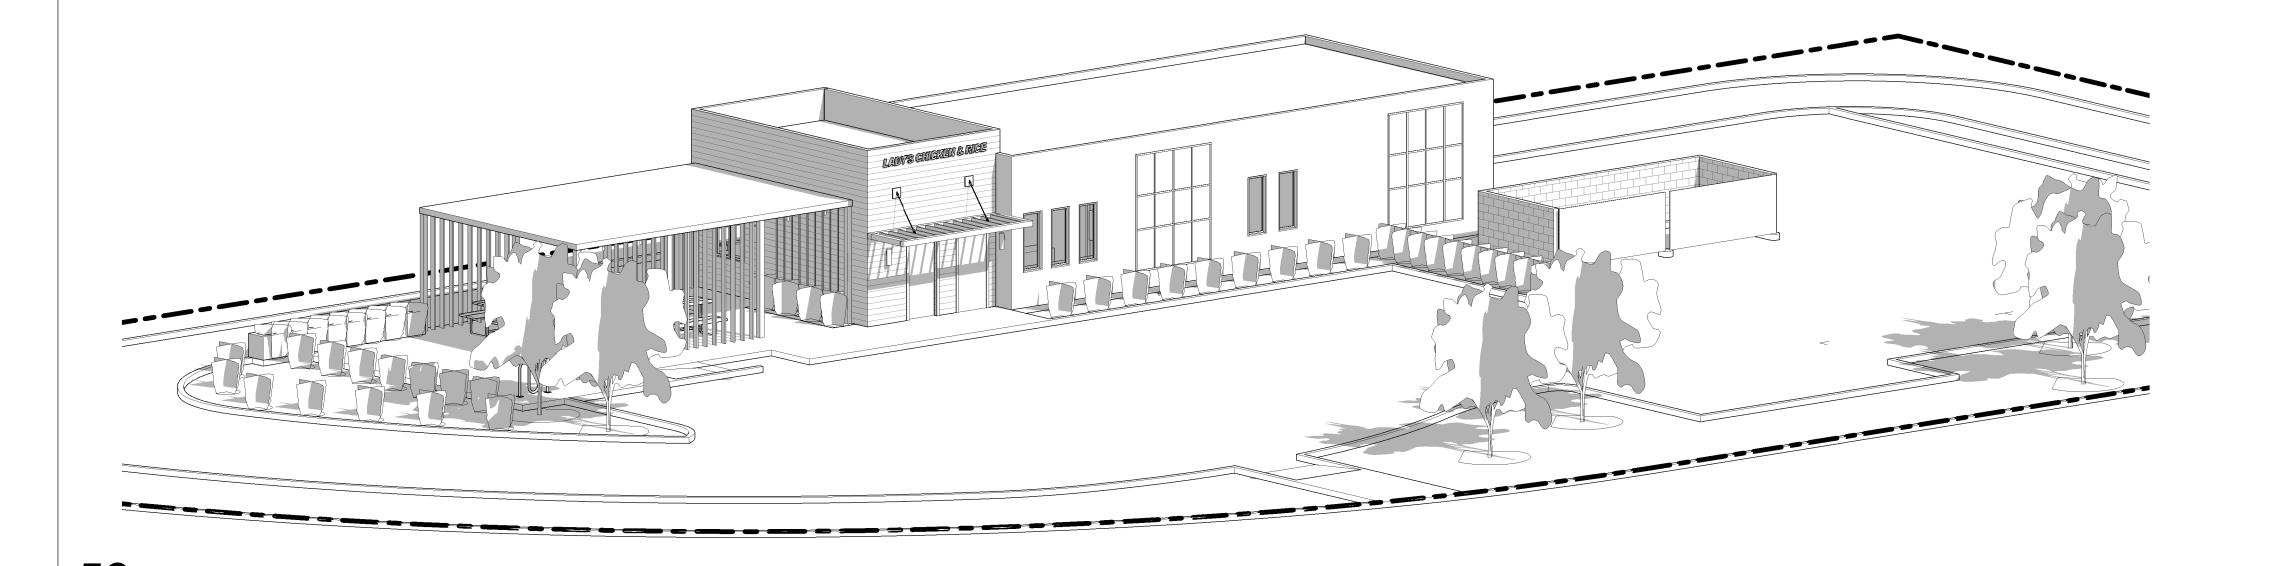

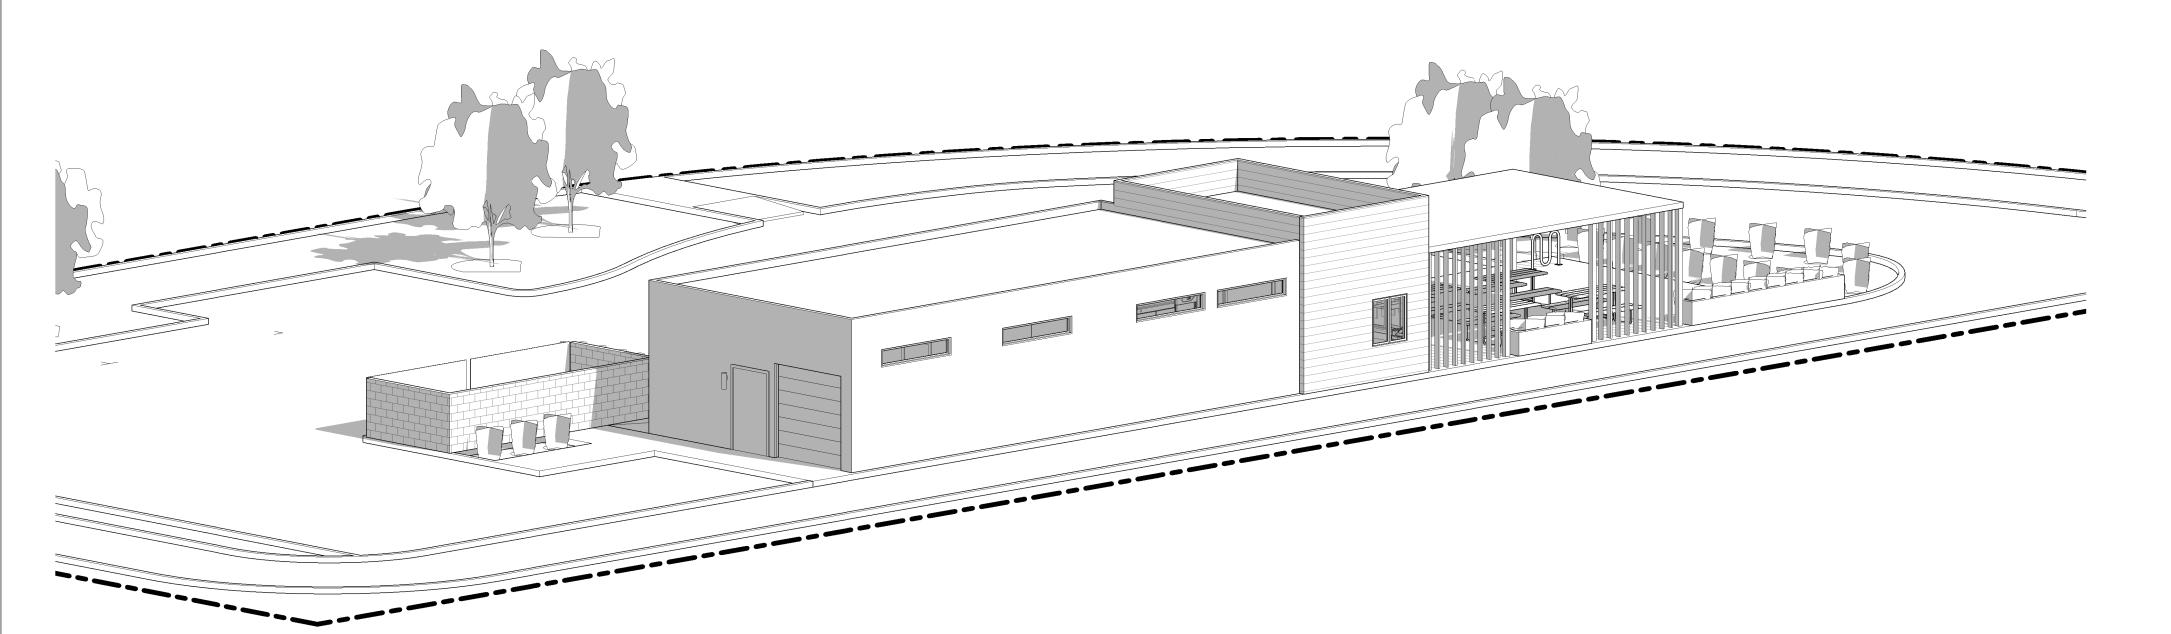

AGD

ARCHITECTURE | DESIGN

ANDREW GOODWIN DESIGNS 311 N 2ND ST. STE. B7 PORTERVILLE, CA. 93257 t: (559) 359-8789 www.PortervilleArchitect.com

> architect: andrew goodwin, aia andrew@andrewgoodwin.us principal: alex ceballos alex@alexceballos.com

SEAL

EAL WOLF FOR TION CONSTRUCTION

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PROJECT

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CLIENT

BOUNLEUK AND JIMMY THONGSENG

REVISIONS

REV# | REV DATE | REV DESCRIPTION

SHEET TITLE

3D VIEWS

DATE: 03/29/2023

TECHNICIAN:

PROJECT MANAGER:

JOB NUMBER:

SHEET NUMBER

SK-1

54 °

CITY OF VISALIA SITE PLAN REVIEW APPLICATION

Additional information and assistance in filling out this application can be found at the City of Visalia website (www.visalia.city) or by calling (559) 713-4440.



This application MUST be filled out in its entirety and submitted with an acceptable site plan (see site plan minimum requirements & submittal details on Page 2). Failure to provide all requested information may result in rejection of your application and exclusion from the Site Plan Review agenda.

Site Plan Review meetings are held on Wednesdays at 9:00 a.m. online utilizing Microsoft Teams. The applicant or representative must be present.

Application submittal deadline are Thursday at 4:00 p.m. to be scheduled for the next available meeting.

Project/Business Name: 2001 S MOONEY COMMERCIAL RETAIL BUILDING RENOVA	TION Date: 4/13/23				
Project Description: EXTERIOR FACADE AND DEMISING/REMODEL AN EXISTING 1-STOR TENANT CONFIGURATION TO ACCOMMODATE THREE (3) TENANT SUSTEIN USE; NEW UNIT 102 (908 S.F.) RETAIL USE; AND NEW UNIT 103 (2,00	SUITES: NEW UNIT 101 (3,215 S.F.) RESTAURANT				
COMPONENT. ALL PROPOSED USES ARE PERMITTED USES IN THE C-R ZONE. Site Plan Review Resubmittal: Yes No If Resubmittal, Previous Site Plan Review Number: n/a Property Owner: WEST END PARTNERS, LLC					
Project Address/Location: 2001 S MOONEY BLVD, VISALIA, CA 93277					
Assessor Parcel Number: 1 2 1 1 6 0 0 1 1	EXISTING: 6,015 S.F. WITH 108 S.F.				
	COVERED EXTERIOR ATM AREA. Square Footage: PROPOSED: 6,123 S.F. (REFLECTS ENCLOSING THE COVERED ATM ARE				
Are There Any Proposed Building Modifications: Yes 🚫 No 🔘	THIS AREA FOR CITY STAFF USE ONLY				
Estimated Cost of Modifications to Building: \$ TBD	Date Received: 04/13/2023				
Describe All Proposed Building Modifications:	SPR Agenda: <u>04/19/2023</u> Item No				
NEW INTERIOR DEMISING WALLS, EXTERIOR FACADE ENHANCEMENTS	Zone: <u>C-R</u> SPR No. <u>23-62</u>				
INCLUDING NEW INDIVIDUAL TENANT STOREFRONT ENTRIES, UPGRADE UTILITIES, RE-USE OF EXISTING PYLON SIGN, REFURBISH LANDSCAPING.	Historic District: Yes No				
	Flood Zone: X X AE X/AE				
A SEPARATE, DETAILED OPERATIONAL STATEMENT IS HIGHLY RECOM	MMENDED FOR ALL SUBMITTALS				
xisting/Prior Building Use: BANK (COMMERCIAL USE)					
NEW UNIT 101 (3,215 S.F.) RESTAURANT USE; NEW UNIT 102 (908 Proposed Building Use: RESTAURANT USE. NO DRIVE-THRU COMPONENT. ALL PROPOS	3 S.F.) RETAIL USE; AND NEW UNIT 103 (2,000 S.F.) BED USES ARE PERMITTED USES IN THE C-R ZONE.				
Proposed Hours of Operation: MON-SAT: 7AM - 10PM, SUN: 7AM-8PM					
Days of Week In Operation (Circle): Su M T W Th F Sa					
Number of Employees Per Day: PRIOR BANK HAD ON AVG. Existing 15 EMPLOYEES PER DAY Propose	ed UNIT 101: 8 EMPLOYEES/DAY, UNIT 102: 2 EMPLOYEES/DAY, UNIT 103: 4 EMPLOYEES/DAY (TOTAL 14 EMPLOYEES/DAY				
Number of Customers Per Day (Estimated): Existing Customers Per Day Propose	ed UNIT 101: +/-80 CUSTOMERS, UNIT 102: +/-40 CUSTOMERS, UNIT 103: +/-80 CUSTOMERS (TOTAL: +/-200 CUSTOMERS)				
Predicted Peak Operating Hour: 5PM	W D OCCUP DEFENDE MODUMO WEEK DAY				
Describe Any Truck Delivery Schedule & Operations: TRUCK DELIVERY SCHEDULE WOULD OCCUR BEFORE MORNING WEEKDAY BUSINESS HOURS.					
lease Identify Any Unique or Specific Traffic Patterns That Will Require Accommodations For Operations, Customers, or Employees NO UNIQUE OR SPECIAL TRAFFIC PATTERNS REQUIRED TO ACCOMMODATE OPERATIONS,					
	TE THAT PER THE SHARED PARKING / CROSS ROPERTY HAS THE RIGHT TO USE THE EXISTING				
Describe Any Special Events Planned for the Facility: NO SPECIAL EVENTS PLANNED FO	OR THE FACILITY				
Page 1 of 2 - Application continues on back of	this page				

	SITE PLAN MINIMUM REQUIREMENTS					
	Submit a digital copy of the site plan(s) and completed application on a flash drive or equivalent (PDF format preferred, hard paper copies					
NTS	not accepted).					
REME	Digital copies must be clear, legible, and on a layout sized appropriately to convey all necessary project information.					
SITE PLAN REQUIREMENTS	Site plan shall provide for and indicate all of the following: North arrow All existing & proposed site features Site dimensions, including building Existing and proposed fencing at site Public improvements (curbs, sidewalks, utility poles, hydrants, street lights, etc.) Site plan shall provide for and indicate all of the following: Existing & proposed structures Accessible path of travel from ADA stall Accessible path of travel from ADA stall Cocation and width of drive approaches to site Existing & proposed landscaping utility poles, hydrants, street lights, etc.) Parking stalls (include ADA) Tentative maps shall adhere to requirements of Visalia Municipal Code Section 16					
	Applicant Information (Final comments will be mailed to the name and address provided below)					
REQUIRED SIGNATURE	Name: MATT NOHR Address: 10 HARRIS COURT, SUITE B-1 City, State, Zip MONTEREY, CA 93940 Phone: (831) 649-0220 Email: MNOHR@OROSCOGROUP.COM * If signed by an authorized agent, the "Agency Authorization" information below must be completed for this application to be considered acceptable.					
	AGENCY AUTHORIZATION					
AGENCY AUTHORIZATION FORM	OWNER: I, CHRIS OROSCO , declare as follows; I am the owner of certain real property bearing assessor's parcel number (APN): 1 2 1-1 6 0 -0 1 1					
	AGENT: I designate MATT NOHR , to act as my duly authorized agent for all purposes necessary to file an application for, and obtain a permit to 2001 S MOONEY BLVD, VISALIA, CA relative to the property mentioned herein.					
ATIC	I declare under penalty of perjury the foregoing is true and correct.					
THORIZ	Executed this13 day ofAPRIL, 20 <u>23</u>					
ICY AU	OWNER Signatures AGENT					
AGENC	Signature of Owner 10 HARRIS COURT, SUITE B-1 Owner Mailing Address MONTEREY, CA 93940 Signature of Agent Mailing Address MONTEREY, CA 93940 MONTEREY, CA 93940					
	Owner Phone Number Agent Phone Number (831) 649-0220 (831) 649-0220					

Page 2 of 2



WEST END PARTNERS, LLC 10 HARRIS COURT, SUITE B-1

MONTEREY, CÁ 93940 (831) 649-0220

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SPECIFICATIONS, AND/OR DESIGNS ARE FOLLOWED WITHOUT THE PROFESSIONAL'S GUIDANCE WITH AMBIGUITIES, OR CONFLICTS WHICH ARE ALLEGED.

MOONEY COMMERCIAL BUILDING RENOVATION PROJECI NAIV
2001 S
RETAIL

PROJECT #: 23-003 ISSUE DATE: 4 - 12 - 2023 DRAWING BY: AGL CHECKED BY: MN / PO

	F	REVIS	ION SCHEDULE		
REV	DATE	BY	DESCRIPTION		
1			Check Set		
2					
3					
4					

SHEET TITLE:


SCALE:


TITLE SHEET

1" = 40'-0"

SHEET NUMBER:


A0.01

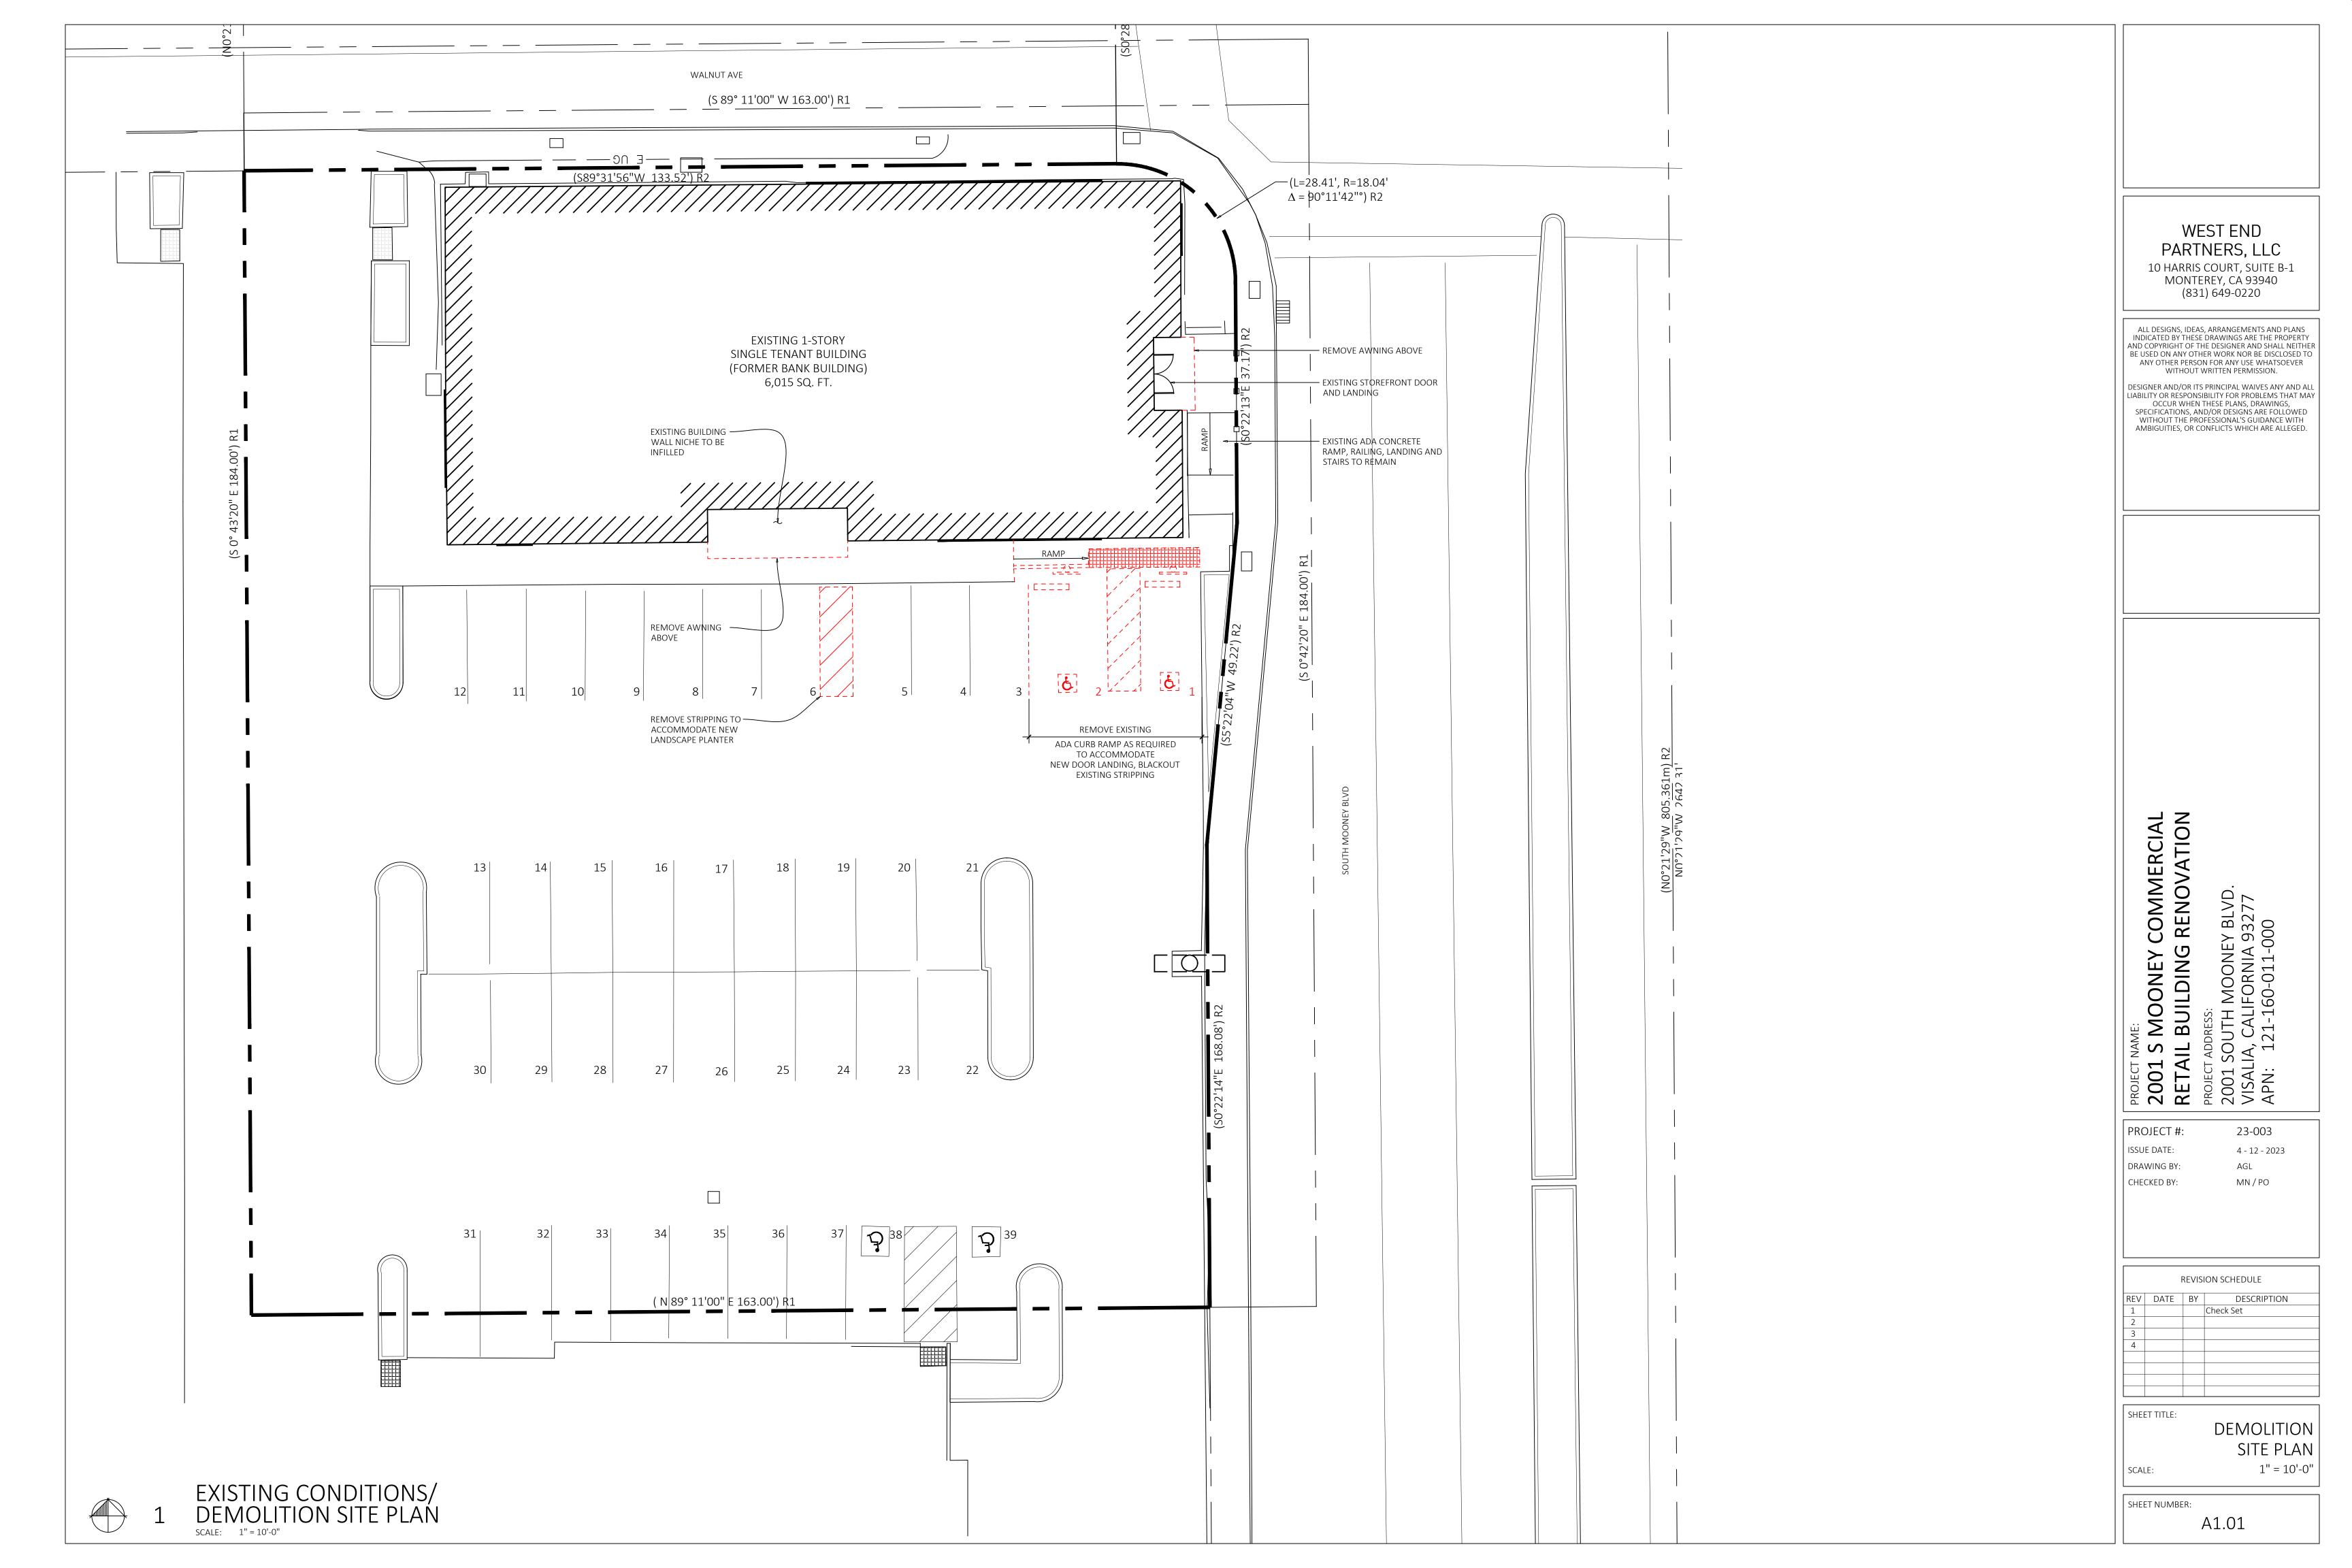

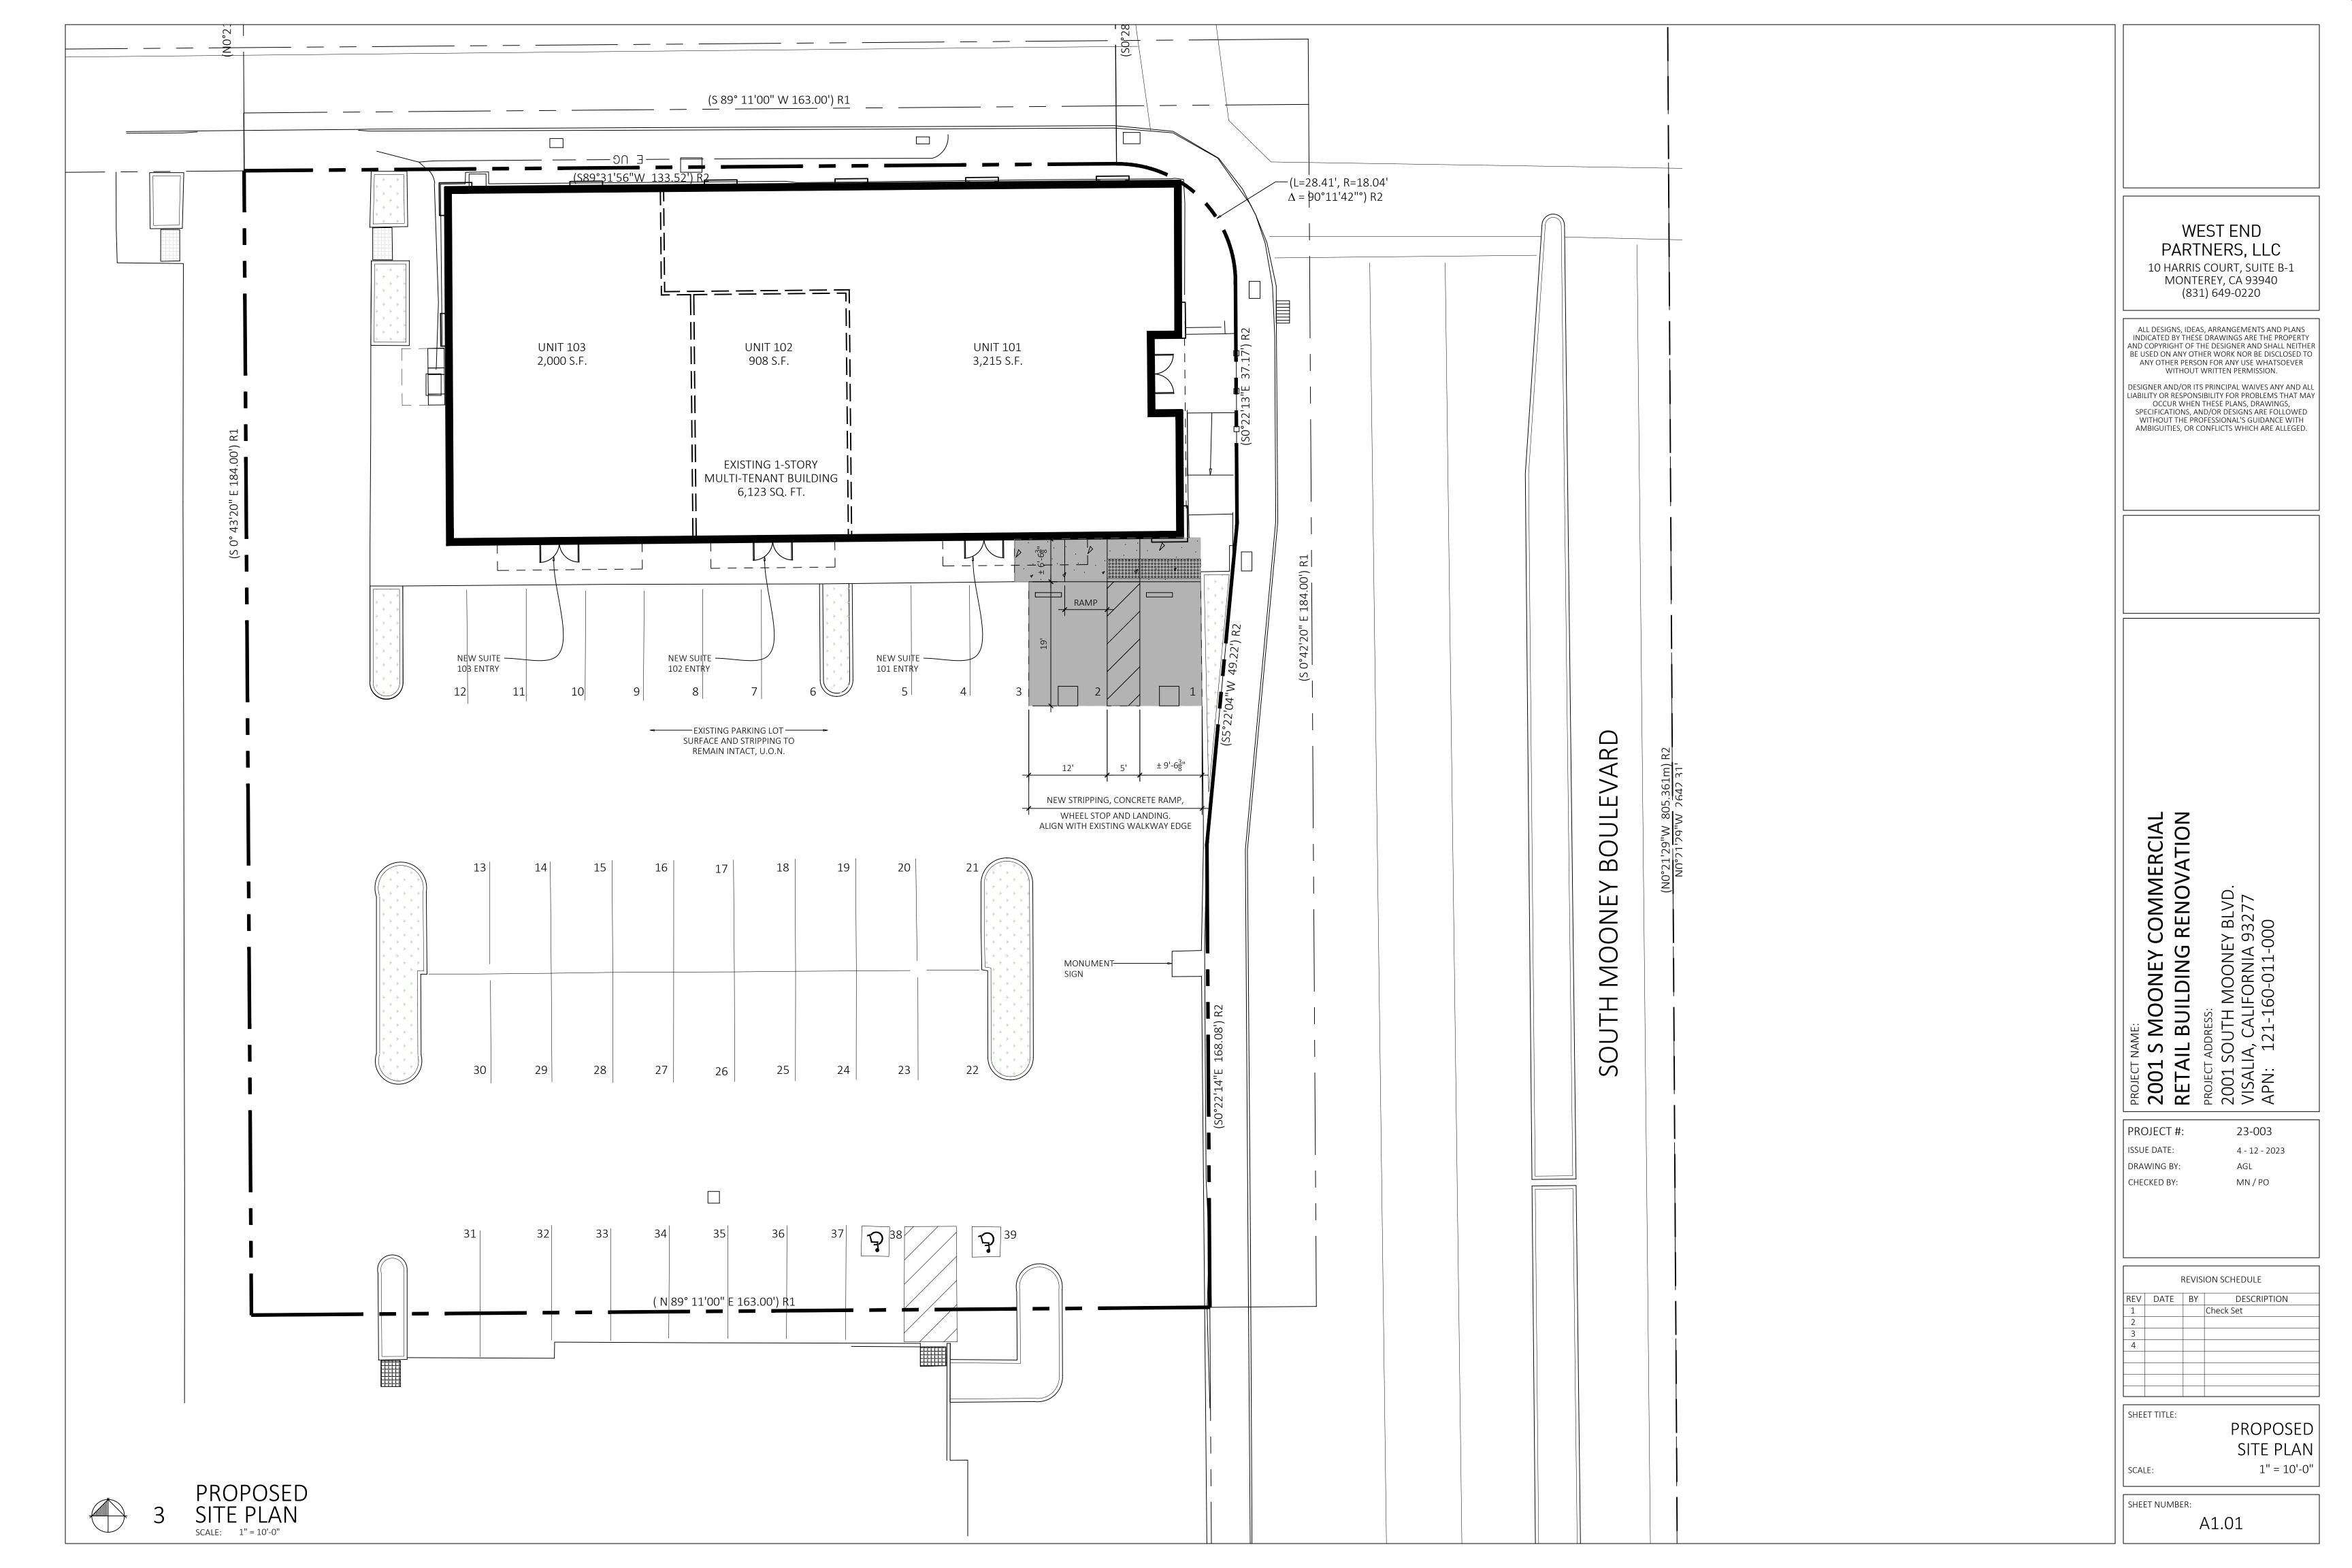

✓ WEST WALNUT AVE-----> OPEN OFFICE AREA WOMEN RESTROOM OPEN OFFICE AREA 7'-8" 22'-2" 21'-6" 23'-8" 13'-8" 22'-4" 20'-2" 10'-2" 112'-8" **EXISTING AREA** 6,015 SF

EXISITNG CONDITION / DEMOLITION FLOOR PLAN

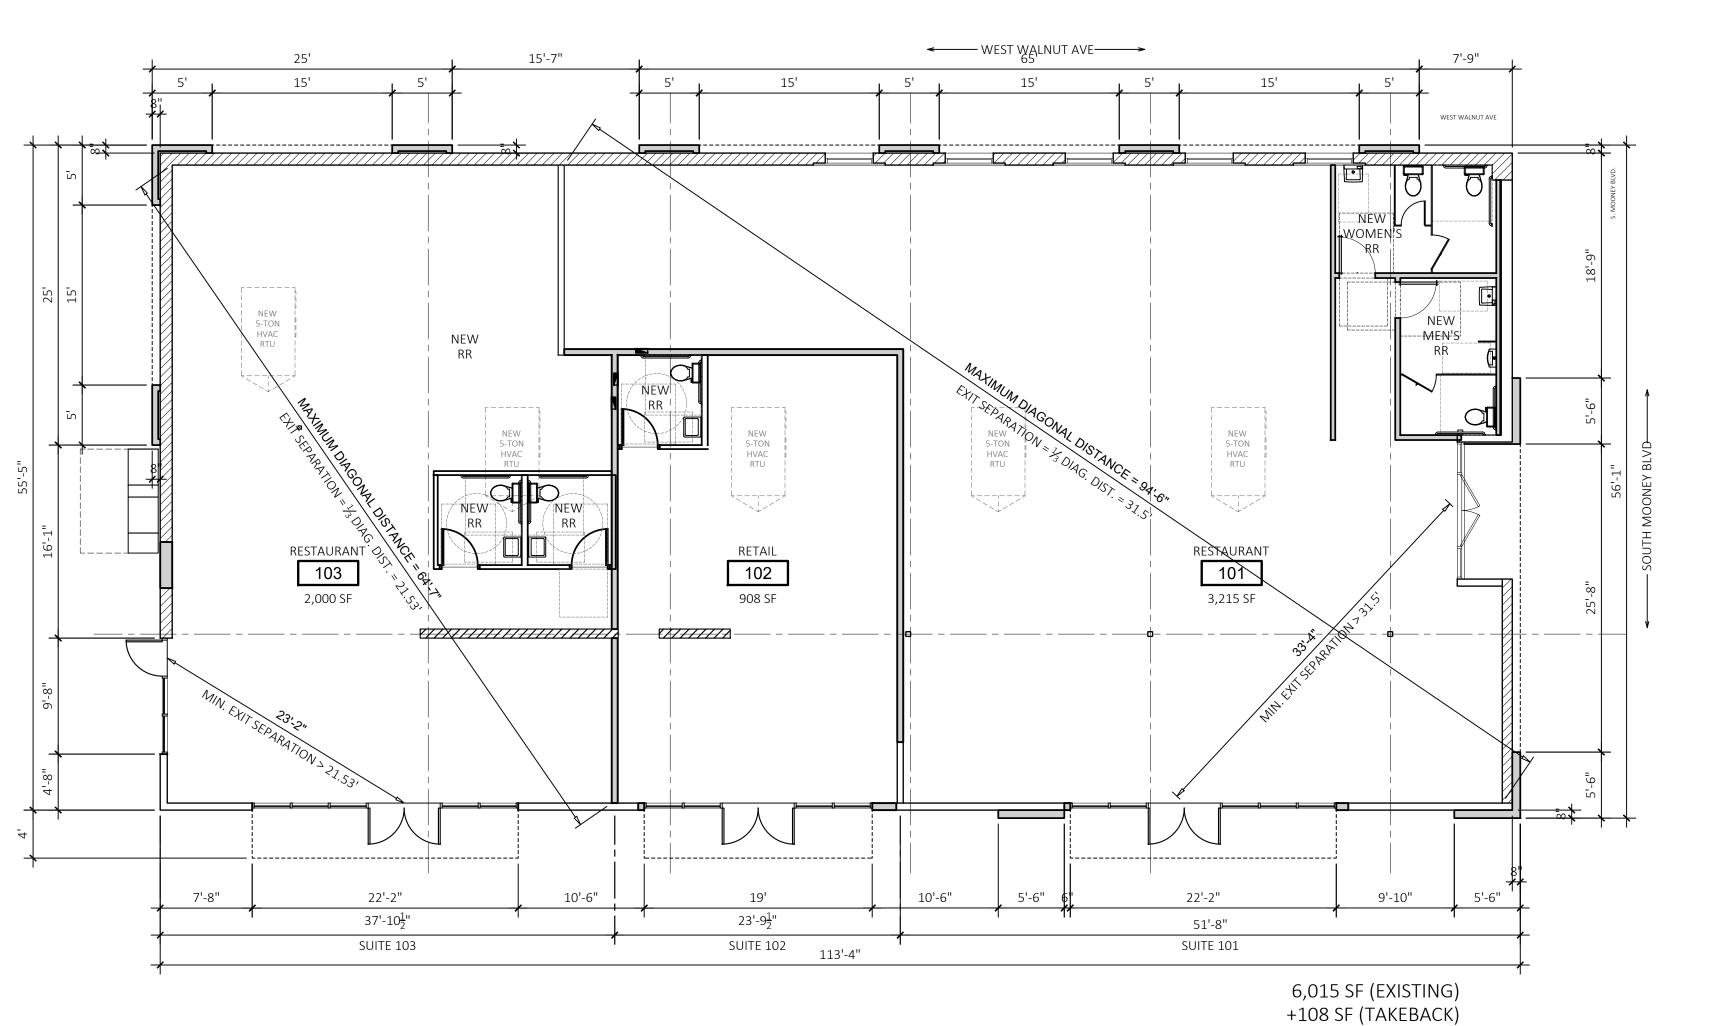

6,123 SF TOTAL

NEW

KEYED NOTES

WEST END PARTNERS, LLC 10 HARRIS COURT, SUITE B-1 MONTEREY, CA 93940 (831) 649-0220

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PROJECT NAME:
2001 S MOONEY COMMERCIAL
RETAIL BUILDING RENOVATION


PROJECT #:

ISSUE DATE:

DRAWING BY:

CHECKED BY:

FLOOR PLAN GRAPHICS LEGEND

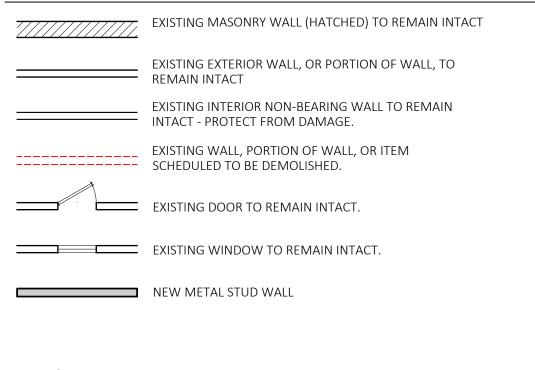

<u> </u>	NEW DOOR	

NEW STOREFRONT WINDOW

REVISION SCHEDULE REV DATE BY DESCRIPTION Check Set

23-003

MN / PO

AGL


4 - 12 - 2023

DEMOLITION AND PROPOSED SITE PLAN 1/8" = 1'-0"

SHEET NUMBER:

A2.01

PROPOSED DEMISING FLOOR PLAN

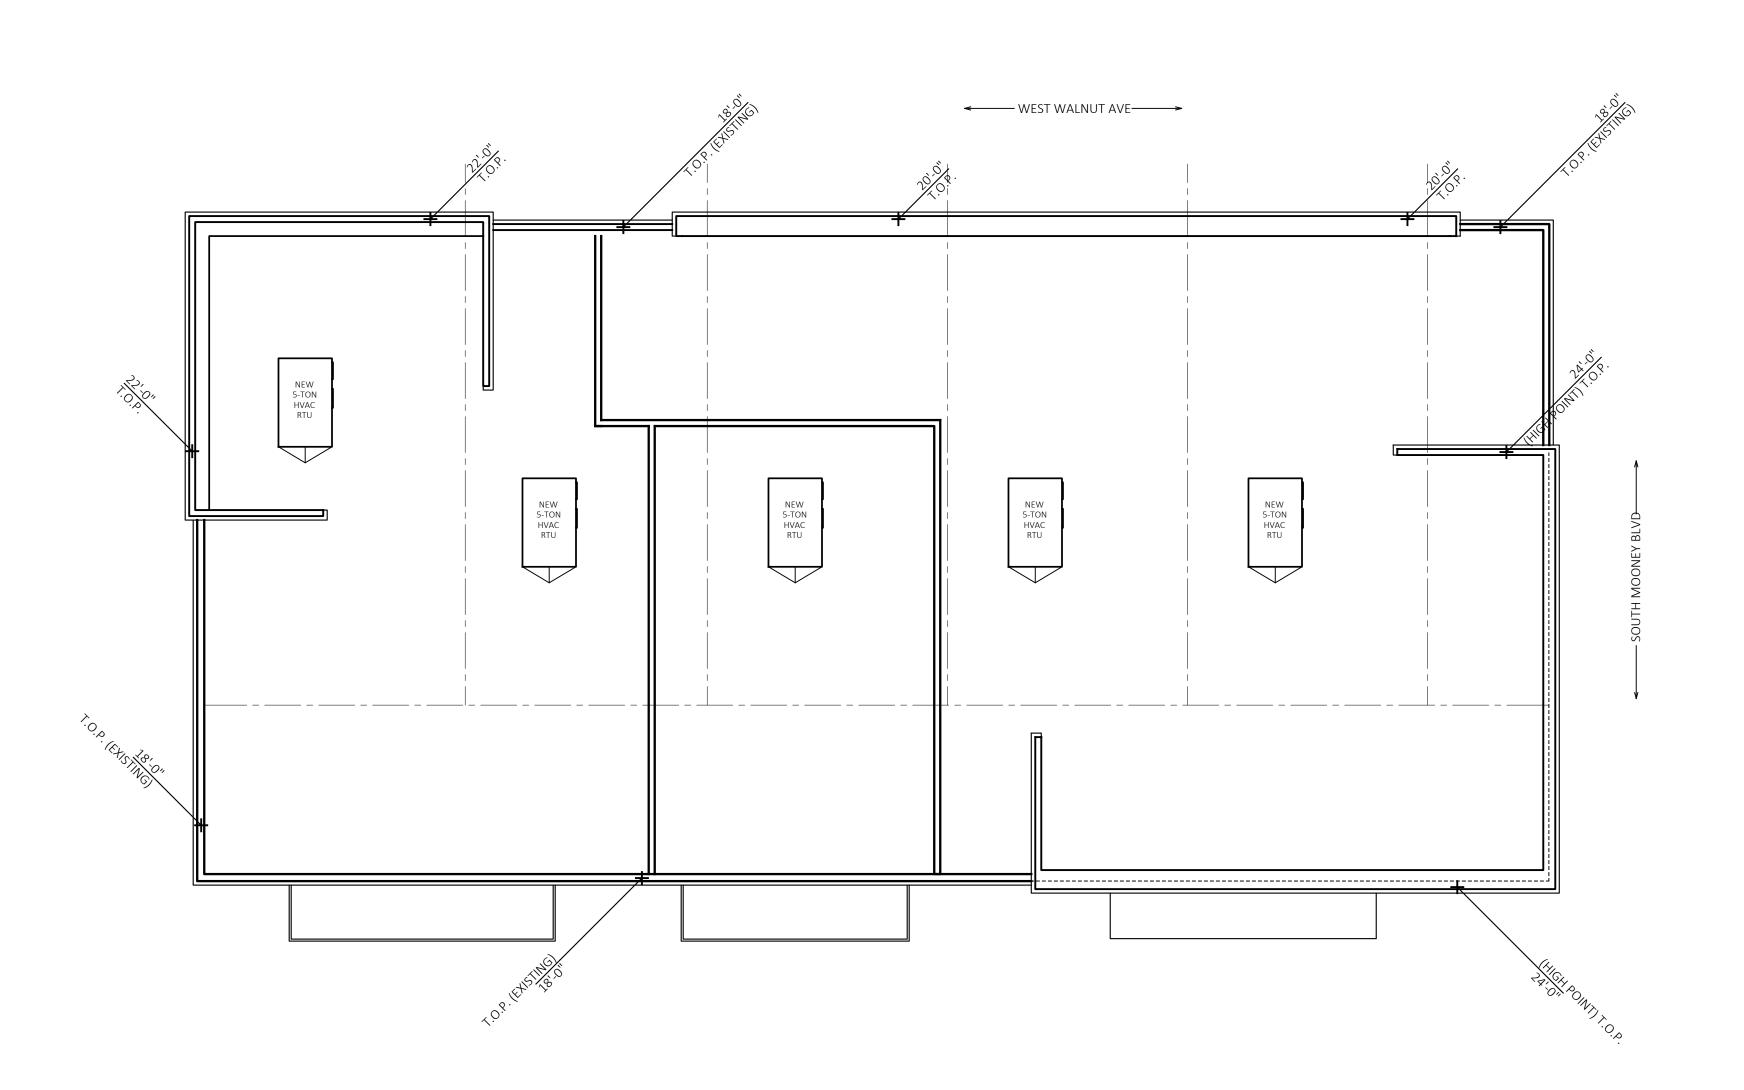

WEST END
PARTNERS, LLC

10 HARRIS COURT, SUITE B-1 MONTEREY, CA 93940 (831) 649-0220

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PROJECT NAME:

2001 S MOONEY COMMERCIAL
RETAIL BUILDING RENOVATION
PROJECT ADDRESS:
2001 SOUTH MOONEY BLVD.
VISALIA, CALIFORNIA 93277
APN: 121-160-011-000

 PROJECT #:
 23-003

 ISSUE DATE:
 4 - 12 - 2023

 DRAWING BY:
 AGL

 CHECKED BY:
 MN / PO

REVISION SCHEDULE

REV DATE BY DESCRIPTION

1 Check Set

2 3 4

SHEET TITLE: ROOF PLAN

SCALE: 1/8" = 1'-0"


A2.20

SHEET NUMBER:

POOF PLAN
SCALE: 1/8" = 1'-0"



SOUTH ELEVATION - PROPOSED

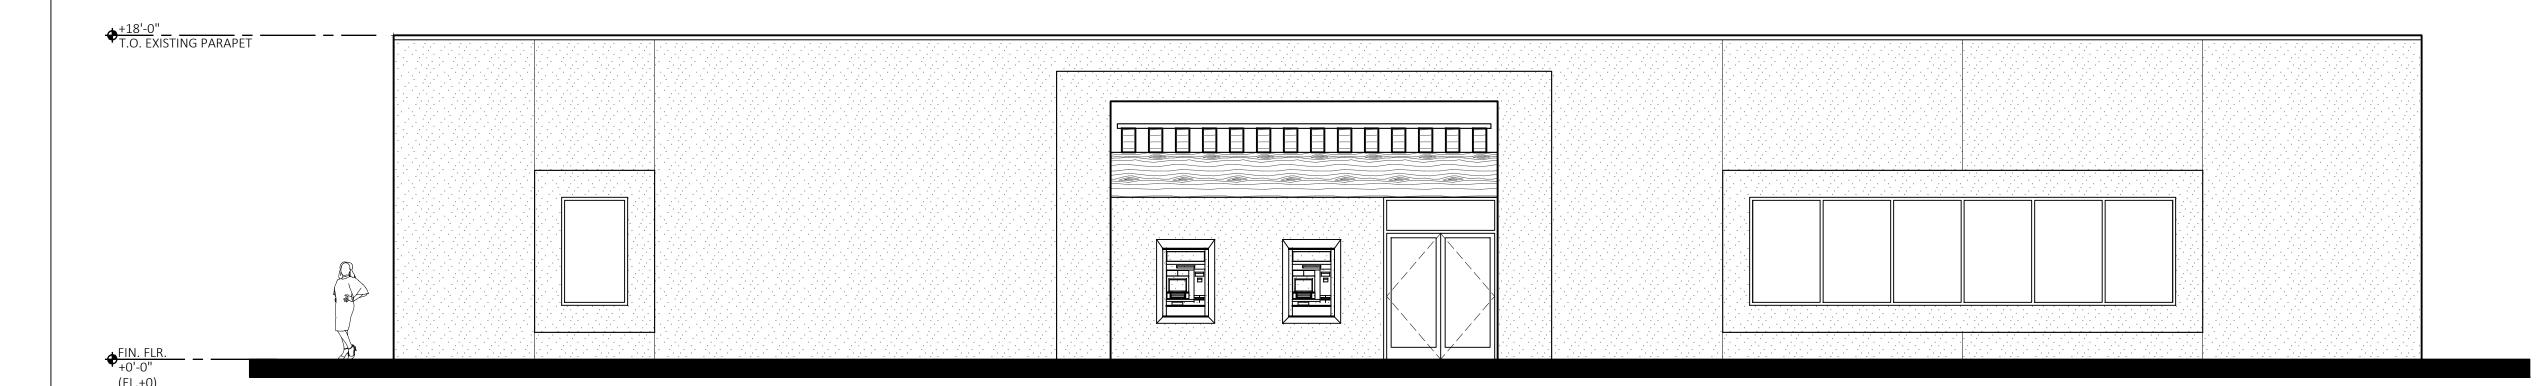

SOUTH ELEVATION - EXISTING
SCALE: 1/4"=1'-0"

TYPE NUMBER DESCRIPTION

NUMBER	DESCRIPTION
09-02	PLASTER CONTROL JOINT
10-03	SIGNAGE BY TENANT, UNDER SEPARATE PERMIT
26-01	WALL MOUNTED EXTERIOR LIGHT FIXTURE. SEE ELECTRICAL DRAWINGS.

EXTERIOR MATERIAL SCHED.

TL-01		TILE WALL CLADDING; KENRIDGE RIBBON MAI
		24x48 PORCELAIN TILE
PS-01		PAINTED EXISTING CEMENT PLASTER
PS-02	09 24 00	PAINTED CEMENT PLASTER
GLAZING		
GI -01	08 80 00	CLEAR GLAZING, NON-TINTED,
GL 01	00 00 00	NON-REFLECTIVE, DOUBLE GLAZED
		AND LOW-E. SEE SPECS.
METAL		
	00 41 12	ALLIA AINILIA A CTOREERONIT CVCTEA A
MT-01	08 41 13	ALUMINUM STOREFRONT SYSTEM
MT-02	05 12 00	METAL CANOPY
MT-03	09 22 16	METAL FURRING
MT-04	07 62 00	SHEET METAL COPING

EXTERIOR COLOR SCHED.

TYPE	DESCRIPTION
EXTERIO	OR PAINT
P01	TBD
P02	TBD
P03	TBD
P04	TBD

WEST END PARTNERS, LLC

10 HARRIS COURT, SUITE B-1 MONTEREY, CÁ 93940 (831) 649-0220

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PROJECT NAME:
2001 S MOONEY COMMERCIAL
RETAIL BUILDING RENOVATION

CHECKED BY:

PROJECT #: 23-003 ISSUE DATE: 4 - 12 - 2023 DRAWING BY: AGL

MN / PO

REVISION SCHEDULE Check Set

REV DATE BY DESCRIPTION

EXISTING & PROPOSED SOUTH ELEVATIONS 3/16" = 1'-0"

SHEET NUMBER:



EAST ELEVATION - PROPOSED SCALE: 1/4"=1'-0"



WEST END PARTNERS, LLC

10 HARRIS COURT, SUITE B-1 MONTEREY, CA 93940 (831) 649-0220

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KEY NOTES

TYPE NUMBER DESCRIPTION

NUMBER	DESCRIPTION
09-02	PLASTER CONTROL JOINT
10-03	SIGNAGE BY TENANT, UNDER SEPARATE PERMIT
26-01	WALL MOUNTED EXTERIOR LIGHT FIXTURE. SEE
	ELECTRICAL DRAWINGS.

EXTERIOR MATERIAL SCHED.

FINISH SY	STEM	
TL-01		TILE WALL CLADDING; KENRIDGE RIBBON MAPLE 24x48 PORCELAIN TILE
PS-01		PAINTED EXISTING CEMENT PLASTER
PS-02	09 24 00	PAINTED CEMENT PLASTER
GLAZING		
GL-01	08 80 00	CLEAR GLAZING, NON-TINTED, NON-REFLECTIVE, DOUBLE GLAZED AND LOW-E. SEE SPECS.
METAL		
MT-01	08 41 13	ALUMINUM STOREFRONT SYSTEM
MT-02	05 12 00	METAL CANOPY
MT-03	09 22 16	METAL FURRING
MT-04	07 62 00	SHEET METAL COPING

EXTERIOR COLOR SCHED.

EXTERIO	OR PAINT		
P01	TBD		
P02	TBD		
P03	TBD		
P04	TBD		

PROJECT NAME: 2001 S MOONEY COMMERCIAL RETAIL BUILDING RENOVATION

PROJECT #:

ISSUE DATE:

DRAWING BY:

CHECKED BY:

	REVISION SCHEDULE					
EV	DATE	BY	DESCRIPTION			
L			Check Set			
2						
3						
1						

23-003

MN / PO

AGL

4 - 12 - 2023

SHEET TITLE:

EXISTING & PROPOSED

EAST ELEVATIONS

SCALE: 3/16" = 1'-0"

SHEET NUMBER:



NORTH ELEVATION - PROPOSED

SCALE: 1/4"=1'-0"

NORTH ELEVATION - EXISTING

KEY NOTES

TYPE NUMBER DESCRIPTION

DESCRIPTION
PLASTER CONTROL JOINT
SIGNAGE BY TENANT, UNDER SEPARATE PERMIT
WALL MOUNTED EXTERIOR LIGHT FIXTURE. SEE
ELECTRICAL DRAWINGS.

EXTERIOR MATERIAL SCHED.

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EXTERIOR COLOR SCHED.

TYPE	DESCRIPTION	
EXTERIO	OR PAINT	
P01	TBD	
P02	TBD	
P03	TBD	
P04	TBD	

WEST END PARTNERS, LLC

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PROJECT NAME:
2001 S MOONEY COMMERCIAL
RETAIL BUILDING RENOVATION

PROJECT #: 23-003 ISSUE DATE: 4 - 12 - 2023 DRAWING BY: AGL CHECKED BY: MN / PO


REVISION SCHEDULE					
REV	DATE	BY	DESCRIPTION		
1			Check Set		
2					
3					
4					

EXISTING & PROPOSED NORTH ELEVATIONS 3/16" = 1'-0"

SHEET NUMBER:



WEST ELEVATION - PROPOSED
SCALE: 1/4"=1'-0"

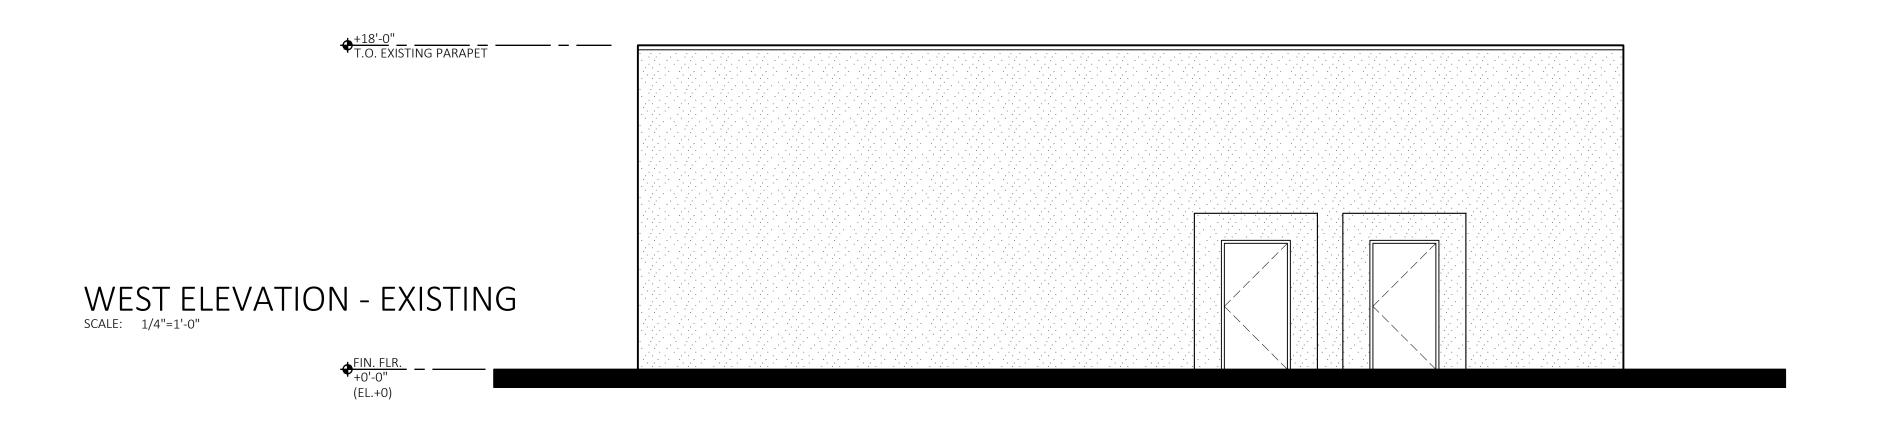

WEST END PARTNERS, LLC 10 HARRIS COURT, SUITE B-1

MONTEREY, CÁ 93940 (831) 649-0220

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EXTERIO	OR PAINT		
P01	TBD		
P02	TBD		
P03	TBD		
P04	TBD		

PROJECT NAME: 2001 S MOONEY COMMERCIAL RETAIL BUILDING RENOVATION

ISSUE DATE:

DRAWING BY:

CHECKED BY:

REVISION SCHEDULE

REV DATE BY DESCRIPTION

1 Check Set

2 3 4

23-003

AGL

MN / PO

4 - 12 - 2023

SHEET TITLE:

EXISTING & PROPOSED

WEST ELEVATIONS

SCALE: 3/16" = 1'-0"

SHEET NUMBER:













WEST END PARTNERS, LLC

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2001 S MOONEY COMMERCIAL RETAIL BUILDING RENOVATION

PROJECT #: ISSUE DATE:

DRAWING BY: CHECKED BY:

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REV	DATE	BY	DESCRIPTION
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23-003

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4 - 12 - 2023

3D RENDERINGS

SHEET NUMBER:

A4.01