SITE PLAN REVIEW AGENDA

2/15/2023 - 9:00 A.M. (Via Microsoft Teams)

To review supporting documents, click on the "SITE PLAN NO" link, then click on "Record Info" / "Attachments"

ITEM NO: 1 Resubmit
SITE PLAN NO: SPR22172

PROJECT TITLE: King's Petroleum LLC

DESCRIPTION: New 32' x 78' 4" Fuel Island Canopy, 6 Pumps and 2 Above Ground 12,000 Gallon Fuel Storage Tanks.

(C-S/QP)

APPLICANT: Logan Couch

OWNER: UNION PACIFIC RAILROAD CO

APN: 094190017

LOCATION: 205 N BEN MADDOX WAY

ITEM NO: 2 Added to Agenda

SITE PLAN NO: SPR23019

PROJECT TITLE: Derrel's Mini Storage

DESCRIPTION: Expansion of Existing Facility - Satellite

APPLICANT: Greg Dowds

OWNER: BOOKOUT KENNETH (TR MG FAMILY TRUS'

APN: 098050023

LOCATION: 1716 E GOSHEN AVE

ITEM NO: 3 Added to Agenda

SITE PLAN NO: SPR23020

PROJECT TITLE: Derrel's Mini Storage 2

DESCRIPTION: Expansion of Existing Facility on 8 acres, Connecting Existing Facility to New Section. (C-N/R-M-3)

APPLICANT: Greg Dowds

OWNER: BOOKOUT KENNETH (TR MG FAMILY TRUST

BOOKOUT KENNETH (TR MB FAMILY TRUS)

JONES GARREL LEE

APN: 098050035

098050038 098050023

LOCATION: 1716 E GOSHEN AVE

ITEM NO: 4 Added to Agenda

SITE PLAN NO: SPR23021

PROJECT TITLE: T-Mobile Wireless Communications Facility

DESCRIPTION: Proposed Installation of an Emergency Standby (back-up) Generator at an Existing T-Mobile Wireless

Communications Facility. (C-MU)

APPLICANT: Jeff Lienert

OWNER: LPHED LIMITED PARTNERSHIP

APN: 126062091

LOCATION: 1401 W CALDWELL AVE

ITEM NO: 5 Added to Agenda

SITE PLAN NO: SPR23022

PROJECT TITLE: 1744 S. Mooney Blvd

DESCRIPTION: Install Gate at Front of Parking Lot to be Closed After Business Hours. Relocate Trash Enclosure from

Rear of Building, (C-MU)

APPLICANT: Jim Robinson OWNER: COREVAL LLC

AFTER REVIEW OF REGULAR AGENDA ITEMS, THE COMMITTEE WILL BE AVAILABLE TO REVIEW OFF-AGENDA ITEMS FOR INFORMAL REVIEW. THE COMMITTEE WILL BE AVAILABLE TO ANSWER QUESTIONS AT THAT TIME.

SITE PLAN REVIEW AGENDA

2/15/2023 - 9:00 A.M. (Via Microsoft Teams)

To review supporting documents, click on the "SITE PLAN NO" link, then click on "Record Info" / "Attachments"

APN: 096304016

LOCATION: 1744 S MOONEY BLVD

ITEM NO: 6 Added to Agenda

SITE PLAN NO: SPR23023

PROJECT TITLE: T-Mobile Wireless Communications Facility

DESCRIPTION: Proposed Installation of an Emergency Standby Generator at an Existing T-Mobile Wireless

Communications Facility (I)

APPLICANT: Jeff Lienert
OWNER: RACE LEASING

OLDFIELD CORWYN D & LOIS L(TRS)(O FAN

APN: 073160026 073160024

LOCATION: 10299 W GOSHEN AVE

ITEM NO: 7 Added to Agenda

SITE PLAN NO: SPR23024

PROJECT TITLE: Majestic Inn Renovation Project

DESCRIPTION: Renovation of the Existing Majestic Inn and Managers Residence/Office Buildings into Affordable Housin

Units with Managers Residence/Office (C-R)

APPLICANT: Wayne Rutledge OWNER: DAYA FALGUNI APN: 087330040

LOCATION: 4545 W NOBLE AVE UNIT C

ITEM NO: 8 Added to Agenda

SITE PLAN NO: SPR23025

PROJECT TITLE: A&L Muffler & Auto Shop
DESCRIPTION: Relocate Shop (C-MU)
APPLICANT: Servando Ledesma

OWNER: J & J EXETER REAL ESTATE LLC

APN: 094250028

LOCATION: 505 N BURKE ST

ITEM NO: 9 Added to Agenda

SITE PLAN NO: SPR23026

PROJECT TITLE: JC LZU Capital, LLC
DESCRIPTION: Medical Clinic (O-PA)
APPLICANT: Jonathan C. Liu
OWNER: JC LIU CAPITAL LLC

APN: 121100085

LOCATION: 2324 W SUNNYSIDE AVE

- Additional information and assistance in filling out this application can be found at the City of Visalia website (www.visalia.city) or by calling (559) 713-4440-



OPERATIONS & TRAFFIC INFORMATION

This application MUST be filled out in its entirety and submitted with an acceptable site plan (see site plan minimum requirements & submittal details on Page 2). Failure to provide all requested information may result in rejection of your application and exclusion from the Site Plan Review agenda.

- Site Plan Review meetings are held on Wednesdays at 9am at City Hall East - 315 E Acequia Ave - Applicant(s) or Representative(s) must be present -

- Application submittal deadline is 4pm on Thursdays to be scheduled for the next available meeting Project/Business Name: KINGS PETROLEUM LLC Date: 2/06/2023 EXISTING FUEL ISLAND CANOPY FACADE REPLACEMENT, REPLACE EXISTING Project Description: S PUMPS (NO NEW PUMPS), (2) NEW 12000 GAL DIESEL STORAGE TANKS. Site Plan Review Resubmittal: If Resubmittal, Previous Site Plan Review Number: 2022-172 Property Owner: AL HIRANI Applicant(s) Name: TOWNSEND ARCHITECTURAL GROUP FOR AL HIRANI Project Address/Location: 205 N. BEN MADDOX WAY Assessor Parcel Number: _1 9 0 _0 1 Parcel Size (Acreage or Square Feet): Building or Suite Square Footage: Existing 3725 S.F. 4.272 Are There Any Proposed Building Modifications: Yes () No --- THIS AREA FOR CITY STAFF USE ONLY ---Estimated Cost of Modifications to Building: \$ N/A Date Received: Describe All Proposed Building Modifications: SPR Agenda: _____ Item No. N/A Zone: _____ SPR No. 22-172 Historic District: Yes () No () AE () X/AE () Flood Zone: - - A SEPARATE, DETAILED OPERATIONAL STATEMENT IS HIGHLY RECOMMENDED FOR ALL SUBMITTALS --Existing/Prior Building Use: FUEL SALES & RETAIL COUNTER FUEL SALES & RETAIL COUNTER, REPLACE FUEL PUMPS Proposed Building Use: 7AM-5PM Proposed Hours of Operation: (Su)(M)(T)(W)(Th)(F)(Sa)Days of Week In Operation (Circle): Number of Employees Per Day: Existing Proposed 50 - 7550 - 75Number of Customers Per Day (Estimated): Existing Proposed 1:00pm T0 2:00pm Predicted Peak Operating Hour: AS NEEDED BETWEEN THE HOURS OF OPERATION Describe Any Truck Delivery Schedule & Operations: Please Identify Any Unique or Specific Traffic Patterns That Will Require Accommodations For Operations, Customers, or Employees NO UNIQUE ACCOMODATIONS NEEDED AT THIS TIME (Provide Separate Attachment if Necessary): NONE Describe Any Special Events Planned for the Facility: Page 1 of 2 - Application continues on back of this page

			350300000000000000000000000000000000000			
SITE PLAN MINIMUM REQUIREMENTS						
	Submit a digital copy of the site plan(s) and completed application of	on a flash drive or equivalent (PDF f	format preferred, hard paper copies			
NTS	not accepted). Digital copies must be clear, legible, and on a layout sized appropriately to convey all necessary project information. Site plan shall provide for and indicate all of the following: North arrow Existing & proposed structures All existing & proposed site features Adjacent street names Site dimensions, including building Refuse enclosures & containers - Accessible path of travel from ADA stall					
REME						
<u>:</u> 0	⇒ Site plan shall provide for and indicate all of the following:					
N RF	- North arrow - Existing & pro	oposed structures - Load	ding/unloading areas			
PLA	- All existing & proposed site features - Adjacent street	et names - Acce	essible path of travel from right of way			
黑	- Site dimensions, including building - Refuse enclos	sures & containers - Acce	essible path of travel from ADA stall			
Ĭ	- Existing and proposed rending at site - Valley oak tre		ation and width of drive approaches to site			
		· · · ·	tative maps shall adhere to requirements isalia Municipal Code Section 16			
	Applicant Information (Final comments will be mailed to the name and a					
JRE		re of Owner or Authorized Agent*				
톍	Address: 484 W. PROSPECT SUITE B					
SG	City, State, Zip PORTERVILE CA 93257 Owner	_ /	Date			
RED	Phone: 559-202-6254	me Call	2-06-2023			
REQUIRED SIGNATURE	- P 71	zed Agent*	Date			
٦						
	* If signed by an authorized agent , the "Agency Authorization" information belo	ow must be completed for this applica	ation to be considered acceptable.			
	AGENCY A	UTHORIZATION				
1	OWNER:					
	ЛТ ЦТРЛИТ					
	, deciare as folio	ows; I am the owner of certain real p	property bearing assessor's			
1	parcel number (APN):					
1	094-190-017					
	AGENT:					
1	LOGAN COUCH					
2	r designate, to act	t as my duly authorized agent for all DE/PUMPS REPLACEME	l purposes necessary to file NT 도 NEW STODACE			
	relative to the property mentioned herein. TANKS & SIGN	V	MI & MEM DIOUWOR			
5		•				
3	I declare under penalty of perjury the foregoing is true and correct.					
AGENCI AGI DONIZATION FOR	Executed this 6TH day of February	20 <u>23</u> .				
3						
2	OWNER Signat	ures	AGENT			
2	thanks thanks.	1 /	,			
		- fegor (all				
	Signature of Owner 205 N. BEN MADDOX WAY	Signature of Agent				
	Owner Mailing Address	484 W. PROSPECT Agent Mailing Address	SUITE B			
	P.O. BOX 508 VISALIA 93279	PORTERVILLE CA	93257			
	559-359-2041	559-202-6254				
	Owner Phone Number	Agent Phone Number				

PARCEL DESCRIPTION:

A.P.N.: 094-190-017 ACREAGE: 4.272 AC ± ADDRESS: 205 N. BEN MADDOX WAY, VISALIA, CA 93292 ZONE: C-S (SERVICE COMMERCIAL)

SCOPE OF WORK:

NEW FACADE FOR EXISTING FUEL CANOPY
REPLACE (5) EXISTING FUEL PUMPS
NEW (2) 12000 GAL. DIESEL STORAGE TANKS & CONTAINMENT PIT
NEW MONUMENT SIGN 8'-0" TALL
NEW POLE SIGNAGE 45'-0" TALL

APN MAP:


S1/2 OF NE1/4 OF SE1/4 SEC. 29, T.18S., R.25E., M.D.B.&M.

TOX Area Code 094—19
006-096

SCHOOL ST.


PDR. 2

P

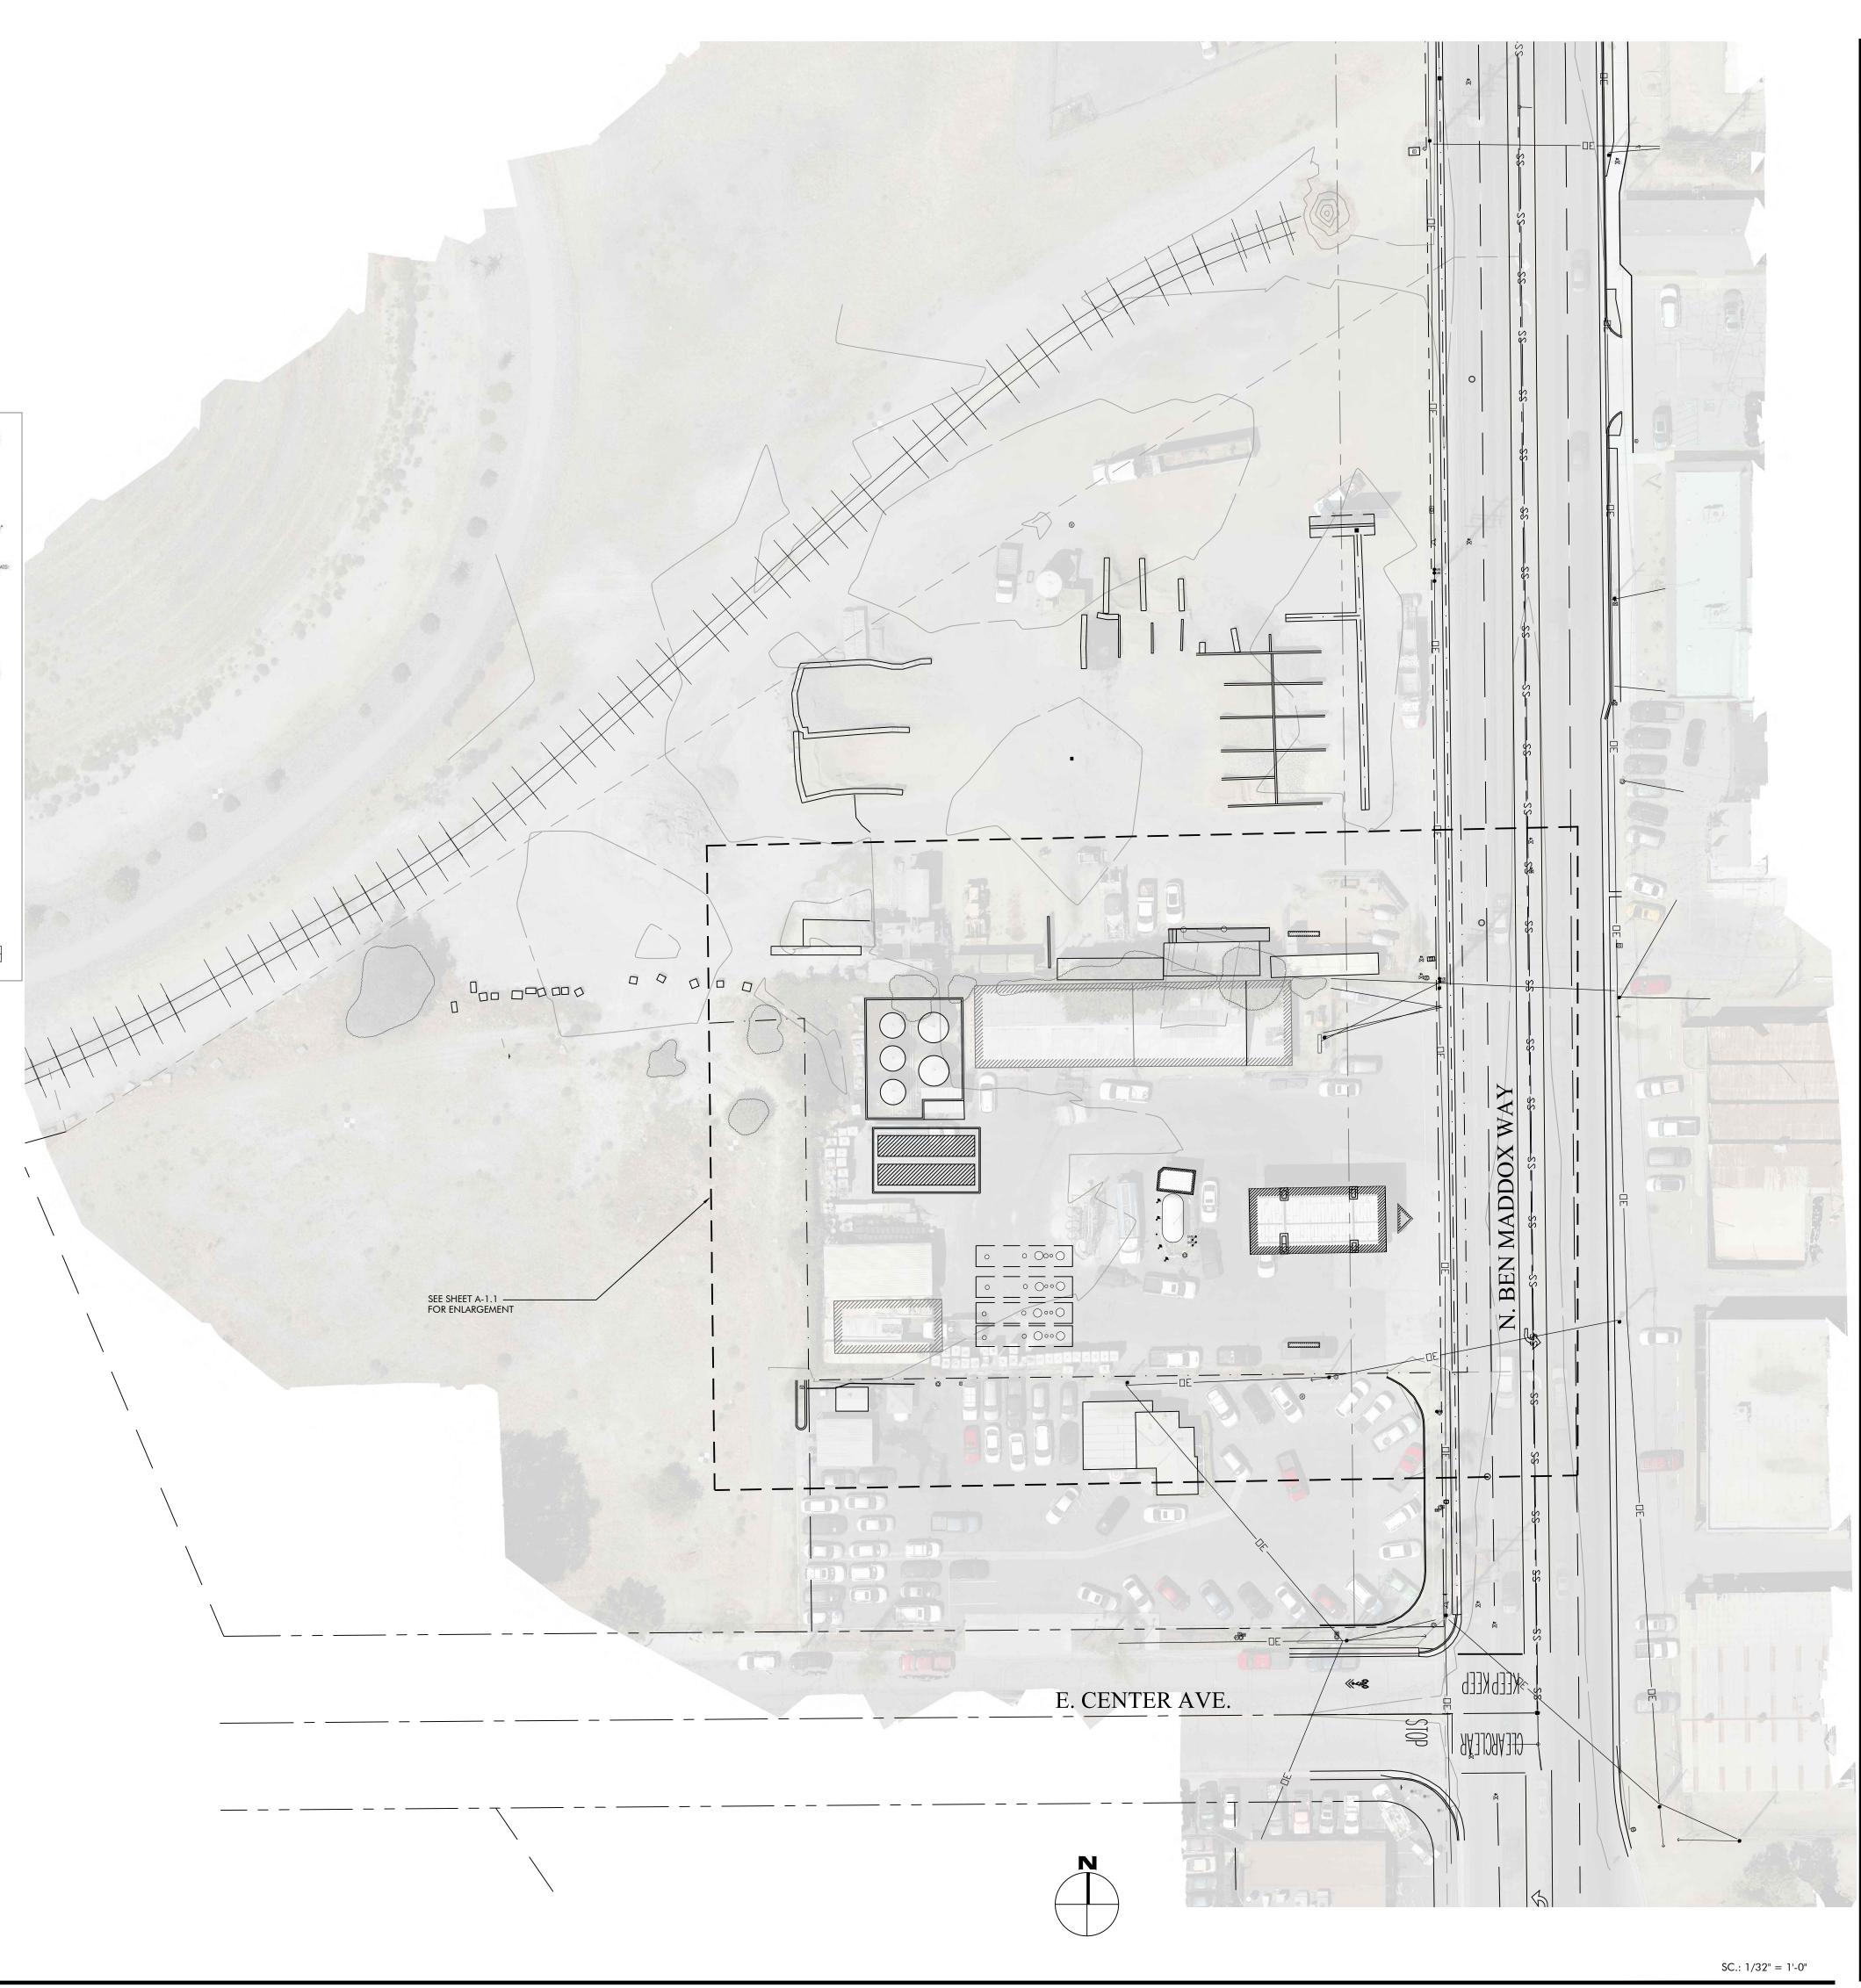



484 NORTH PROSPECT STREET, SUITE "B" PORTERVILLE, CA. 93257 (559) 789-9999 FAX (559) 781-3201

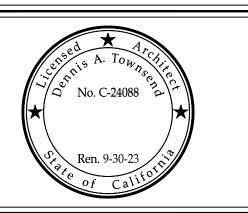

A NEW FUEL CANOPY FOR:

KINGS

PETROLEUM

205 N. BEN MADDOX WAY

VISALIA, CA

93292

DRAWN BY: U.Garcia
DES. BY: L. Couch
PLOT DATE: 02/01/2023
CHK'D BY: D. Townsend/L. Couch

REVISION

DESCRIPTION DATE

\$\Delta\$ SPR 2022-172 REVISIONS 2-6-23

TOWNSEND ARCHITECTURAL GROUP (T.A.G.)
EXPRESSLY RESERVES THE COMMON LAW
COPYRIGHT AND ALL OTHER APPLICABLE
RIGHTS IN THESE PLANS. THEY ARE NOT TO BE
COPIED, USED ON OTHER SITES THAN THAT
PECIFIED, REPRODUCED, OR CHANGED IN ANY
MANNER, NOR BE ASSIGNED TO A THIRD PARTY
WITHOUT OBTAINING PRIOR EXPRESS
WRITTEN CONSENT. THESE PLANS AND THE

IDEAS REPRESENTED HEREIN ARE, AND SHALL REMAIN, THE PROPERTY OF T.A.G.

OVERALL


SITE PLAN

PROJECT NUMBER:

22T69


SHEET

A-1

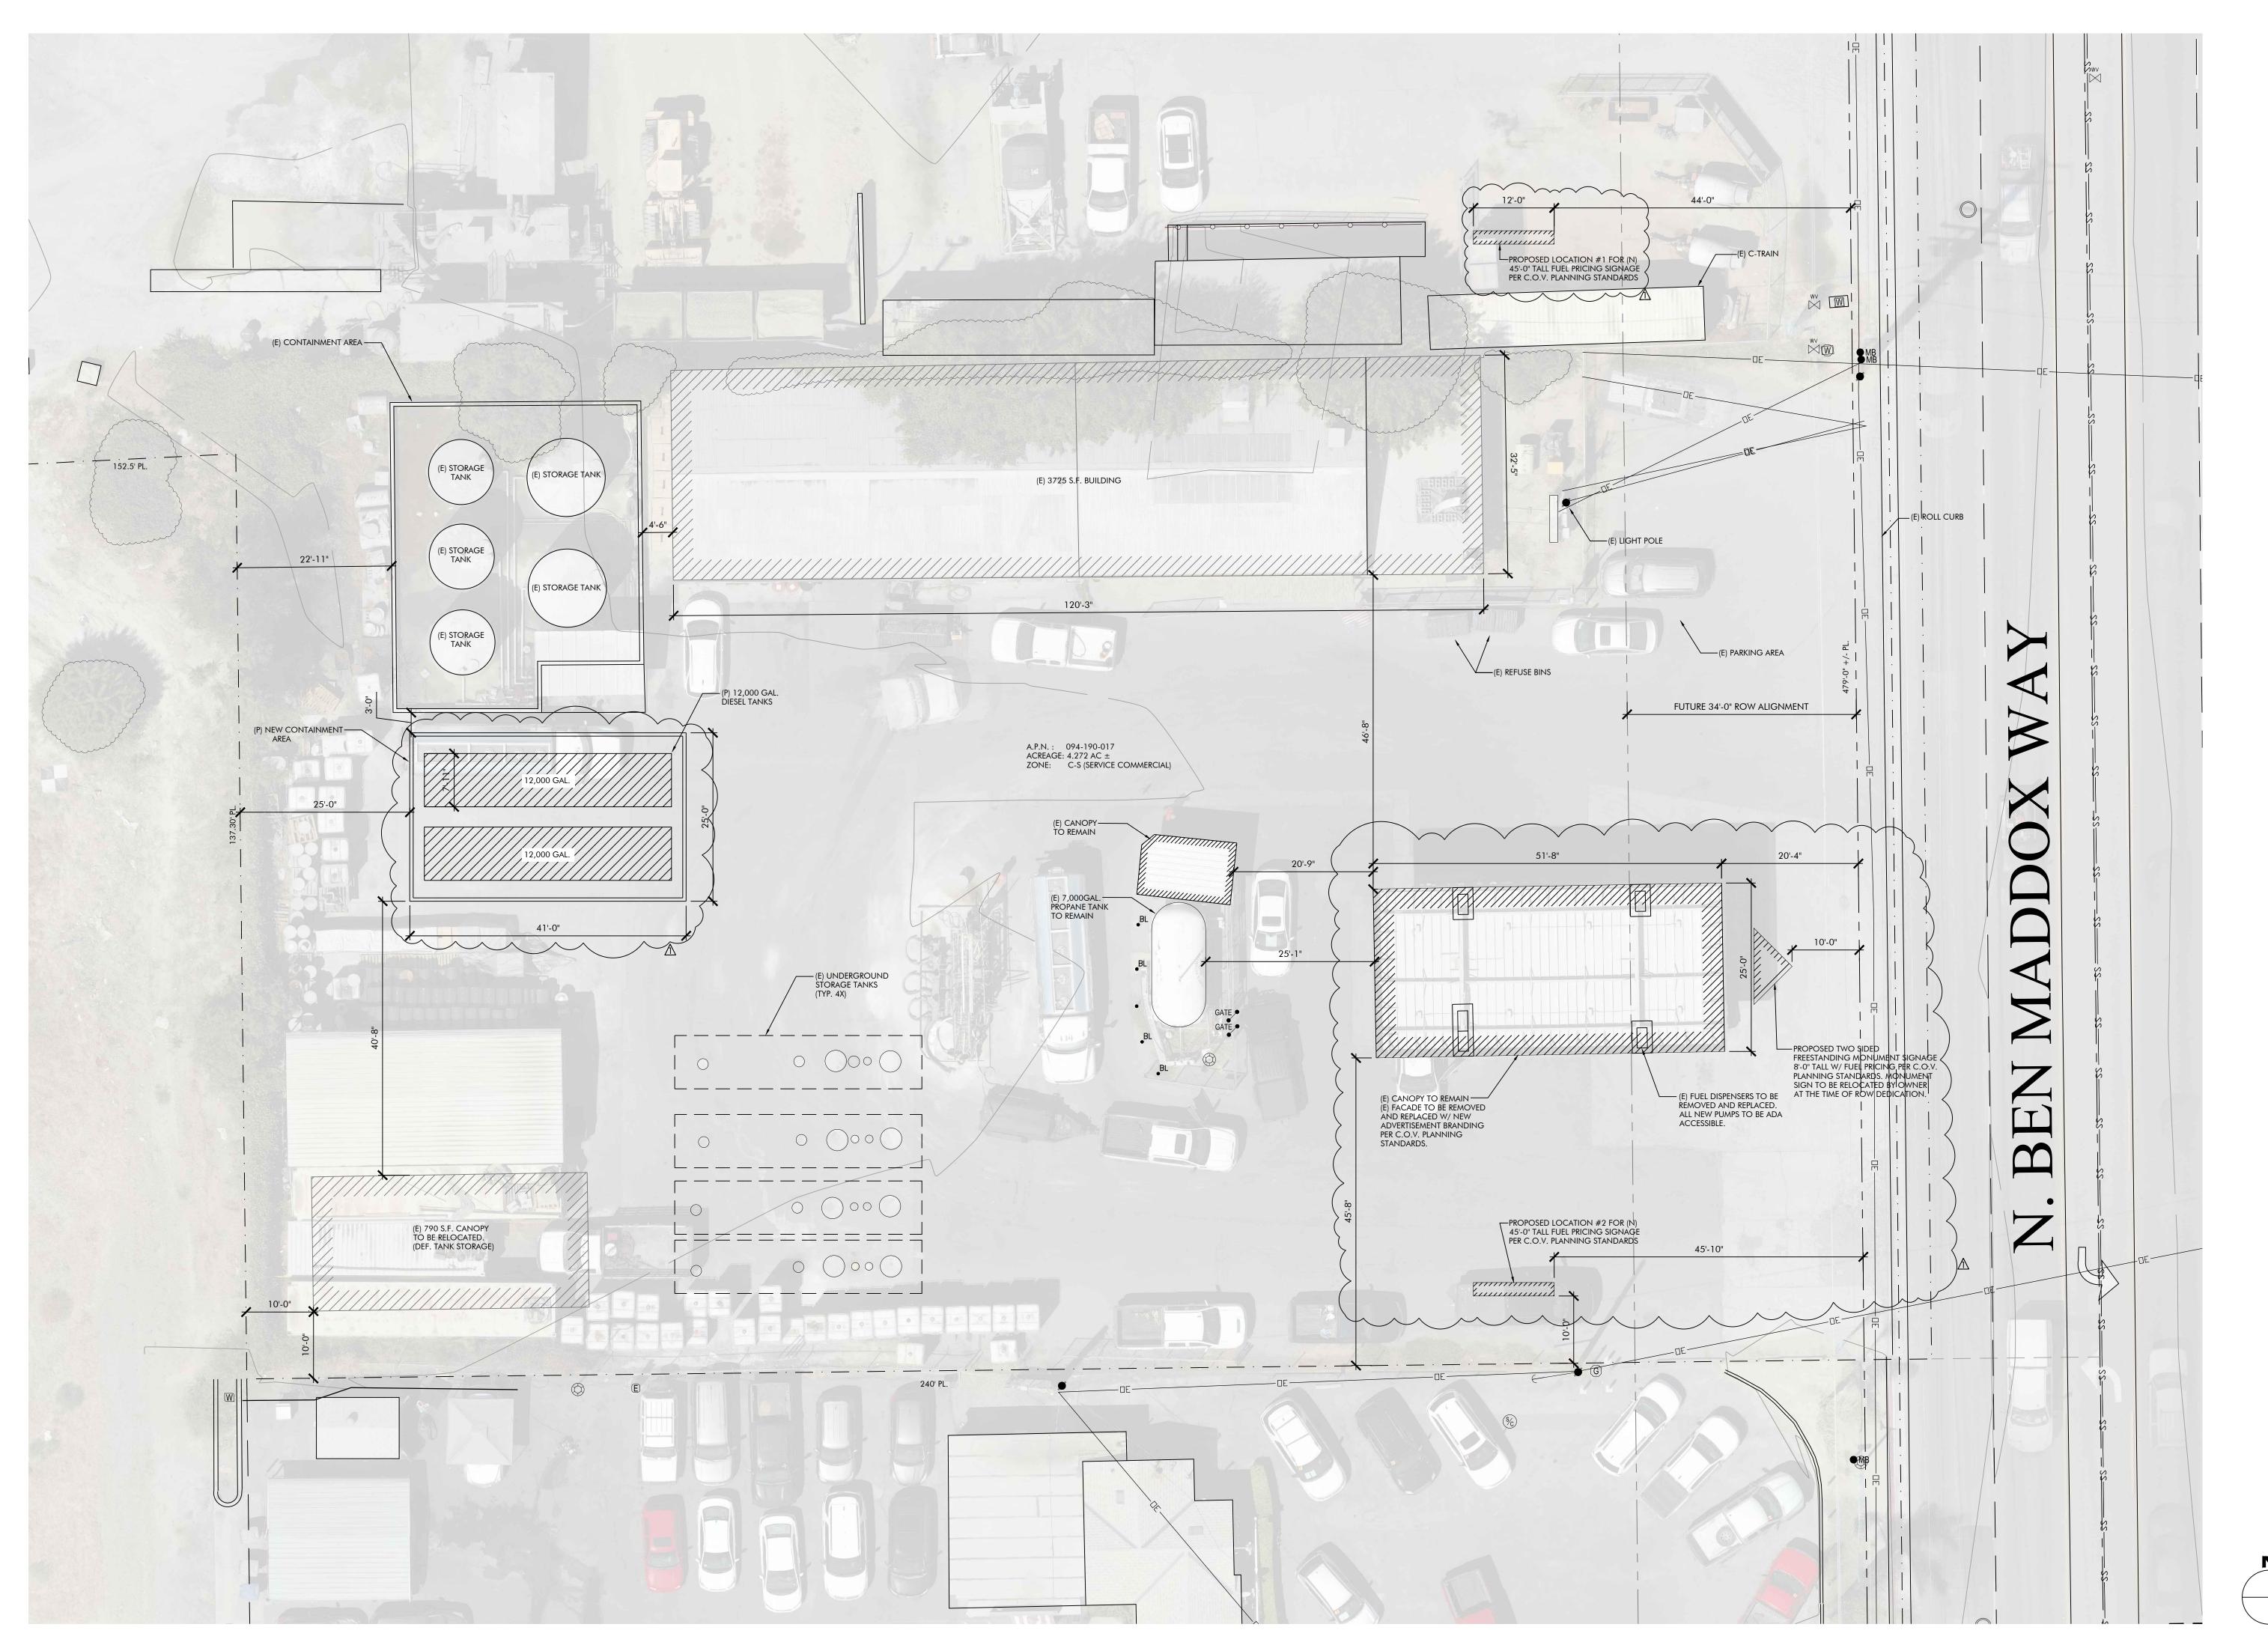



484 NORTH PROSPECT STREET, SUITE "B" PORTERVILLE, CA. 93257 (559) 789-9999 FAX (559) 781-3201

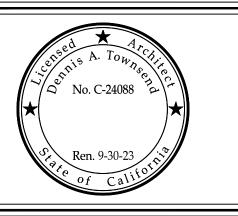

A NEW FUEL CANOPY FOR:

KINGS
PETROLEUM
205 N. BEN MADDOX WAY
VISALIA, CA

93292

DRAWN BY: U.Garcia
DES. BY: L. Couch
PLOT DATE: 02/01/2023
CHK'D BY: D. Townsend/L. Couch

REVISION

DESCRIPTION DATE

A SPR 2022-172 REVISIONS 2-6-23

TOWNSEND ARCHITECTURAL GROUP (T.A.G.)
EXPRESSLY RESERVES THE COMMON LAW
COPYRIGHT AND ALL OTHER APPLICABLE
RIGHTS IN THESE PLANS. THEY ARE NOT TO BE
COPIED, USED ON OTHER SITES THAN THAT
SPECIFIED, REPRODUCED, OR CHANGED IN ANY
MANNER, NOR BE ASSIGNED TO A THIRD PARTY
WITHOUT OBTAINING PRIOR EXPRESS
WRITTEN CONSENT. THESE PLANS AND THE
IDEAS REPRESENTED HEREIN ARE, AND SHALL

REMAIN, THE PROPERTY OF T.A.G.

ENLARGED

SITE PLAN

PROJECT NUMBER:

22T69

NUMBER

A-1.1

AGENCY AUTHORIZATION

OWNER: 1, <u>famela Bockert (Truke) Booker</u> , declare as follows; I am the owner of certain real property bearing assessor's parcel number (APN):	
098-050-023 098-050-035	
AGENT:	
I designate <u>GREG DOWDS</u> , to act as my duly authorized agent for all purposes necessary to file an application for, and obtain a permit to <u>COMVERT THE SITE</u> TO MILL STORAGE. relative to the property mentioned herein.	
I declare under penalty of perjury the foregoing is true and correct.	
Executed this3 day ofFEB	
OWNER Signatures AGENT	
Pameler Biokout (trostee)	
Signature of Owner Signature of Agent	
Bookent Family Trust (3500 S. TAMARACK ST.	-
Owner Mailing Address Agent Mailing Address Agent Mailing Address	
6805 Caraletto are, Bake Sielo, Con 93300 VISALIA, CA 93277	-
661-703-7785 559 805-0985	
Owner Phone Number Agent Phone Number	

Additional information and assistance in filling out this application can be found at the City of Visalia website (www.visalia.city) or by calling (559) 713-4440.




This application MUST be filled out in its entirety and submitted with an acceptable site plan (see site plan minimum requirements & submittal details on Page 2). Failure to provide all requested information may result in rejection of your application and exclusion from the Site Plan Review agenda.

Site Plan Review meetings are held on Wednesdays at 9:00 a.m. online utilizing Microsoft Teams. The applicant or representative must be present.

Application submittal deadline are Thursday at 4:00 p.m. to be scheduled for the next available meeting. Project/Business Name: DEATELS MINI STORAGE Project Description: PROJECT INFORMATION Site Plan Review Resubmittal: Yes () No (If Resubmittal, Previous Site Plan Review Number: Property Owner: Applicant(s) Name: DOWDS PLAUWHG SERVKES Project Address/Location: F GOSHEN AVE Assessor Parcel Number: Parcel Size (Acreage or Square Feet): Building or Suite Square Footage: Are There Any Proposed Building Modifications: Yes No No -- THIS AREA FOR CITY STAFF USE ONLY -Estimated Cost of Modifications to Building: Date Received: 02/07/2023 SPR Agenda: 02/15/2023 Item No. _____ Describe All Proposed Building Modifications: Zone: C-N SPR No. Yes No (X) Historic District: Flood Zone: $X \bigcirc$ AE (X) X/AE (- - A SEPARATE, DETAILED OPERATIONAL STATEMENT IS HIGHLY RECOMMENDED FOR ALL SUBMITTALS - -Existing/Prior Building Use: Proposed Building Use: Proposed Hours of Operation: Days of Week In Operation (Circle): Su M T W Th F Number of Employees Per Day: Existing Proposed Number of Customers Per Day (Estimated): Existing Proposed Predicted Peak Operating Hour: Describe Any Truck Delivery Schedule & Operations: MOUNE OPERATIONS & Please Identify Any Unique or Specific Traffic Patterns That Will Require Accommodations For Operations, Customers, or Employees (Provide Separate Attachment if Necessary): ON SAWITARY Describe Any Special Events Planned for the Facility: MONE

Page 1 of 2 - Application continues on back of this page

SITE PLAN MINIMUM REQUIREMENTS				
	Submit a digital copy of the site plan(s) and completed application on a flash drive or equivalent (PDF format preferred, hard paper copies			
NTS	not accepted).			
SITE PLAN REQUIREMENTS	Digital copies must be clear, legible, and on a layout sized appropriately to convey all necessary project information.			
EQU	⇒ Site plan shall provide for and indicate all of the following:			
NR	- North arrow - Existing & proposed structures - Loading/unloading areas			
PLA	- All existing & proposed site features - Adjacent street names - Accessible path of travel from right of way			
SITE	 Site dimensions, including building Refuse enclosures & containers Accessible path of travel from ADA stall Existing and proposed fencing at site Valley oak trees (show drip line) Location and width of drive approaches to site 			
	- Existing and proposed rending at site - valley oak trees (show drip line) - Location and width or drive approaches to site - Public improvements (curbs, sidewalks, - Existing & proposed landscaping - Tentative maps shall adhere to requirements			
	utility poles, hydrants, street lights, etc.) - Parking stalls (include ADA) of Visalia Municipal Code Section 16			
	Applicant Information (Final comments will be mailed to the name and address provided below)			
RE	Name: GREG DOLLOS Signature of Owner or Authorized Agent*			
REQUIRED SIGNATURE	BKEG VOUVS			
NDI:	Owner			
ED S				
UIR	Phone: 559 805 09 85 Address Agent Date			
REC	Email: glowles (Dad Coun)			
	* If signed by an authorized agent, the "Agency Authorization" information below must be completed for this application to be considered acceptable.			
	AGENCY AUTHORIZATION			
	OWNER:			
	I,, declare as follows; I am the owner of certain real property bearing assessor's			
parcel number (APN):				
	AGENT:			
I designate, to act as my duly authorized agent for all purposes necessary to file an application for, and obtain a permit to				
FOR	relative to the property mentioned herein.			
TION FORM	I declare under penalty of perjury the foregoing is true and correct.			
3IZA7	raceiare and expendity of perjury the foregoing is trac and correct.			
HOF	Executed this day of			
AUT				
AGENCY AUTHORIZA	OWNER Signatures AGENT			
AGE				
	Signature of Owner Signature of Agent			
	Owner Mailing Address Agent Mailing Address			
	Owner Phone Number Agent Phone Number			
	Page 2 of 2			

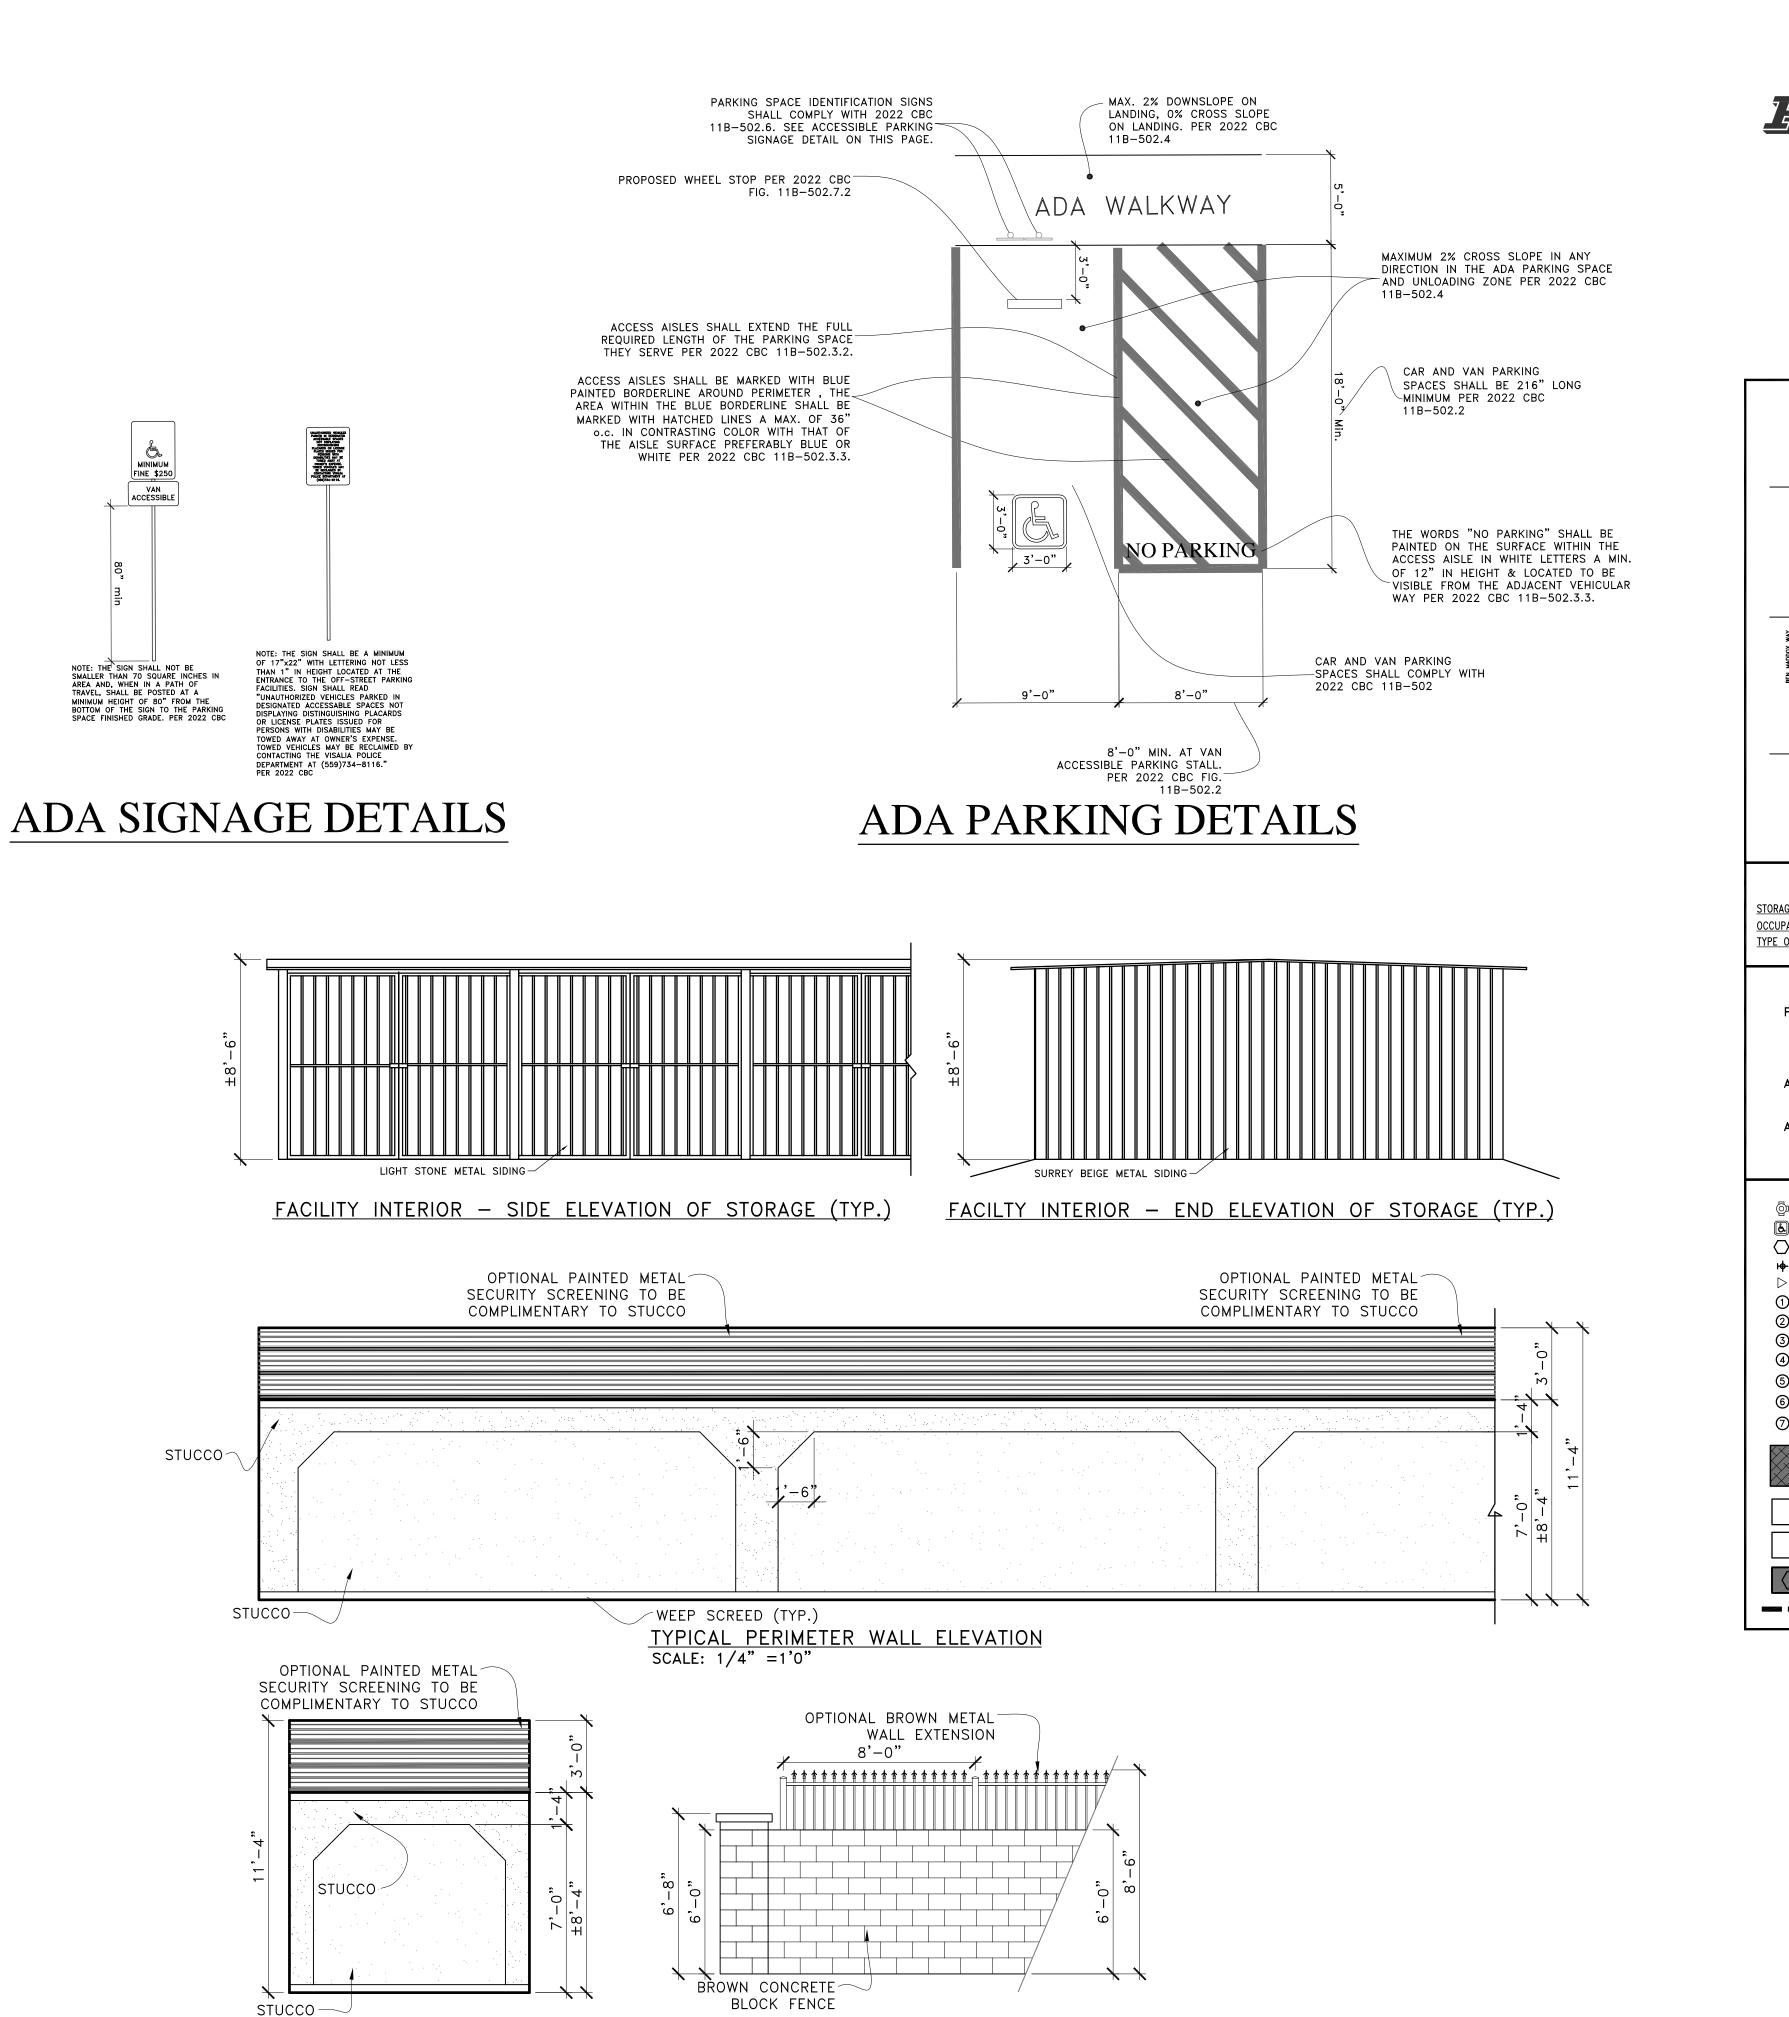



TYPICAL FENCE SECTION

SCALE: 1/4" =1'0"

TYPICAL END WALL ELEVATION

SCALE: 1/4" =1'0"

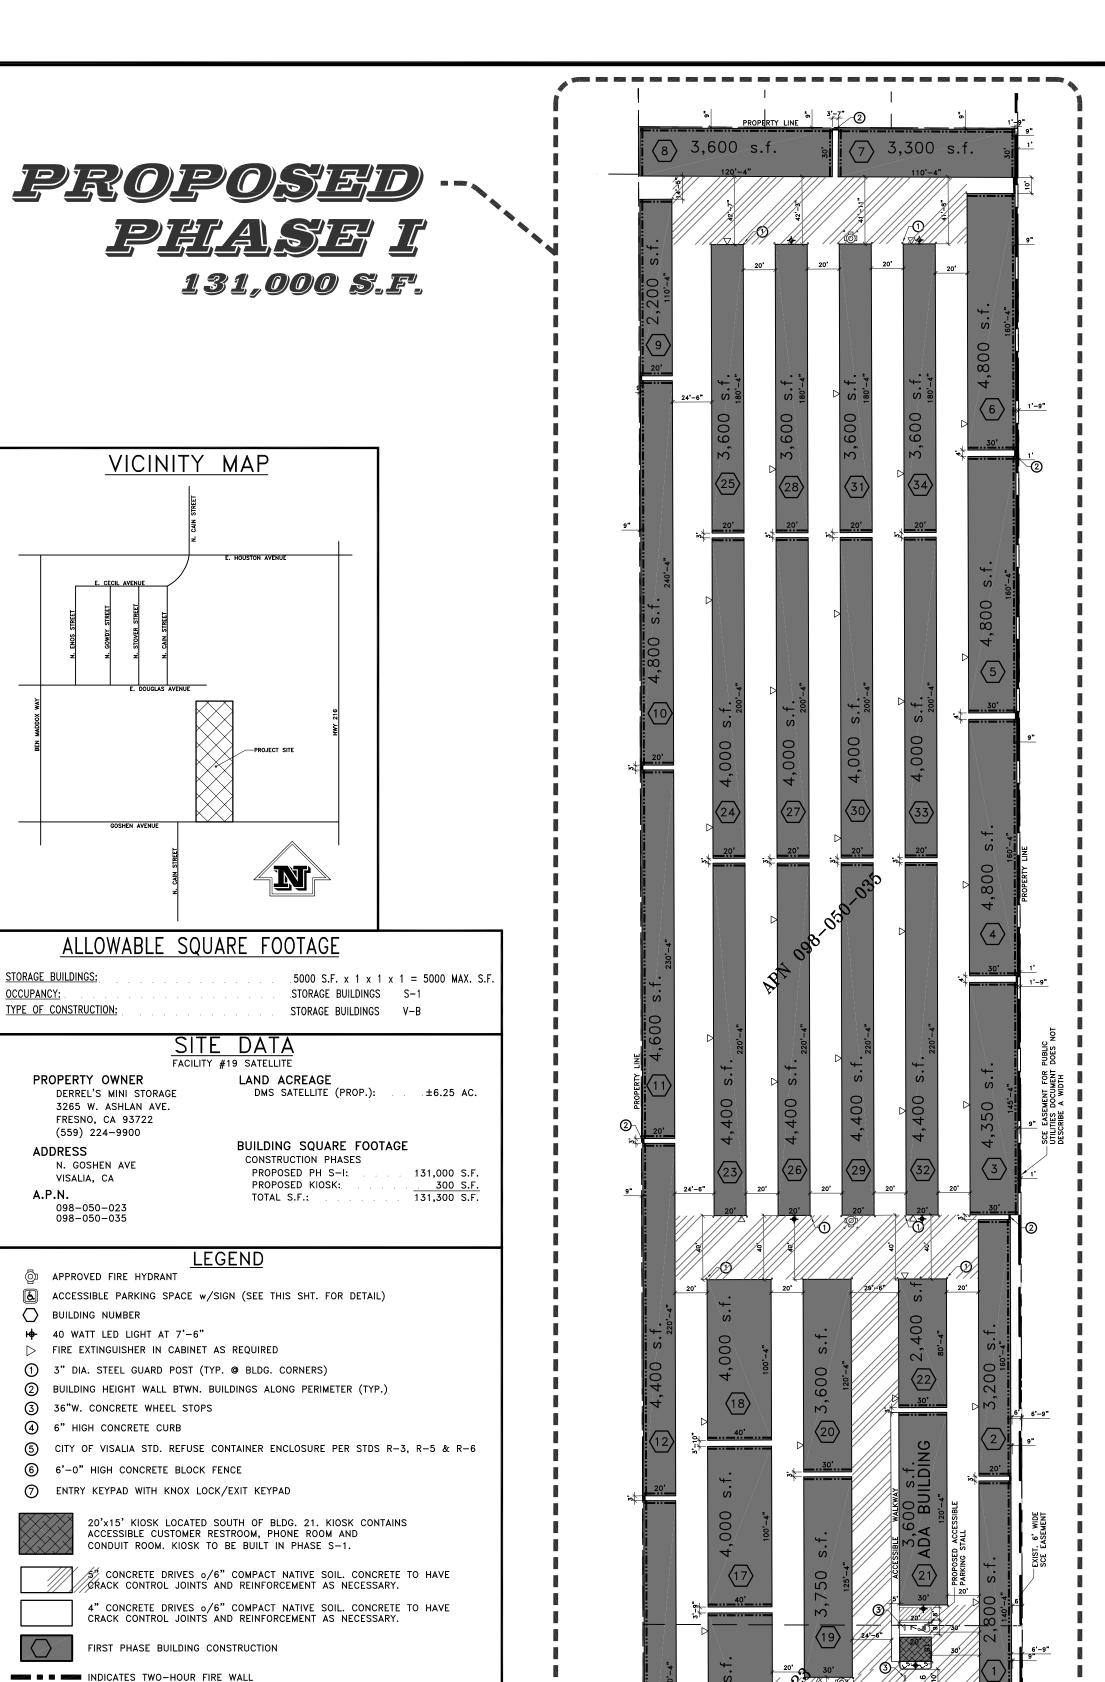

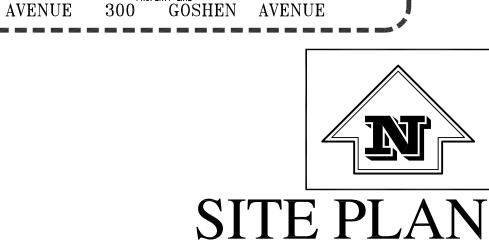

C:\My Documents\CADfiles\
Projects\19_BenMaddox\A1.dwg

Date:
 January 23, 2023

Scale:
 1" = 60'-0"

Drawn By:
 DB

Project:
 Site Plan
#19 Satellite

Visalia

Visalia
N. Goshen Ave

APPROVALS

ONS ONS

A-1

AGENCY AUTHORIZATION

OWNER: 1, <u>famela Bockert (Truke) Booker</u> , declare as follows; I am the owner of certain real property bearing assessor's parcel number (APN):	
098-050-023 098-050-035	
AGENT:	
I designate <u>GREG DOWDS</u> , to act as my duly authorized agent for all purposes necessary to file an application for, and obtain a permit to <u>COMVERT THE SITE</u> TO MILL STORAGE. relative to the property mentioned herein.	
I declare under penalty of perjury the foregoing is true and correct.	
Executed this3 day ofFEB	
OWNER Signatures AGENT	
Pameler Biokout (trostee)	
Signature of Owner Signature of Agent	
Bookent Family Trust (3500 S. TAMARACK ST.	-
Owner Mailing Address Agent Mailing Address Agent Mailing Address	
6805 Caraletto are, Bake Sielo, Con 93300 VISALIA, CA 93277	-
661-703-7785 559 805-0985	
Owner Phone Number Agent Phone Number	

Additional information and assistance in filling out this application can be found at the City of Visalia website (www.visalia.city) or by calling (559) 713-4440.


VISALIA Parket ISS

This application MUST be filled out in its entirety and submitted with an acceptable site plan (see site plan minimum requirements & submittal details on Page 2). Failure to provide all requested information may result in rejection of your application and exclusion from the Site Plan Review agenda.

Site Plan Review meetings are held on Wednesdays at 9:00 a.m. online utilizing Microsoft Teams. The applicant or representative must be present.

	Application submittal deadline are Thursday at 4:00 p.m. to be scheduled for the next available meeting.			
GENERAL PROJECT INFORMATION	Project/Business Name: DEVALE ON MINI STOP AGE	Date: 2/2/23		
	Project Description: EXSPANSION OF EXISTING FACIL	ity ON ED		
	SHOPPING BUSTING FACILITY TO	HEW SECTION		
NFOR	Property Owner:	lan Review Number:		
ECT I	GOOKOUT FAMILY TROST			
AL PRO.	Applicant(s) Name: CREC DOWDS DOWD Project Address/Location:	DS PLAUWING SERVICES		
ENER/	Assessor Parcel Number: 698-050-033 096-05	2-035 + 066 - 050 - 039		
9	Parcel Size (Acreage or Square Feet): 69 + 26 Building or Suite Sc	quare Footage: 277,530		
-	Are There Any Proposed Building Modifications: Yes No No	THIS AREA FOR CITY STAFF USE ONLY		
	Estimated Cost of Modifications to Building:	Date Received; 02/07/2023		
	Describe All Proposed Building Modifications:	SPR Agenda: 02/15/2023 Item No		
		z _{on} <u>C-N R-M-</u> 3 _{SPR No.} 23-020		
-		Historic District: Yes No		
+	A SEDADATE DETAILED OPERATIONAL	Flood Zone: X AE X/AE		
	A SEPARATE, DETAILED OPERATIONAL STATEMENT IS HIGHLY RECOMM			
	Existing/Prior Building Use: UFLD ING SHOP + DISABLE Proposed Building Use: VOILI			
	- THE TOTAL ST			
	Proposed Hours of Operation: ZAM - ZOM , Days of Week In Operation (Circle): Su M T W Th F Sa			
KIVIA	Number of Employees Per Day: Existing 3 Proposed	• 7		
2 2	Number of Customers Per Day (Estimated): Existing Proposed			
ALL L	Predicted Peak Operating Hour:			
N N	Describe Any Truck Delivery Schedule & Operations:			
L 1	Please Identify Any Unique or Specific Traffic Patterns That Will Require Accommodations For O	perations, Customers, or Employees		
	(Provide Separate Attachment if Necessary): <u> </u>	y stute system		
	Describe Any Special Events Planned for the Facility:			
-				
	Page 1 of 2 - Application continues on back of this	2 2022		

	SITE PLAN MINIMUM REQUIREMENTS Submit a digital copy of the site plan(c) and completed analysis if					
S	a digital copy of the site plants) and completed application on a flash drive or equivalent (PDF format preferred, hard paper copies					
ENT	not accepted).					
SITE PLAN REQUIREMENTS	Digital copies must be clear, legible, and on a layout sized appropriately to convey all necessary project information.					
EQU	⇒ Site plan shall provide for and indicate all of the following:					
AN	- North arrow - Existing & proposed structures - Loading/unloading gross					
E PL	- All existing & proposed site features - Adjacent street names - Accessible path of travel from right of way					
SIT	- Existing and proposed fension at all					
	- Public improvements (curbs, sidewalks, - Existing & proposed landscaping - Tentative mans chall adhere to service approaches to site					
	utility poles, hydrants, street lights, etc.) - Parking stalls (include ADA) of Visalia Municipal Code Section 16					
	Applicant Information (Final comments will be mailed to the name and address provided below)					
REQUIRED SIGNATURE	Name: GREG DOWPS Signature of Owner or Authorized Agent*					
SNAT	Address: 3500 S. TAMARACK ST					
D SIC	City, State, Zip VISALIA CA 93277 Owner Date					
JIRE	Phone: 559 805 0985 (MM) 41/17					
REQU	Email: glowl 5 G as com Authorized Agent* Date					
	* If signed by an authorized agent , the "Agency Authorization" information below must be completed for this application to be considered acceptable.					
1	AGENCY AUTHORIZATION					
	OWNER:					
I,, declare as follows; I am the owner of certain real property bearing assessor's						
	parcel number (APN):					
	AGENT:					
Σ	I designate, to act as my duly authorized agent for all purposes necessary to file an application for, and obtain a permit to					
TION FORM	relative to the property mentioned herein.					
	I declare under penalty of perjury the foregoing is true and correct.					
RIZA						
AGENCY AUTHORIZA	Executed this day of, 20					
Y AL						
ENC	OWNER Signatures AGENT					
¥						
	Signature of Owner Signature of Agent					
	Owner Mailing Address Agent Mailing Address					
	Owner Phone Number					
	Agent Phone Number					
	Page 2 of 2					

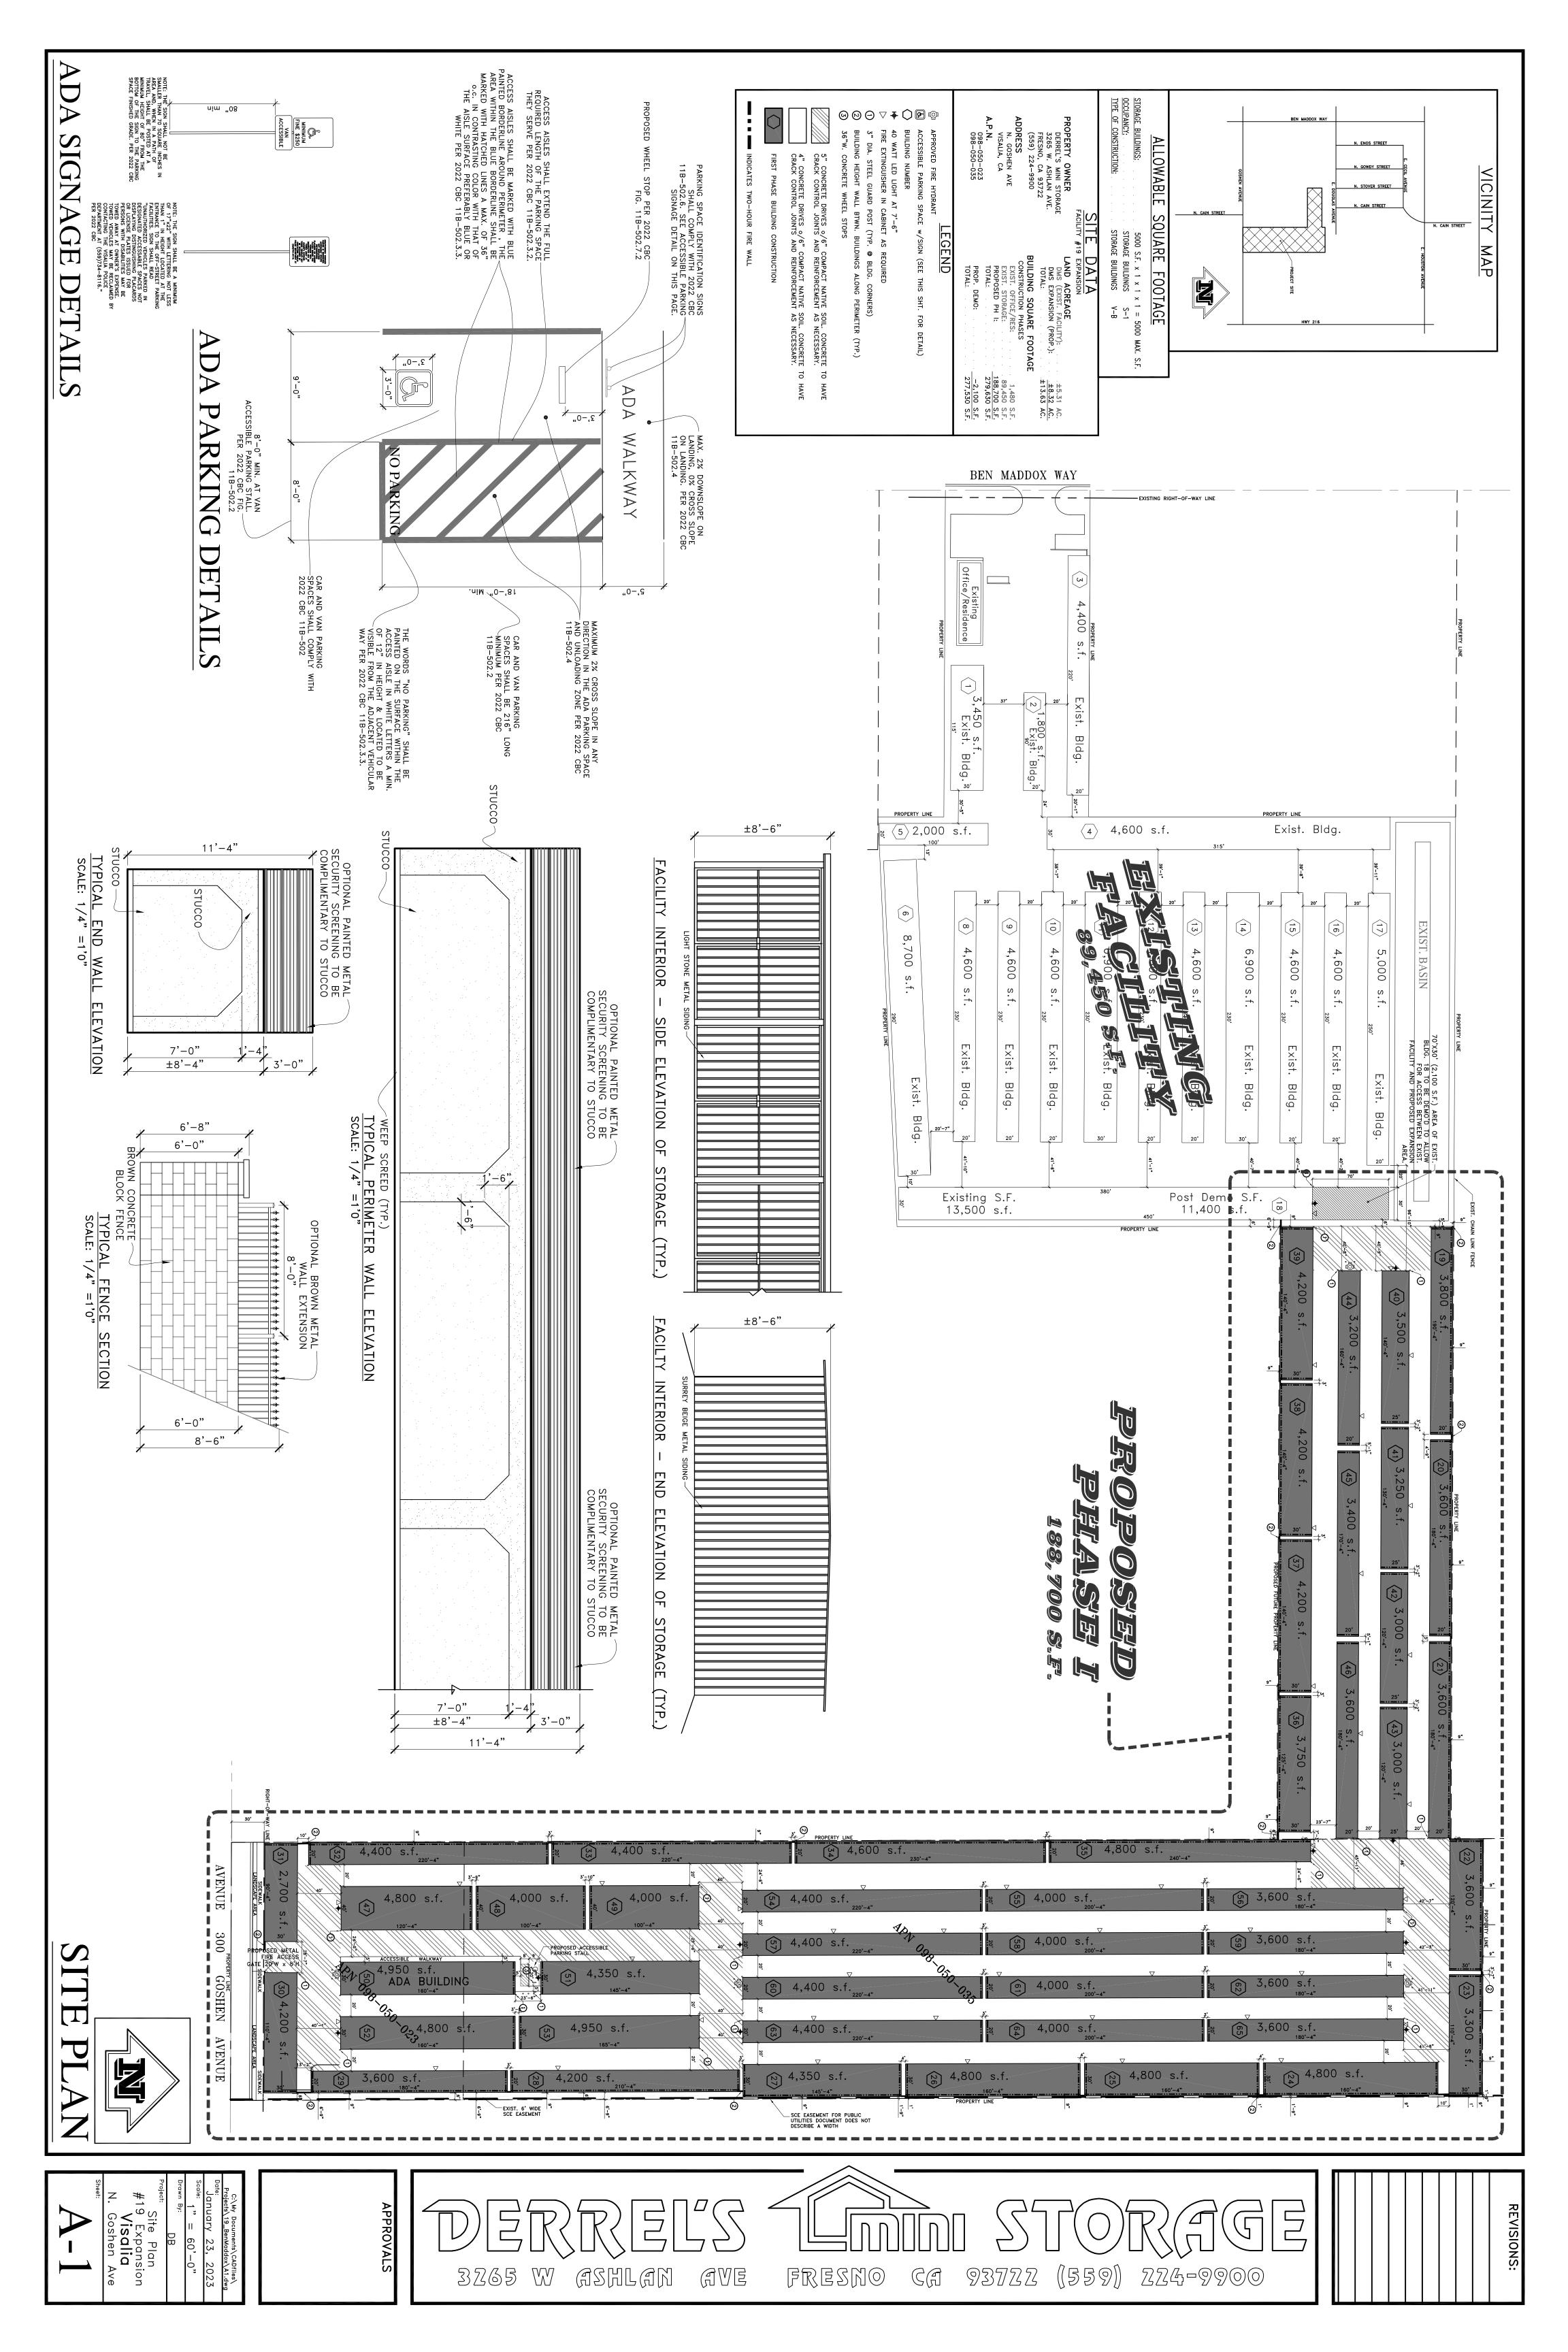

Additional information and assistance in filling out this application can be found at the City of Visalia website (www.visalia.city) or by calling (559) 713-4440.



This application MUST be filled out in its entirety and submitted with an acceptable site plan (see site plan minimum requirements & submittal details on Page 2). Failure to provide all requested information may result in rejection of your application and exclusion from the Site Plan Review agenda.

Site Plan Review meetings are held on Wednesdays at 9:00 a.m. online utilizing Microsoft Teams. The applicant or representative must be present.

Application submittal deadline are Thursday at 4:00 p.m. to be scheduled for the next available meeting

ļ	Application submittal deadline are mursually at 4.00 p.m. to be scrieduled for				
	Project/Business Name: T-Mobile Wireless Communications Facility	/ Date: <u>2/7/2023</u>			
-	Project Description: Proposed installation of an emergency standby (back-up) generator at an existing				
0	T-Mobile wireless communications facility.				
N N	Site Plan Review Resubmittal: Yes No If Resubmittal, Previous Site Plan	an Review Number:			
GENERAL PROJECT INFORMATION	Property Owner: T-Mobile				
OJEC	Applicant(s) Name: T-Mobile West LLC (Agent: Jeff Lienert)				
AL PR	Project Address/Location: 1401 W. Caldwell, Visalia, CA				
NER/	Assessor Parcel Number: <u>1 2 6 - 0 6 2 - 0 9 1</u>				
GE	Parcel Size (Acreage or Square Feet): T-Mobile Building or Suite Sq	quare Footage: N/A			
	Are There Any Proposed Building Modifications: Yes No	THIS AREA FOR CITY STAFF USE ONLY			
	Estimated Cost of Modifications to Building: \$30,000 (cost of generator installation)	Date Received:02/07/2023			
	Describe All Proposed Building Modifications: No building modifications are proposed	SPR Agenda: 02/15/2023 Item No			
	with this application. The applicant is seeking approval of an emergency standby	Zone: C-MU SPR No. 23-021			
	generator installation at its existing wireless communications facility, within the	Historic District: Yes No			
	existing fenced communication site compound.	Flood Zone: X X AE X/AE			
	A SEPARATE, DETAILED OPERATIONAL STATEMENT IS HIGHLY RECOMM	MENDED FOR ALL SUBMITTALS			
	Existing/Prior Building Use: Existing T-Mobile wireless communications facility.	MENDED FOR ALL SUBMITTALS			
	Existing/Prior Building Use: Existing T-Mobile wireless communications facility. Proposed Building Use: No changes other than adding an emergency backup generate	tor to the existing T-Mobile wireless facility.			
	Existing/Prior Building Use: Proposed Building Use: No changes other than adding an emergency backup generat The wireless facility operates 24/7/365. Aside from routine mainte Proposed Hours of Operation: For maintenance the generator is exercised once per week for ap	tor to the existing T-Mobile wireless facility.			
NOIL	Existing/Prior Building Use: Existing T-Mobile wireless communications facility. Proposed Building Use: No changes other than adding an emergency backup general The wireless facility operates 24/7/365. Aside from routine mainte	tor to the existing T-Mobile wireless facility.			
RMATION	Existing/Prior Building Use: Proposed Building Use: No changes other than adding an emergency backup generat The wireless facility operates 24/7/365. Aside from routine mainte For maintenance the generator is exercised once per week for ap on a non-holiday weekday.	tor to the existing T-Mobile wireless facility. enance the generator will operate during a power outage pproximately 15-minutes during normal business hours			
INFORMATION	Existing/Prior Building Use: Proposed Building Use: No changes other than adding an emergency backup generat The wireless facility operates 24/7/365. Aside from routine mainte For maintenance the generator is exercised once per week for ap on a non-holiday weekday. Days of Week In Operation (Circle): Su M T W Th F Sa	tor to the existing T-Mobile wireless facility. enance the generator will operate during a power outage operoximately 15-minutes during normal business hours d 0 (unmanned)			
AFFIC INFORMATION	Existing/Prior Building Use: Proposed Building Use: No changes other than adding an emergency backup general The wireless facility operates 24/7/365. Aside from routine mainter For maintenance the generator is exercised once per week for apon a non-holiday weekday. Days of Week In Operation (Circle): Su M T W Th F Sa Number of Employees Per Day: Existing 0 (unmanned) Proposed Number of Customers Per Day (Estimated): Existing 0 (unmanned) Proposed	tor to the existing T-Mobile wireless facility. enance the generator will operate during a power outage operoximately 15-minutes during normal business hours d 0 (unmanned)			
& TRA	Existing/Prior Building Use: Proposed Building Use: No changes other than adding an emergency backup generated an emergency backup generated and the proposed Hours of Operation: Proposed Hours of Operation: Proposed Hours of Operation: Days of Week In Operation (Circle): Number of Employees Per Day: Existing O (unmanned) Proposed Predicted Peak Operating Hour: Unknown/TBD. The generator will operation in a non-tholograph of the proposed of the prop	tor to the existing T-Mobile wireless facility. enance the generator will operate during a power outage oproximately 15-minutes during normal business hours d			
& TRA	Existing/Prior Building Use: Proposed Building Use: No changes other than adding an emergency backup generated an emergency backup generated and the proposed Hours of Operation: Proposed Hours of Operation: Proposed Hours of Operation: Days of Week In Operation (Circle): Number of Employees Per Day: Existing O (unmanned) Proposed Predicted Peak Operating Hour: Unknown/TBD. The generator will operation in a non-tholograph of the proposed of the prop	tor to the existing T-Mobile wireless facility. enance the generator will operate during a power outage oproximately 15-minutes during normal business hours d			
& TRA	Existing / Prior Building Use: Proposed Building Use: No changes other than adding an emergency backup generated and proposed flower for maintenance the generator is exercised once per week for appoint a non-holiday weekday. Days of Week In Operation (Circle): Su M T W Th F Sa Number of Employees Per Day: Existing 0 (unmanned) Proposed for the proposed flower flowe	tor to the existing T-Mobile wireless facility. enance the generator will operate during a power outage oproximately 15-minutes during normal business hours d			
OPERATIONS & TRAFFIC INFORMATION	Existing / Prior Building Use: Proposed Building Use: No changes other than adding an emergency backup generated and emergency backup generated an emergency backup generated an emergency backup generated an emergency backup generated an emergency backup generated and emergency backup generated and emergency backup generated an emergency backup generated and emergency backup gen	tor to the existing T-Mobile wireless facility. enance the generator will operate during a power outage oproximately 15-minutes during normal business hours d			
& TRA	Existing/Prior Building Use: Proposed Building Use: No changes other than adding an emergency backup generated The wireless facility operates 24/7/365. Aside from routine mainter For maintenance the generator is exercised once per week for apponent an anon-holiday weekday. Days of Week In Operation (Circle): Su M T W Th F Sa Number of Employees Per Day: Existing 0 (unmanned) Proposed Operation Predicted Peak Operating Hour: Unknown/TBD. The generator will operated as necessary. An automatic transfer switch will be installed to power the generator Specific Traffic Patterns That Will Require Accommodations For Commodations	tor to the existing T-Mobile wireless facility. enance the generator will operate during a power outage oproximately 15-minutes during normal business hours d			
& TRA	Existing/Prior Building Use: Proposed Building Use: No changes other than adding an emergency backup generate The wireless facility operates 24/7/365. Aside from routine mainter For maintenance the generator is exercised once per week for appoint a non-holiday weekday. Days of Week In Operation (Circle): Number of Employees Per Day: Existing 0 (unmanned) Proposed (unmanned) Prop	tor to the existing T-Mobile wireless facility. enance the generator will operate during a power outage oproximately 15-minutes during normal business hours d			
& TRA	Existing/Prior Building Use: Proposed Building Use: No changes other than adding an emergency backup generated and the wireless facility operates 24/7/365. Aside from routine mainter and an emergency backup generated and the wireless facility operates 24/7/365. Aside from routine mainter and an anon-holiday weekday. Days of Week In Operation (Circle): Su M T W Th F Sa Number of Employees Per Day: Existing 0 (unmanned) Proposed Operation (Unknown/TBD). The generator will operated Describe Any Truck Delivery Schedule & Operations: No regular truck delivery required as necessary. An automatic transfer switch will be installed to power the generator will operated Describe Separate Attachment if Necessary): This is an unmanned facility and the installedy generator will not impact traffic patterns.	tor to the existing T-Mobile wireless facility. enance the generator will operate during a power outage oproximately 15-minutes during normal business hours d			

SITE PLAN MINIMUM REQUIREMENTS				
	Submit a digital copy of the site plan(s) and completed application on a flash drive or equivalent (PDF format preferred, hard paper copies			
VTS	not accepted).			
SITE PLAN REQUIREMENTS	Digital copies must be clear, legible, and on a layout sized appropriately to convey all necessary project information.			
auı	⇒ Site plan shall provide for and indicate all of the following:			
N RE	- North arrow - Existing & proposed structures - Loading/unloading areas			
PLA	- All existing & proposed site features - Adjacent street names - Accessible path of travel from right of way			
ITE	- Site dimensions, including building - Refuse enclosures & containers - Accessible path of travel from ADA stall			
S	- Existing and proposed fencing at site - Valley oak trees (show drip line) - Location and width of drive approaches to site			
	 Public improvements (curbs, sidewalks, - Existing & proposed landscaping - Tentative maps shall adhere to requirements utility poles, hydrants, street lights, etc.) - Parking stalls (include ADA) of Visalia Municipal Code Section 16 			
	Applicant Information (Final comments will be mailed to the name and address provided below)			
E				
TUR	Name: Jeff Lienert for T-Mobile Signature of Owner or Authorized Agent* Owner signature is not required per Assembly Bill 2421			
SNA	Address: 2154 Medici Way Section 65850.75 of the Government Code			
) SIG	City, State, Zip El Dorado Hills, CA 95762 Owner Gentleman Date			
IRE	Phone: (916) 505-3683			
REQUIRED SIGNATURE	Email: Jeff.Lienert@gmail.com Authorized Agent* Date			
4	* If signed by an authorized agent, the "Agency Authorization" information below must be completed for this application to be considered acceptable.			
	AGENCY AUTHORIZATION			
	AGENCT AUTHORIZATION			
	OWNER:			
	I,, declare as follows; I am the owner of certain real property bearing assessor's			
	parcel number (APN):			
	126-062-091			
	AGENT:			
	I designate _ Jeff Lienert for T-Mobile, to act as my duly authorized agent for all purposes necessary to file			
RM	an application for, and obtain a permit to <u>install an emergency power generator</u>			
N FO	relative to the property mentioned herein.			
AGENCY AUTHORIZATION FORM	I declare under penalty of perjury the foregoing is true and correct.			
IORIZ	Executed this 7th day of February , 20 <u>23</u> .			
AUT				
NCY.	OWNER Signatures AGENT			
AGE	Owner signature is not required per Assembly Bill 2421			
	Section 65850.75 of the Government Code Signature of Owner Signature of Agent			
	2154 Medici Way			
	Owner Mailing Address Agent Mailing Address			
	El Dorado Hills, CA 95762			
	(916) 505-3683 / jeff.lienert@gmail.com			
	Owner Phone Number Agent Phone Number			
	Down Out O			

SINGLE SOURCE CONSULTING, INC.

Agent for T-Mobile: Single Source Consulting, Inc. Site Address: 1401 W. Caldwell, Visalia, CA 93277

February 7, 2023

City of Visalia Planning Division 315 E. Acequia Avenue Visalia, CA 93291

Re: Request to Install an Emergency Standby Generator to Serve a Macro Cell Tower Site located at 1401 W. Caldwell, Visalia, CA 93277 for existing T-Mobile Site # SC10106B

Dear Planning Division:

Attached is an application to install an Emergency Standby Generator to Serve a Macro Cell Tower. Effective January 1, 2021, <u>California General Assembly Bill 2421</u> allows wireless providers to prepare for future fire seasons and power outages by creating an administrative process to expedite the installation of standby generators.

The attached application qualifies for expedited administrative process under Section 65850.75(b) of the Government Code because it meets the following criteria (see the attached plans and application for details):

- (1) The emergency standby generator is rated below 50 horsepower, complies with applicable air quality regulations, has a double-walled storage tank that does not exceed 300 gallons, and is mounted on a concrete pad. (The proposed generator will reach up to 48.8 horsepower and will have a 240-gallon tank.)
- (2) The macro cell tower site at which the emergency standby generator is proposed to be installed is an existing site that was previously permitted by the applicable local agency.
- (3) The emergency standby generator complies with all applicable state and local laws and regulations, including building and fire safety codes.
- (4) The physical dimensions of the emergency standby generator and storage tank are cumulatively no more than 250 cubic feet in volume. (The volume for the proposed generator + tank = Volume = 192.05 cubic feet)
- (5) The emergency standby generator shall be located not more than 100 feet from the physical structure of the macro cell tower or base station.

Pursuant to Section 65850.75(c), applications may not require any new or different information than routine applications for other emergency generators. Notice of incomplete applications must be given within 10 days of submittal. The notice must indicate the manner in which the application can be made complete, including a list and thorough description of the specific information needed to complete the application. To further expedite the approval process, AB 2421 provides that proof of underlying property owner approval is not required as part of the initial application but may be required prior to installation.¹

_

¹ Cal. Gov't Code § 65850.75(f)

SINGLE SOURCE CONSULTING, INC.

A complete application must be approved within 60 days of receiving the application or it shall be deemed approved. ²

According to Section 65850.75(g) a cost-based fees may be imposed but the fee shall not exceed the reasonable costs of providing the service for which the fee is charged and shall not be levied for general revenue purposes.

Please contact me if you have any questions. I can be reached at (916) 505-3683 or at jeff.lienert@gmail.com.

Sincerely,

Jeff Lienert

Phone: (916) 505-3683 Email: jeff.lienert@gmail.com

Address: 2154 Medici Way, El Dorado Hills, CA 95762

² *Id.* § 65850.75(d)



OPERATIONAL STATEMENT

Proposed T-Mobile Emergency Standby Generator

T-Mobile Site # SC10106B

1401 W. Caldwell, Visalia, CA 93277

APN: 126-062-091

T-Mobile currently operates an existing wireless communications facility at 1401 W. Caldwell in Visalia, CA. T-Mobile's existing facility includes the collocation of panel antennas on an existing self-support tower together with ground equipment located on an existing concrete pad within the existing fenced communication site compound. T-Mobile needs to install a standby power generator for backup power. In order to meet California Public Utilities Commission requirements, which include a minimum of 72-hours backup power at cell site locations serving high-risk wildfire areas, T-Mobile is proposing to install a new Generac 25kW diesel generator on a new 4' x 9' concrete pad within the existing fenced communication site compound. Existing swing gates will allow access to the generator. T-Mobile will replace an existing 10' section of fence with new swing gates for continued access into the communication site compound.

The proposed Generac 25kW diesel generator measures 103.4" (L) x 35" (W) x 91.7" (H). A new power 1-1/2" conduit will connect to a new automatic transfer switch that will be mounted on a new H-Frame within T-Mobile's existing lease area. The automatic transfer switch measures 20" x 14.6" x 7" (H x W x D) and will allow for ease of operation and will help reduce switchover problems.

Additional details:

- Generac 25kW diesel generator specifications are incorporated into the plans.
- The generator will extend roughly 91.7" above grade.
- The fuel will be stored in a 240-gallon double-walled belly tank (the tank and the generator are comprised within the same unit, there is no separate fuel tank).
- The fuel tank is registered with Underwriters Laboratories Standard to meet or exceed U.L. 142
- The fuel tank includes a secondary containment basin to prevent escape of fuel into the environment in the event of a tank rupture.
- The generator operates below 50 horsepower.
- The generator includes a factory installed sound attenuated aluminum enclosure.
- The rated load sound output at 23 feet is 65 dB(A).
- The generator will be serviced approximately once every 6-months.
- Routine testing will occur once a week for approximately 15-minutes during normal business hours on a non-holiday weekday.

T··Mobile·



Above: View of typical 25kW Generac diesel generator.

In an effort to provide a more reliable network and to ensure continuous operation in the event of a power outage and/or emergency situation, T-Mobile is proposing to install a new 25kW diesel generator for backup power. As consumers increasingly use their wireless devices at home and in their neighborhoods, T-Mobile needs to ensure its network can continue to handle voice and data traffic during a power outage and/or emergency situation. By installing a permanent generator, for backup power, T-Mobile is better positioned to ensure its customers will have access to a more robust network when needed most. The proposed generator will not be detrimental to the public health, safety, or general welfare of the City of Visalia. The proposed facility will not materially or adversely affect adjacently located properties or their permitted uses. T-Mobile's wireless communications facility is a modern-day utility and will contribute to the provision of enhanced wireless communication technology for the general public and emergency services use.


WESTLLC

SR668 WEST COAST BROADCAST SC10106B

GENERATOR PROJECT 1401 W. CALDWELL VISALIA, CA 93277 TULARE COUNTY

SITE DIRECTIONS

DEPART 1755 CREEKSIDE OAKS DR, SACRAMENTO, CA 95833 ON CREEKSIDE OAKS DR (WEST). TURN LEFT (SOUTH-WEST) ONTO CAPITAL PARK DR. THEN IMMEDIATELY TURN LEFT (SOUTH) ONTO NATOMAS PARK DR. TURN RIGHT (WEST) ONTO GARDEN HWY. TAKE RAMP (RIGHT) ONTO 1-5 [CA-99]. TURN RIGHT ONTO RAMP. KEEP STRAIGHT TO STAY ON RAMP. TAKE RAMP (LEFT) ONTO I-80 BRANCH [US-50]. KEEP RIGHT ONTO RAMP [CA-99]. TAKE RAMP (RIGHT) ONTO CA-99 [GOLDEN STATE HWY S]. ROAD NAME CHANGES TO CA-12 [CA-99]. ROAD NAME CHANGES TO CA-99. ROAD NAME CHANGES TO CA-26 [CA-99]. AT EXIT 253, ROAD NAME CHANGES TO CA-4 [CA-99]. ROAD NAME CHANGES TO CA-99. ROAD NAME CHANGES TO CA-120 [CA-99]. ROAD NAME CHANGES TO CA-99. ROAD NAME CHANGES TO CA-140 [CA-99]. ROAD NAME CHANGES TO CA-99. AT EXIT 94, KEEP RIGHT ONTO RAMP. TURN LEFT (EAST) ONTO CR-J30 [AVENUE 280]. KEEP STRAIGHT ONTO CR-J30 [W CALDWELL AVE]. TURN RIGHT (SOUTH) ONTO S DIVISADERO ST, THEN IMMEDIATELY TURN LEFT (EAST) ONTO W JAMES AVE. BEAR LEFT (EAST) ONTO LOCAL ROAD(S). ARRIVE AT THE EXISTING SITE.

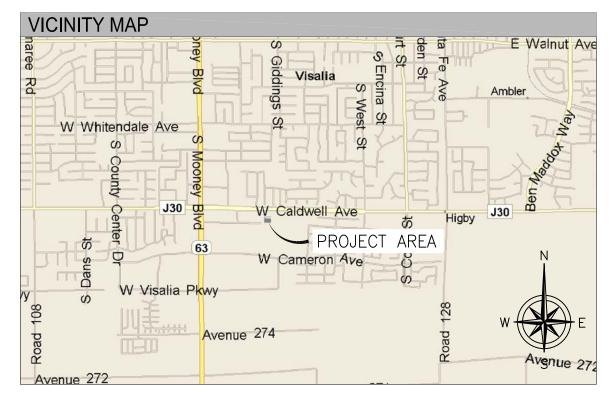

PROJECT DESCRIPTION

THE PROJECT CONSISTS OF INSTALLING (1) 200 AMP GENERAC AUTOMATIC TRANSFER SWITCH, (1) GENERAC 25KW DIESEL GENERATOR ON (N) CONCRETE PAD AND ASSOCIATED EQUIPMENT LOCATED WITHIN A (N) LEASE AREA. INSTALL CHAIN LINK FENCE

DEVELOPMENT AND CONSTRUCTION OF THIS PROJECT WILL COMPLY WITH ALL APPLICABLE CODES AND ORDINANCES.

THIS PROJECT DOES NOT INCLUDE WATER OR SEWER.

EXISTING PARKING IS NOT AFFECTED BY THIS PROJECT.

SHEET INDEX

- T−1 PROJECT INFORMATION AND DATA
- GN-1 GENERAL NOTES
- SITE PLAN A−1 ENLARGED SITE PLAN
- ELEVATIONS • A-3
- A-4 • A-5
- A-6
- E-1 ELECTRICAL DETAILS
- E-3 ELECTRICAL DETAILS
- DETAILS DETAILS STE 21. #464 GENERATOR SIGNAGE \bullet E-2 GROUNDING DETAILS PHONE: (602) 910-6030

T-MOBILE WEST, LLC 1755 CREEKSIDE OAKS DRIVE SUITE 190 SACRAMENTO, CA 95833

PROPERTY OWNER: LPHED LIMITED PARTNERSHIP

2100 NORTH COTTONWOOD ST VISALIA, CA 93291

PROJECT MANAGER: T-MOBILE WEST, LLC 1755 CREEKSIDE OAKS DRIVE

SUITE 190 SACRAMENTO, CA 95833 CONTACT: JIM MORAN PHONE: (707) 450-5653

SITE ACQUISITION:

Γ-MOBILE WEST, LLC 1755 CREEKSIDE OAKS DRIVE SUITE 190 SACRAMENTO, CA 95833 CONTACT: JEFF LIENERT PHONE: (916) 505-3683

CONSULTING FIRM:

SINGLE SOURCE INC. 4340 E. INDIAN SCHOOL RD PHOENIX, "AZ 85018 | CONTACT: JEREMY WATTERBERG

ZONING:

APN: 126-062-091

USE: PARENT PARCEL: - ACRES

EXISTING LEASE AREA: - SQ. FT

JURISDICTION: CITY OF VISALIA

BUILDING CODES:

2022 CALIFORNIA ADMINISTRATIVE CODE, PART 1, TITLE 24 C.C.R.

2022 CALIFORNIA BUILDING CODE (CBC), PART 2, VOLUMES 1 & 2 TITLE 24 C.C.R.

2022 CALIFORNIA ELECTRICAL CODE (CEC), PART 3, TITLE 24 C.C.R. 2022 CALIFORNIA MECHANICAL CODE (CMC), PART 4, TITLE 24 C.C.R.

2022 CALIFORNIA PLUMBING CODE (CPC), PART 5, TITLE 24 C.C.R.

2022 CALIFORNIA ENERGY CODE (CEC), PART 6, TITLE 24 C.C.R.

2022 CALIFORNIA FIRE CODE, PART 9, TITLE 24 C.C.R.

2022 CALIFORNIA GREEN BUILDING STANDARDS CODE, PART 11, TITLE 24 C.C.R. 2022 CALIFORNIA REFERENCED STARNDARDS, PART 12, TITLE 24 C.C.R. ANSI/EIA-TIA-222-H

ALONG WITH ANY OTHER APPLICABLE LOCAL & STATE LAWS AND REGULATIONS

POLE COORDINATES

LATITUDE: 36° 17' 50.7" NORTH (NAD83) LONGITUDE: -119° 18' 23.1" WEST (NAD83)

GENERAL NOTES

- . THIS WIRELESS TELECOMMUNICATIONS FACILITY WILL MEET THE HEALTH AND SAFETY STANDARDS FOR ELECTROMAGNETIC FIELD EMISSIONS AS ESTABLISHED BY THE FEDERAL COMMUNICATIONS COMMISSION OR ANY SUCCESSOR THEREOF, AND ANY OTHER FEDERAL OR STATE AGENCY.
- 2. THIS WIRELESS TELECOMMUNICATIONS FACILITY WILL MEET THE REGULATIONS OF THE FEDERAL COMMUNICATIONS COMMISSION REGARDING PHYSICAL AND ELECTROMAGNETIC INTERFERENCE.
- 3.LIGHTING OR SIGNS WILL BE PROVIDED ONLY AS REQUIRED BY FEDERAL OR STATE AGENCIES.

APPROVALS

T-MOBILE (RF): ____ DATE: _ DATE: _ T-MOBILE (CONST.): ____ DATE: _____ T-MOBILE (RE): _____ DATE: _ LANDLORD: _____





4340 E. INDIAN SCHOOL RD

	_		
L			
L			
	Α	8/21/22	ISSUE FOR REVIEW
ı	REV	DATE	DESCRIPTION

SR668 WEST COAST BROADCAST SC10106B

1401 W. CALDWELL VISALIA, CA 93277 TULARE COUNTY

SHEET TITLE INFORMATION AND

SHEET NUMBER

GENERAL NOTES:

- 1. FOR THE PURPOSE OF CONSTRUCTION DRAWING, THE FOLLOWING DEFINITIONS SHALL APPLY:

 CONTRACTOR THE

 SUBCONTRACTOR GENERAL CONTRACTOR (CONSTRUCTION)

 OWNER T-MOBILE
- 2. PRIOR TO THE SUBMISSION OF BIDS, THE BIDDING SUBCONTRACTOR SHALL VISIT THE CELL SITE TO FAMILIARIZE WITH THE EXISTING CONDITIONS AND TO CONFIRM THAT THE WORK CAN BE ACCOMPLISHED AS SHOWN ON THE CONSTRUCTION DRAWINGS. ANY DISCREPANCY FOUND SHALL BE BROUGHT TO THE ATTENTION OF CONTRACTOR.

OEM — ORIGINAL EQUIPMENT MANUFACTURE

- 3. ALL MATERIALS FURNISHED AND INSTALLED SHALL BE IN STRICT ACCORDANCE WITH ALL APPLICABLE CODES, REGULATIONS, AND ORDINANCES. SUBCONTRACTOR SHALL ISSUE ALL APPROPRIATE NOTICES AND COMPLY WITH ALL LAWS, ORDINANCES, RULES, REGULATIONS, AND LAWFUL ORDERS OF ANY PUBLIC AUTHORITY REGARDING THE PERFORMANCE OF THE WORK.ALL WORK CARRIED OUT SHALL COMPLY WITH ALL APPLICABLE MUNICIPAL AND UTILITY COMPANY SPECIFICATIONS AND LOCAL JURISDICTIONAL CODES, ORDINANCES AND APPLICABLE REGULATIONS.
- 4. DRAWINGS PROVIDED HERE ARE NOT TO BE SCALED AND ARE INTENDED TO SHOW OUTLINE
- 5. UNLESS NOTED OTHERWISE, THE WORK SHALL INCLUDE FURNISHING MATERIALS, EQUIPMENT, APPURTENANCES, AND LABOR NECESSARY TO COMPLETE ALL INSTALLATIONS AS INDICATED ON THE DRAWINGS.
- 6. DELETED.
- 7. THE SUBCONTRACTOR SHALL INSTALL ALL EQUIPMENT AND MATERIALS IN ACCORDANCE WITH MANUFACTURER'S RECOMMENDATIONS UNLESS SPECIFICALLY STATED OTHERWISE.
- 8. IF THE SPECIFIED EQUIPMENT CANNOT BE INSTALLED AS SHOWN ON THESE DRAWINGS, THE SUBCONTRACTOR SHALL PROPOSE AN ALTERNATIVE INSTALLATION FOR APPROVAL BY THE CONTRACTOR.
- 9. SUBCONTRACTOR SHALL DETERMINE ACTUAL ROUTING OF CONDUIT, POWER AND T1 CABLES, GROUNDING CABLES AS SHOWN ON THE POWER, GROUNDING AND TELCO PLAN DRAWING.

 SUBCONTRACTOR SHALL UTILIZE EXISTING TRAYS AND/OR SHALL ADD NEW TRAYS AS NECESSARY. SUBCONTRACTOR SHALL CONFIRM THE ACTUAL ROUTING WITH THE CONTRACTOR. ROUTING OF TRENCHING SHALL BE APPROVED BY CONTRACTOR
- 10. THE SUBCONTRACTOR SHALL PROTECT EXISTING IMPROVEMENTS, PAVEMENTS, CURBS, LANDSCAPING AND STRUCTURES. ANY DAMAGED PART SHALL BE REPAIRED AT SUBCONTRACTOR'S EXPENSE TO THE SATISFACTION OF OWNER.
- 11. SUBCONTRACTOR SHALL LEGALLY AND PROPERLY DISPOSE OFF ALL SCRAP MATERIALS SUCH AS COAXIAL CABLES AND OTHER ITEMS REMOVED FROM THE EXISTING FACILITY. ANTENNAS REMOVED SHALL BE RETURNED TO THE OWNER'S DESIGNATED LOCATION.
- 12. SUBCONTRACTOR SHALL LEAVE PREMISES IN CLEAN CONDITION.
- 13. ALL CONCRETE REPAIR WORK SHALL BE DONE IN ACCORDANCE WITH AMERICAN CONCRETE INSTITUTE (ACI) 301.
- 14. ANY NEW CONCRETE NEEDED FOR THE CONSTRUCTION SHALL HAVE 4000 PSI STRENGTH AT 28 DAYS UNLESS OTHERWISE SPECIFIED.ALL CONCRETING WORK SHALL BE DONE IN ACCORDANCE WITH ACI 318 CODE REQUIREMENTS.
- 15. ALL STRUCTURAL STEEL WORK SHALL BE DONE IN ACCORDANCE WITH AISC SPECIFICATIONS.
- 16. CONSTRUCTION SHALL COMPLY WITH SPECIFICATION 25741-000-3APS-AOOZ-00002, "GENERAL CONSTRUCTION SERVICES.
- 17. SUBCONTRACTOR SHALL VERIFY ALL EXISTING DIMENSIONS AND CONDITIONS PRIOR TO COMMENCING ANY WORK. ALL DIMENSIONS OF EXISTING CONSTRUCTION SHOWN ON THE DRAWINGS MUST BE VERIFIED. SUBCONTRACTOR SHALL NOTIFY THE CONTRACTOR OF ANY DISCREPANCIES PRIOR TO ORDERING MATERIAL OR PROCEEDING WITH CONSTRUCTION.
- 18. THE EXISTING CELL SITE IS IN FULL COMMERCIAL OPERATION. ANY CONSTRUCTION WORK BY SUBCONTRACTOR SHALL NOT DISRUPT THE EXISTING NORMAL OPERATION. ANY WORK ON EXISTING EQUIPMENT MUST BE COORDINATED WITH CONTRACTOR. ALSO, WORK MAY NEED TO BE SCHEDULED FOR AN APPROPRIATE MAINTENANCE WINDOW USUALLY IN LOW TRAFFIC PERIODS
- 19. SINCE THE CELL SITE MAY BE ACTIVE, ALL SAFETY PRECAUTIONS MUST BE TAKEN WHEN WORKING AROUND HIGH LEVELS OF ELECTROMAGNETIC RADIATION. EQUIPMENT SHOULD BE SHUTDOWN PRIOR TO PERFORMING ANY WORK THAT COULD EXPOSE THE WORKERS TO DANGER. PERSONAL RF EXPOSURE MONITORS ARE REQUIRED TO BE WORN TO ALERT OF ANY DANGEROUS EXPOSURE LEVELS.

CONCRETE AND REINFORCING STEEL NOTES:

NOTED OTHERWISE.

- 1. ALL CONCRETE WORK SHALL BE IN ACCORDANCE WITH THE ACI 301, ACI 318, ACI 336, ASTM A184, ASTM A185 AND THE DESIGN AND CONSTRUCTION SPECIFICATION FOR CAST—IN—PLACE CONCRETE.
- 2. ALL CONCRETE SHALL HAVE A MINIMUM COMPRESSIVE STRENGTH OF 4000 PSI AT 28 DAYS, UNLESS
- 3. REINFORCING STEEL SHALL CONFORM TO ASTM A 615, GRADE 60, DEFORMED UNLESS NOTED OTHERWISE. WELDED WIRE FABRIC SHALL CONFORM TO ASTM A 185 WELDED STEEL WIRE FABRIC UNLESS NOTED OTHERWISE. SPLICES SHALL BE CLASS "B" AND ALL HOOKS SHALL BE STANDARD,
- 4. THE FOLLOWING MINIMUM CONCRETE COVER SHALL BE PROVIDED FOR REINFORCING STEEL UNLESS SHOWN OTHERWISE ON DRAWINGS:

CONCRETE NOT EXPOSED TO EARTH OR WEATHER OR NOT

ACI 301 SECTION 4.2.4.

5. POST INSTALLED ANCHORS SHALL BE PROVIDED IN ACCORDANCE WITH SPECIFICATION
3GS-T18-00013 "SELECTION, DESIGN, INSTALLATION, INSPECTION AND TESTING OF ADHESIVE AND

A CHAMFER 3/4" SHALL BE PROVIDED AT ALL EXPOSED EDGES OF CONCRETE, UNO, IN ACCORDANCE WITH

NO REINFORCING STEEL SHALL BE CUT WITHOUT PRIOR ENGINEERING APPROVAL.

6. CONCRETE CYLINDER TEST IS NOT REQUIRED FOR SLAB ON GRADE WHEN CONCRETE IS LESS THAN 50 CUBIC YARDS (IBC 1905.6.2) IN THAT EVENT THE FOLLOWING RECORDS SHALL BE PROVIDED

APPROVED EQUAL, INSTALLED, INSPECTED AND TESTED AS SHOWN ON THE DESIGN DRAWINGS.

MECHANICAL EXPANSION ANCHORS FOR WIRELESS SITE FACILITIES". ANCHORS SHALL BE HILTI OR

- BY THE CONCRETE SUPPLIER;
- (A) RESULTS OF CONCRETE CYLINDER TESTS PERFORMED AT THE SUPPLIER'S PLANT,
- (B) CERTIFICATION OF MINIMUM COMPRESSIVE STRENGTH FOR THE CONCRETE GRADE SUPPLIED.
- FOR GREATER THAN 50 CUBIC YARDS THE GC SHALL PERFORM THE CONCRETE CYLINDER TEST, TAKING THREE CYLINDERS FROM EACH TRUCK.

GROUNDING NOTES:

- 1. THE SUBCONTRACTOR SHALL REVIEW AND INSPECT THE EXISTING FACILITY GROUNDING SYSTEM AND LIGHTNING PROTECTION SYSTEM (AS DESIGNED AND INSTALLED) FOR STRICT COMPLIANCE WITH THE NEC (AS ADOPTED BY THE AHJ), THE SITE—SPECIFIC (UL, LPI, OR NFPA) LIGHTING PROTECTION CODE, AND GENERAL COMPLIANCE WITH TELCORDIA AND TIA GROUNDING STANDARDS. THE SUBCONTRACTOR SHALL REPORT ANY VIOLATIONS OR ADVERSE FINDINGS TO THE CONTRACTOR FOR RESOLUTION.
- 2. ALL GROUND ELECTRODE SYSTEMS (INCLUDING TELECOMMUNICATION, RADIO, LIGHTNING PROTECTION, AND AC POWER GES'S) SHALL BE BONDED TOGETHER, AT OR BELOW GRADE, BY TWO OR MORE COPPER BONDING CONDUCTORS IN ACCORDANCE WITH THE NEC.
- 3. THE SUBCONTRACTOR SHALL PERFORM IEEE FALL-OF-POTENTIAL RESISTANCE TO EARTH TESTING (PER IEEE 1100 AND 81) FOR NEW GROUND ELECTRODE SYSTEMS. THE SUBCONTRACTOR SHALL FURNISH AND INSTALL SUPPLEMENTAL GROUND ELECTRODES AS NEEDED TO ACHIEVE A TEST RESULT OF 5 OHMS OR LESS. TESTS SHALL BE PERFORMED IN ACCORDANCE WITH 25471-000-3PS-EG00-0001, DESIGN & TESTING OF FACILITY GROUNDING FOR CELL SITES.
- 4. METAL RACEWAY SHALL NOT BE USED AS THE NEC REQUIRED EQUIPMENT GROUND CONDUCTOR. STRANDED COPPER CONDUCTORS WITH GREEN INSULATION, SIZED IN ACCORDANCE WITH THE NEC, SHALL BE FURNISHED AND INSTALLED WITH THE POWER CIRCUITS TO BTS EQUIPMENT.
- 5. EACH BTS CABINET FRAME SHALL BE DIRECTLY CONNECTED TO THE MASTER GROUND BAR WITH GREEN INSULATED SUPPLEMENTAL EQUIPMENT GROUND WIRES, 6 AWG STRANDED COPPER OR LARGER FOR INDOOR BTS; 2 AWG STRANDED COPPER FOR OUTDOOR BTS.
- 6. EXOTHERMIC WELDS SHALL BE USED FOR ALL GROUNDING CONNECTIONS BELOW GRADE.
- 7. APPROVED ANTIOXIDANT COATINGS (I.E., CONDUCTIVE GEL OR PASTE) SHALL BE USED ON ALL COMPRESSION AND BOLTED GROUND CONNECTIONS.
- 8. ICE BRIDGE BONDING CONDUCTORS SHALL BE EXOTHERMICALLY BONDED OR BOLTED WITH STAINLESS STEEL HARDWARE TO THE BRIDGE AND THE MONOPOLE GROUND BAR.
- 9. ALUMINUM CONDUCTOR OR COPPER CLAD STEEL CONDUCTOR SHALL NOT BE USED FOR GROUNDING CONNECTIONS.
- 10. MISCELLANEOUS ELECTRICAL AND NON-ELECTRICAL METAL BOXES, FRAMES AND SUPPORTS SHALL BE BONDED TO THE GROUND RING, IN ACCORDANCE WITH THE NEC.
- 11. METAL CONDUIT AND TRAY SHALL BE GROUNDED AND MADE ELECTRICALLY CONTINUOUS WITH LISTED BONDING FITTINGS OR BY BONDING ACROSS THE DISCONTINUITY WITH 6 AWG COPPER WIRE UL APPROVED GROUNDING TYPE CONDUIT CLAMPS.
- 12. GROUND CONDUCTORS USED IN THE FACILITY GROUND AND LIGHTNING PROTECTION SYSTEMS SHALL NOT BE ROUTED THROUGH METALLIC OBJECTS THAT FORM A RING AROUND THE CONDUCTOR, SUCH AS METALLIC CONDUITS, METAL SUPPORT CLIPS OR SLEEVES THROUGH WALLS OR FLOORS. WHEN IT IS REQUIRED TO BE HOUSED IN CONDUIT TO MEET CODE REQUIREMENTS OR LOCAL CONDITIONS, NON-METALLIC MATERIAL SUCH AS PVC PLASTIC CONDUIT SHALL BE USED. WHERE USE OF METAL CONDUIT IS UNAVOIDABLE (E.G., NON-METALLIC CONDUIT PROHIBITED BY LOCAL CODE) THE GROUND CONDUCTOR SHALL BE BONDED TO EACH END OF THE METAL CONDUIT.
- 13. ALL MONOPOLE GROUNDING SYSTEMS SHALL COMPLY WITH THE REQUIREMENTS OF ANSI/TIA 222.
- MONOPOLES BEING BUILT TO REV G OF THE STANDARD, THE WIRE SIZE OF THE BURIED GROUND RING AND CONNECTIONS BETWEEN THE MONOPOLE AND THE BURIED GROUND RING SHALL BE CHANGED FROM 2 AWG TO 2/O AWG. IN ADDITION, THE MINIMUM LENGTH OF THE GROUND RODS SHALL BE INCREASED FROM 8 FEET TO 10 FEET.

SITE WORK GENERAL NOTES:

- THE SUBCONTRACTOR SHALL CONTACT UTILITY LOCATING SERVICES PRIOR TO THE START OF CONSTRUCTION.
- 2. ALL EXISTING ACTIVE SEWER, WATER, GAS, ELECTRIC, AND OTHER UTILITIES WHERE ENCOUNTERED IN THE WORK, SHALL BE PROTECTED AT ALL TIMES, AND WHERE REQUIRED FOR THE PROPER EXECUTION OF THE WORK, SHALL BE RELOCATED AS DIRECTED BY CONTRACTOR. EXTREME CAUTION SHOULD BE USED BY THE SUBCONTRACTOR WHEN EXCAVATING OR DRILLING PIERS AROUND OR NEAR UTILITIES. SUBCONTRACTOR SHALL PROVIDE SAFETY TRAINING FOR THE WORKING CREW. THIS WILL INCLUDE BUT NOT BE LIMITED TO A) FALL PROTECTION B) CONFINED SPACE C) ELECTRICAL SAFETY D) TRENCHING & EXCAVATION.
- 3. ALL SITE WORK SHALL BE AS INDICATED ON THE DRAWINGS AND PROJECT SPECIFICATIONS.
- 4. IF NECESSARY, RUBBISH, STUMPS, DEBRIS, STICKS, STONES AND OTHER REFUSE SHALL BE REMOVED FROM THE SITE AND DISPOSED OFF LEGALLY.
- 5. ALL EXISTING INACTIVE SEWER, WATER, GAS, ELECTRIC AND OTHER UTILITIES, WHICH INTERFERE WITH THE EXECUTION OF THE WORK, SHALL BE REMOVED AND/OR CAPPED, PLUGGED OR OTHERWISE DISCONTINUED AT POINTS WHICH WILL NOT INTERFERE WITH THE EXECUTION OF THE WORK, SUBJECT TO THE APPROVAL OF CONTRACTOR, OWNER AND/OR LOCAL UTILITIES.
- 6. SUBCONTRACTOR SHALL MINIMIZE DISTURBANCE TO EXISTING SITE DURING CONSTRUCTION.
- 7. THE SUBCONTRACTOR SHALL PROVIDE SITE SIGNAGE IN ACCORDANCE WITH THE T-MOBILE WIRELESS SPECIFICATION FOR SITE SIGNAGE.
- 8. THE SITE SHALL BE GRADED TO CAUSE SURFACE WATER TO FLOW AWAY FROM THE BTS EQUIPMENT AND MONOPOLE AREAS.
- 9. NO FILL OR EMBANKMENT MATERIAL SHALL BE PLACED ON FROZEN GROUND. FROZEN MATERIALS, SNOW OR ICE SHALL NOT BE PLACED IN ANY FILL OR EMBANKMENT.
- 10. THE SUB GRADE SHALL BE COMPACTED AND BROUGHT TO A SMOOTH UNIFORM GRADE PRIOR TO FINISHED SURFACE APPLICATION.
- 11. THE AREAS OF THE OWNERS PROPERTY DISTURBED BY THE WORK AND NOT COVERED BY THE MONOPOLE, EQUIPMENT OR DRIVEWAY, SHALL BE GRADED TO A UNIFORM SLOPE, AND STABILIZED TO PREVENT EROSION.
- 12. SUBCONTRACTOR SHALL MINIMIZE DISTURBANCE TO EXISTING SITE DURING CONSTRUCTION. EROSION CONTROL MEASURES, IF REQUIRED DURING CONSTRUCTION, SHALL BE IN CONFORMANCE WITH THE LOCAL JURISDICTION'S GUIDELINES FOR EROSION AND SEDIMENT CONTROL.

- ELECTRICAL INSTALLATION NOTES:
- 1. WIRING, RACEWAY, AND SUPPORT METHODS AND MATERIALS SHALL COMPLY WITH THE REQUIREMENTS OF THE NEC AND TELCORDIA.
- 2. SUBCONTRACTOR SHALL MODIFY EXISTING CABLE TRAY SYSTEM AS REQUIRED TO SUPPORT RF AND TRANSPORT CABLING TO THE NEW BTS EQUIPMENT. SUBCONTRACTOR SHALL SUBMIT MODIFICATIONS TO CONTRACTOR FOR APPROVAL.
- 3. ALL CIRCUITS SHALL BE SEGREGATED AND MAINTAIN MINIMUM CABLE SEPARATION AS REQUIRED BY THE NEC AND TELCORDIA.
- 4. CABLES SHALL NOT BE ROUTED THROUGH LADDER-STYLE CABLE TRAY RUNGS.
- 5. EACH END OF EVERY POWER, GROUNDING, AND T1 CONDUCTOR AND CABLE SHALL BE LABELED WITH COLOR-CODED INSULATION OR ELECTRICAL TAPE (3M BRAND, 1/2 INCH PLASTIC ELECTRICAL TAPE WITH UV PROTECTION, OR EQUAL). THE IDENTIFICATION METHOD SHALL CONFORM WITH NEC & OSHA, AND MATCH EXISTING INSTALLATION REQUIREMENTS.
- 6. POWER PHASE CONDUCTORS (I.E., HOTS) SHALL BE LABELED WITH COLOR—CODED INSULATION OR ELECTRICAL TAPE (3M BRAND, ½ INCH PLASTIC ELECTRICAL TAPE WITH UV PROTECTION, OR EQUAL). PHASE CONDUCTOR COLOR CODES SHALL CONFORM WITH THE NEC & OSHA AND MATCH EXISTING INSTALLATION REQUIREMENTS.
- 7. ALL ELECTRICAL COMPONENTS SHALL BE CLEARLY LABELED WITH ENGRAVED LAMACOID PLASTIC LABELS. ALL EQUIPMENT SHALL BE LABELED WITH THEIR VOLTAGE RATING, PHASE CONFIGURATION, WIRE CONFIGURATION, POWER OR AMPACITY RATING, AND BRANCH CIRCUIT ID NUMBERS (I.E., PANELBOARD AND CIRCUIT ID'S).
- 8. PANELBOARDS (ID NUMBERS) AND INTERNAL CIRCUIT BREAKERS (CIRCUIT ID NUMBERS) SHALL BE CLEARLY LABELED WITH ENGRAVED LAMACOID PLASTIC LABELS.
- 9. ALL TIE WRAPS WHERE PERMITTED SHALL BE CUT FLUSH WITH APPROVED CUTTING TOOL TO REMOVE SHARP EDGES. USE LOW PROFILES TIE WRAPS.
- 10. POWER, CONTROL, AND EQUIPMENT GROUND WIRING IN TUBING OR CONDUIT SHALL BE SINGLE CONDUCTOR (12 AWG OR LARGER), 600 V, OIL RESISTANT THHN OR THWN—2, CLASS B STRANDED COPPER CABLE RATED FOR 90 °C (WET AND DRY) OPERATION; LISTED OR LABELED FOR THE LOCATION AND RACEWAY SYSTEM USED, UNLESS OTHERWISE SPECIFIED.
- 11. SUPPLEMENTAL EQUIPMENT GROUND WIRING LOCATED INDOORS SHALL BE SINGLE CONDUCTOR (6 AWG OR LARGER), 600 V, OIL RESISTANT THHN OR THWN-2 GREEN INSULATION, CLASS B STRANDED COPPER CABLE RATED FOR 90 °C (WET AND DRY) OPERATION; LISTED OR LABELED FOR THE LOCATION AND RACEWAY SYSTEM USED, UNLESS OTHERWISE SPECIFIED.
- 12. SUPPLEMENTAL EQUIPMENT GROUND WIRING LOCATED OUTDOORS, OR BELOW GRADE, SHALL BE SINGLE CONDUCTOR 2 AWG SOLID TINNED COPPER CABLE, UNLESS OTHERWISE SPECIFIED.
- 13. POWER WIRING, NOT IN TUBING OR CONDUIT, SHALL BE MULTI-CONDUCTOR, TYPE TC CABLE (12 AWG OR LARGER), 600 V, OIL RESISTANT THHN OR THWN-2, CLASS B STRANDED COPPER CABLE RATED FOR 90 °C (WET AND DRY) OPERATION; WITH OUTER JACKET; LISTED OR LABELED FOR THE LOCATION USED, UNLESS OTHERWISE SPECIFIED.
- 14. ALL POWER AND GROUNDING CONNECTIONS SHALL BE CRIMP—STYLE, COMPRESSION WIRE LUGS AND WIRENUTS BY THOMAS AND BETTS (OR EQUAL). LUGS AND WIRENUTS SHALL BE RATED FOR OPERATION AT NO LESS THAN 75°C (90°C IF AVAILABLE).
- 15. RACEWAY AND CABLE TRAY SHALL BE LISTED OR LABELED FOR ELECTRICAL USE IN ACCORDANCE WITH NEMA, UL, ANSI/IEEE, AND NEC.
- 16. NEW RACEWAY OR CABLE TRAY WILL MATCH THE EXISTING INSTALLATION WHERE POSSIBLE.
- 17. ELECTRICAL METALLIC TUBING (EMT) OR RIGID NONMETALLIC CONDUIT (I.E., RIGID PVC SCHEDULE 40, OR RIGID PVC SCHEDULE 80 FOR LOCATIONS SUBJECT TO PHYSICAL DAMAGE) SHALL BE USED FOR EXPOSED INDOOR LOCATIONS.
- 18. ELECTRICAL METALLIC TUBING (EMT), ELECTRICAL NONMETALLIC TUBING (ENT), OR RIGID NONMETALLIC CONDUIT (RIGID PVC, SCHEDULE 40) SHALL BE USED FOR CONCEALED INDOOR
- 19. GALVANIZED STEEL INTERMEDIATE METALLIC CONDUIT (IMC) SHALL BE USED FOR OUTDOOR LOCATIONS ABOVE GRADE.
- 20. RIGID NONMETALLIC CONDUIT (I.E., RIGID PVC SCHEDULE 40 OR RIGID PVC SCHEDULE 80) SHALL BE USED UNDERGROUND; DIRECT BURIED, IN AREAS OF OCCASIONAL LIGHT VEHICLE TRAFFIC OR ENCASED IN REINFORCED CONCRETE IN AREAS OF HEAVY VEHICLE TRAFFIC.
- 21. LIQUID-TIGHT FLEXIBLE METALLIC CONDUIT (LIQUID-TITE FLEX) SHALL BE USED INDOORS AND OUTDOORS, WHERE VIBRATION OCCURS OR FLEXIBILITY IS NEEDED.
- 22. CONDUIT AND TUBING FITTINGS SHALL BE THREADED OR COMPRESSION—TYPE AND APPROVED FOR THE LOCATION USED. SETSCREW FITTINGS ARE NOT ACCEPTABLE.
- 23. CABINETS, BOXES, AND WIREWAYS SHALL BE LISTED OR LABELED FOR ELECTRICAL USE IN ACCORDANCE WITH NEMA, UL, ANSI/IEEE, AND NEC.
- 24. CABINETS, BOXES, AND WIREWAYS TO MATCH THE EXISTING INSTALLATION WHERE POSSIBLE.
- 25. WIREWAYS SHALL BE EPOXY—COATED (GRAY) AND INCLUDE A HINGED COVER, DESIGNED TO SWING OPEN DOWNWARD; SHALL BE PANDUIT TYPE E (OR EQUAL); AND RATED NEMA 1 (OR BETTER) INDOORS, OR NEMA 3R (OR BETTER) OUTDOORS.
- 26. EQUIPMENT CABINETS, TERMINAL BOXES, JUNCTION BOXES, AND PULL BOXES SHALL BE GALVANIZED OR EPOXY—COATED SHEET STEEL, SHALL MEET OR EXCEED UL 50, AND RATED NEMA 1 (OR BETTER) INDOORS, OR NEMA 3R (OR BETTER) OUTDOORS
- 27. METAL RECEPTACLE, SWITCH, AND DEVICE BOXES SHALL BE GALVANIZED, EPOXY—COATED, OR NON—CORRODING; SHALL MEET OR EXCEED UL 514A AND NEMA OS 1; AND RATED NEMA 1 (OR BETTER) INDOORS, OR WEATHER PROTECTED (WP OR BETTER) OUTDOORS.
- 28. NONMETALLIC RECEPTACLE, SWITCH, AND DEVICE BOXES SHALL MEET OR EXCEED NEMA OS 2;
 AND RATED NEMA 1 (OR BETTER) INDOORS, OR WEATHER PROTECTED (WP OR BETTER) OUTDOORS.
- 29. THE SUBCONTRACTOR SHALL NOTIFY AND OBTAIN NECESSARY AUTHORIZATION FROM THE
- CONTRACTOR BEFORE COMMENCING WORK ON THE AC POWER DISTRIBUTION PANELS.
- 30. THE SUBCONTRACTOR SHALL PROVIDE NECESSARY TAGGING ON THE BREAKERS, CABLES AND DISTRIBUTION PANELS IN ACCORDANCE WITH THE APPLICABLE CODES AND STANDARDS TO SAFEGUARD AGAINST LIFE AND PROPERTY.

SOIL COMPACTION NOTES FOR SLAB ON GRADE:

- 1. EXCAVATE AS REQUIRED TO REMOVE VEGETATION & TOPSOIL EXPOSE UNDISTURBED NATURAL SUBGRADE AND PLACE CRUSHED STONE AS REQUIRED.
- 2a. COMPACTION CERTIFICATION: AN INSPECTION AND WRITTEN CERTIFICATION BY A QUALIFIED GEOTECHNICAL TECHNICIAN OR ENGINEER IS ACCEPTABLE.
- 2b. AS AN ALTERNATIVE TO ITEM 2a. THE "UNDISTURBED SOIL" BASE SHALL BE COMPACTED WITH "COMPACTION EQUIPMENT", LISTED BELOW, TO AT LEAST 90% MODIFIED PROCTOR MAXIMUM DENSITY PER ASTM D 1557 METHOD C.
- 2c. AS AN ALTERNATIVE TO ITEMS 2a AND 2b PROOFROLL THE SUBGRADE SOILS WITH 5 PASSES OF A MEDIUM SIZED VIBRATORY PLATE COMPACTOR (SUCH AS BOMAG BPR 30/38) OR HAND-OPERATED SINGLE DRUM VIBRATORY ROLLER (SUCH AS BOMAG BW 55E). ANY SOFT AREAS THAT ARE ENCOUNTERED SHOULD BE REMOVED AND REPLACED WITH A WELL-GRADED GRANULAR FILL, AND COMPACTED AS STATED ABOVE.
- 3. COMPACTED SUBBASE SHALL BE UNIFORM & LEVELED. PROVIDE 6"
 MINIMUM CRUSHED STONE OR GRAVEL COMPACTED IN 3" LIFTS ABOVE
 COMPACTED SOIL. GRAVEL SHALL BE NATURAL OR CRUSHED WITH 100%
 PASSING 1" SIEVE.

COMPACTION EQUIPMENT:

HAND OPERATED DOUBLE DRUM, VIBRATORY ROLLER, VIBRATORY PLATE COMPACTOR OR JUMPING JACK COMPACTOR.

SYMBOLS

_____SUPPLEMENTAL GROUND BAR

S/G SOLID GROUND BUS BAR

S/N SOLID NEUTRAL BUS BAR

2-POLE THERMAL-MAGNETIC CIRCUIT BREAKER

SINGLE-POLE THERMAL-MAGNETIC CIRCUIT BREAKER

CHEMICAL GROUND ROD

DISCONNECT SWITCH

■ CADWELD TYPE CONNECTION

GROUND ROD

COMPRESSION TYPE CONNECTION

----- GROUNDING WIRE

ABBREVIATIONS

- AGL ABOVE GRADE LEVEL
- BTS BASE TRANSCEIVER STATION
- (E) EXISTING
- NEW NEW
- MIN MINIMUM
- N.T.S. NOT TO SCALE
- REF REFERENCE

RF RADIO FREQUENCY

- TYP TYPICAL
- REQ REQUIRED
- EGR EQUIPMENT GROUND RING
- AWG AMERICAN WIRE GAUGE
- CRGB MASTER GROUND BAR (MASTER GROUND BAR)
- EG EQUIPMENT GROUND
- BCW BARE COPPER WIRE
- SIAD SMART INTEGRATED ACCESS DEVICE
- GEN GENERATOR
- IGR INTERIOR GROUND RING (HALO)
- RBS RADIO BASE STATION

SYMBOLS & ABBREVIATIONS

T - Mobile

1755 CREEKSIDE OAKS DRIVE SUITE 190 SACRAMENTO, CA 95833

CONSULTING FIRM

PREPARED FOR:



4340 E. INDIAN SCHOOL RD STE 21. #464 PHOENIX, AZ 85018 PHONE: 602-910-6030 FAX: 480-279-1271

PROJECT NO: 0000

DRAWN BY: CH

CHECKED BY: GH

A 8/21/22 ISSUE FOR REVIEW
REV DATE DESCRIPTION

SR668 WEST COAST BROADCAST SC10106B

1401 W. CALDWELL


SHEET TITLE


GENERAL NOTES

VISALIA, CA 93277 TULARE COUNTY

SHEET NUMBER



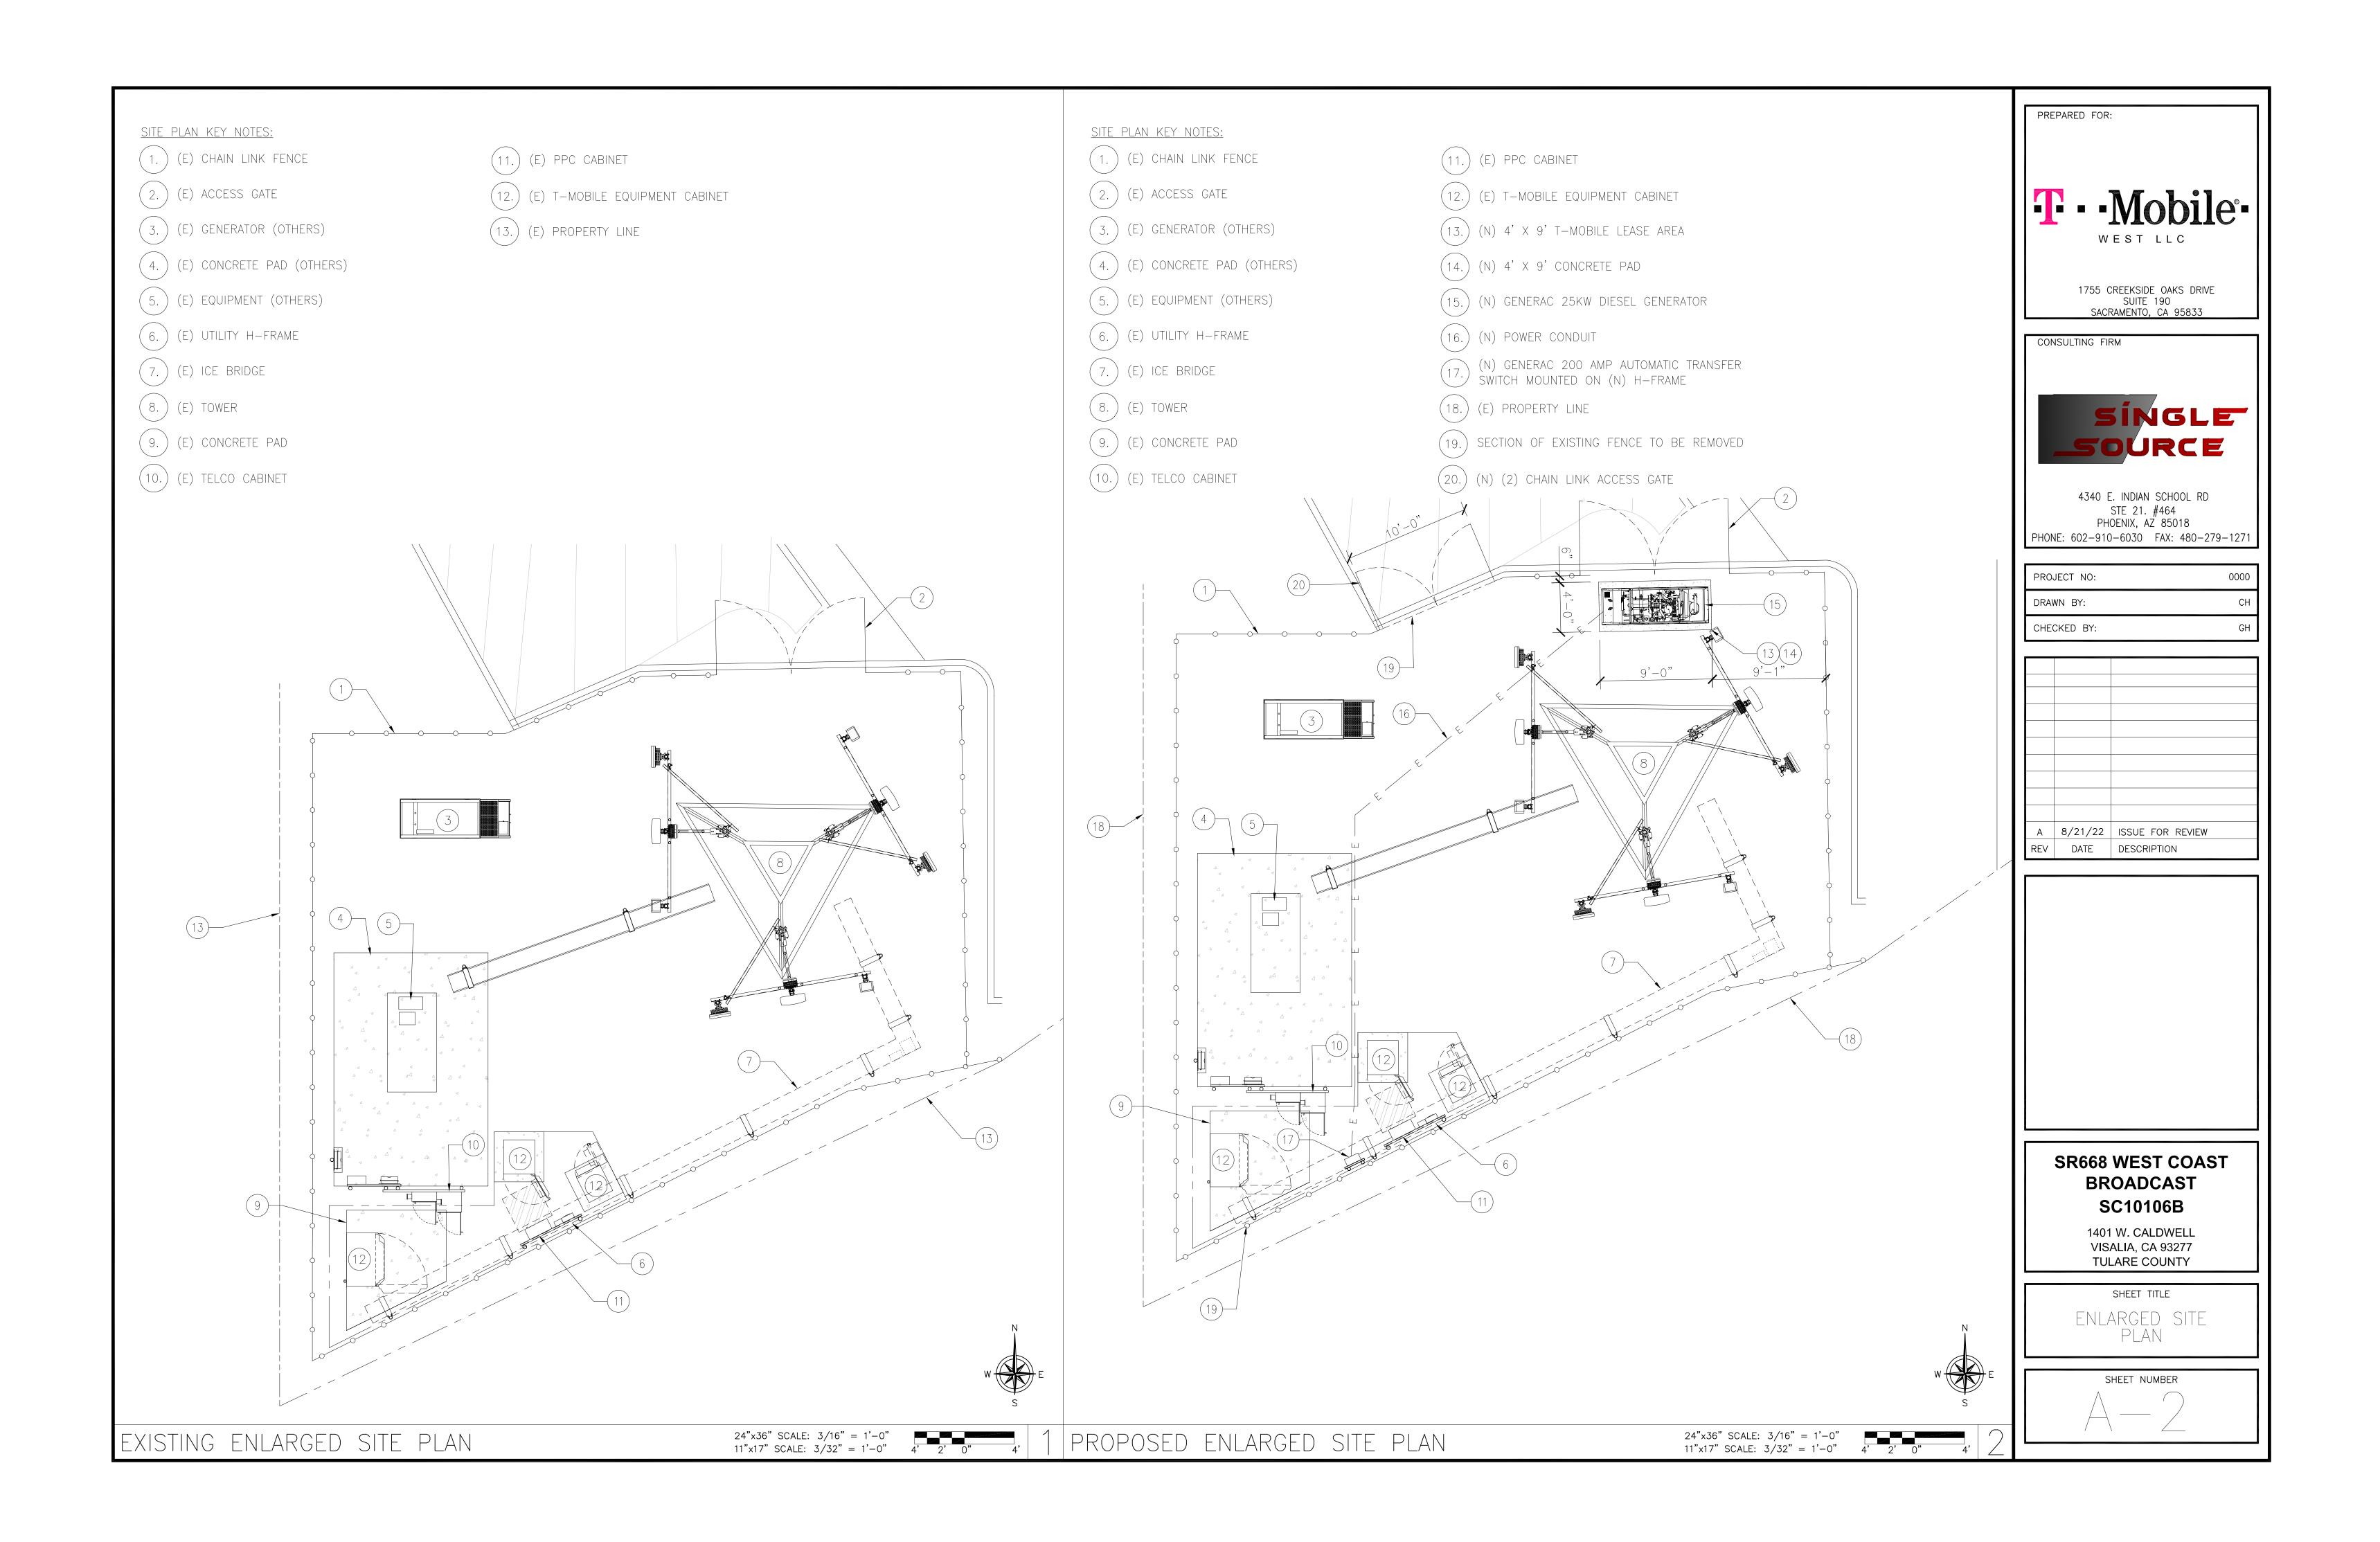

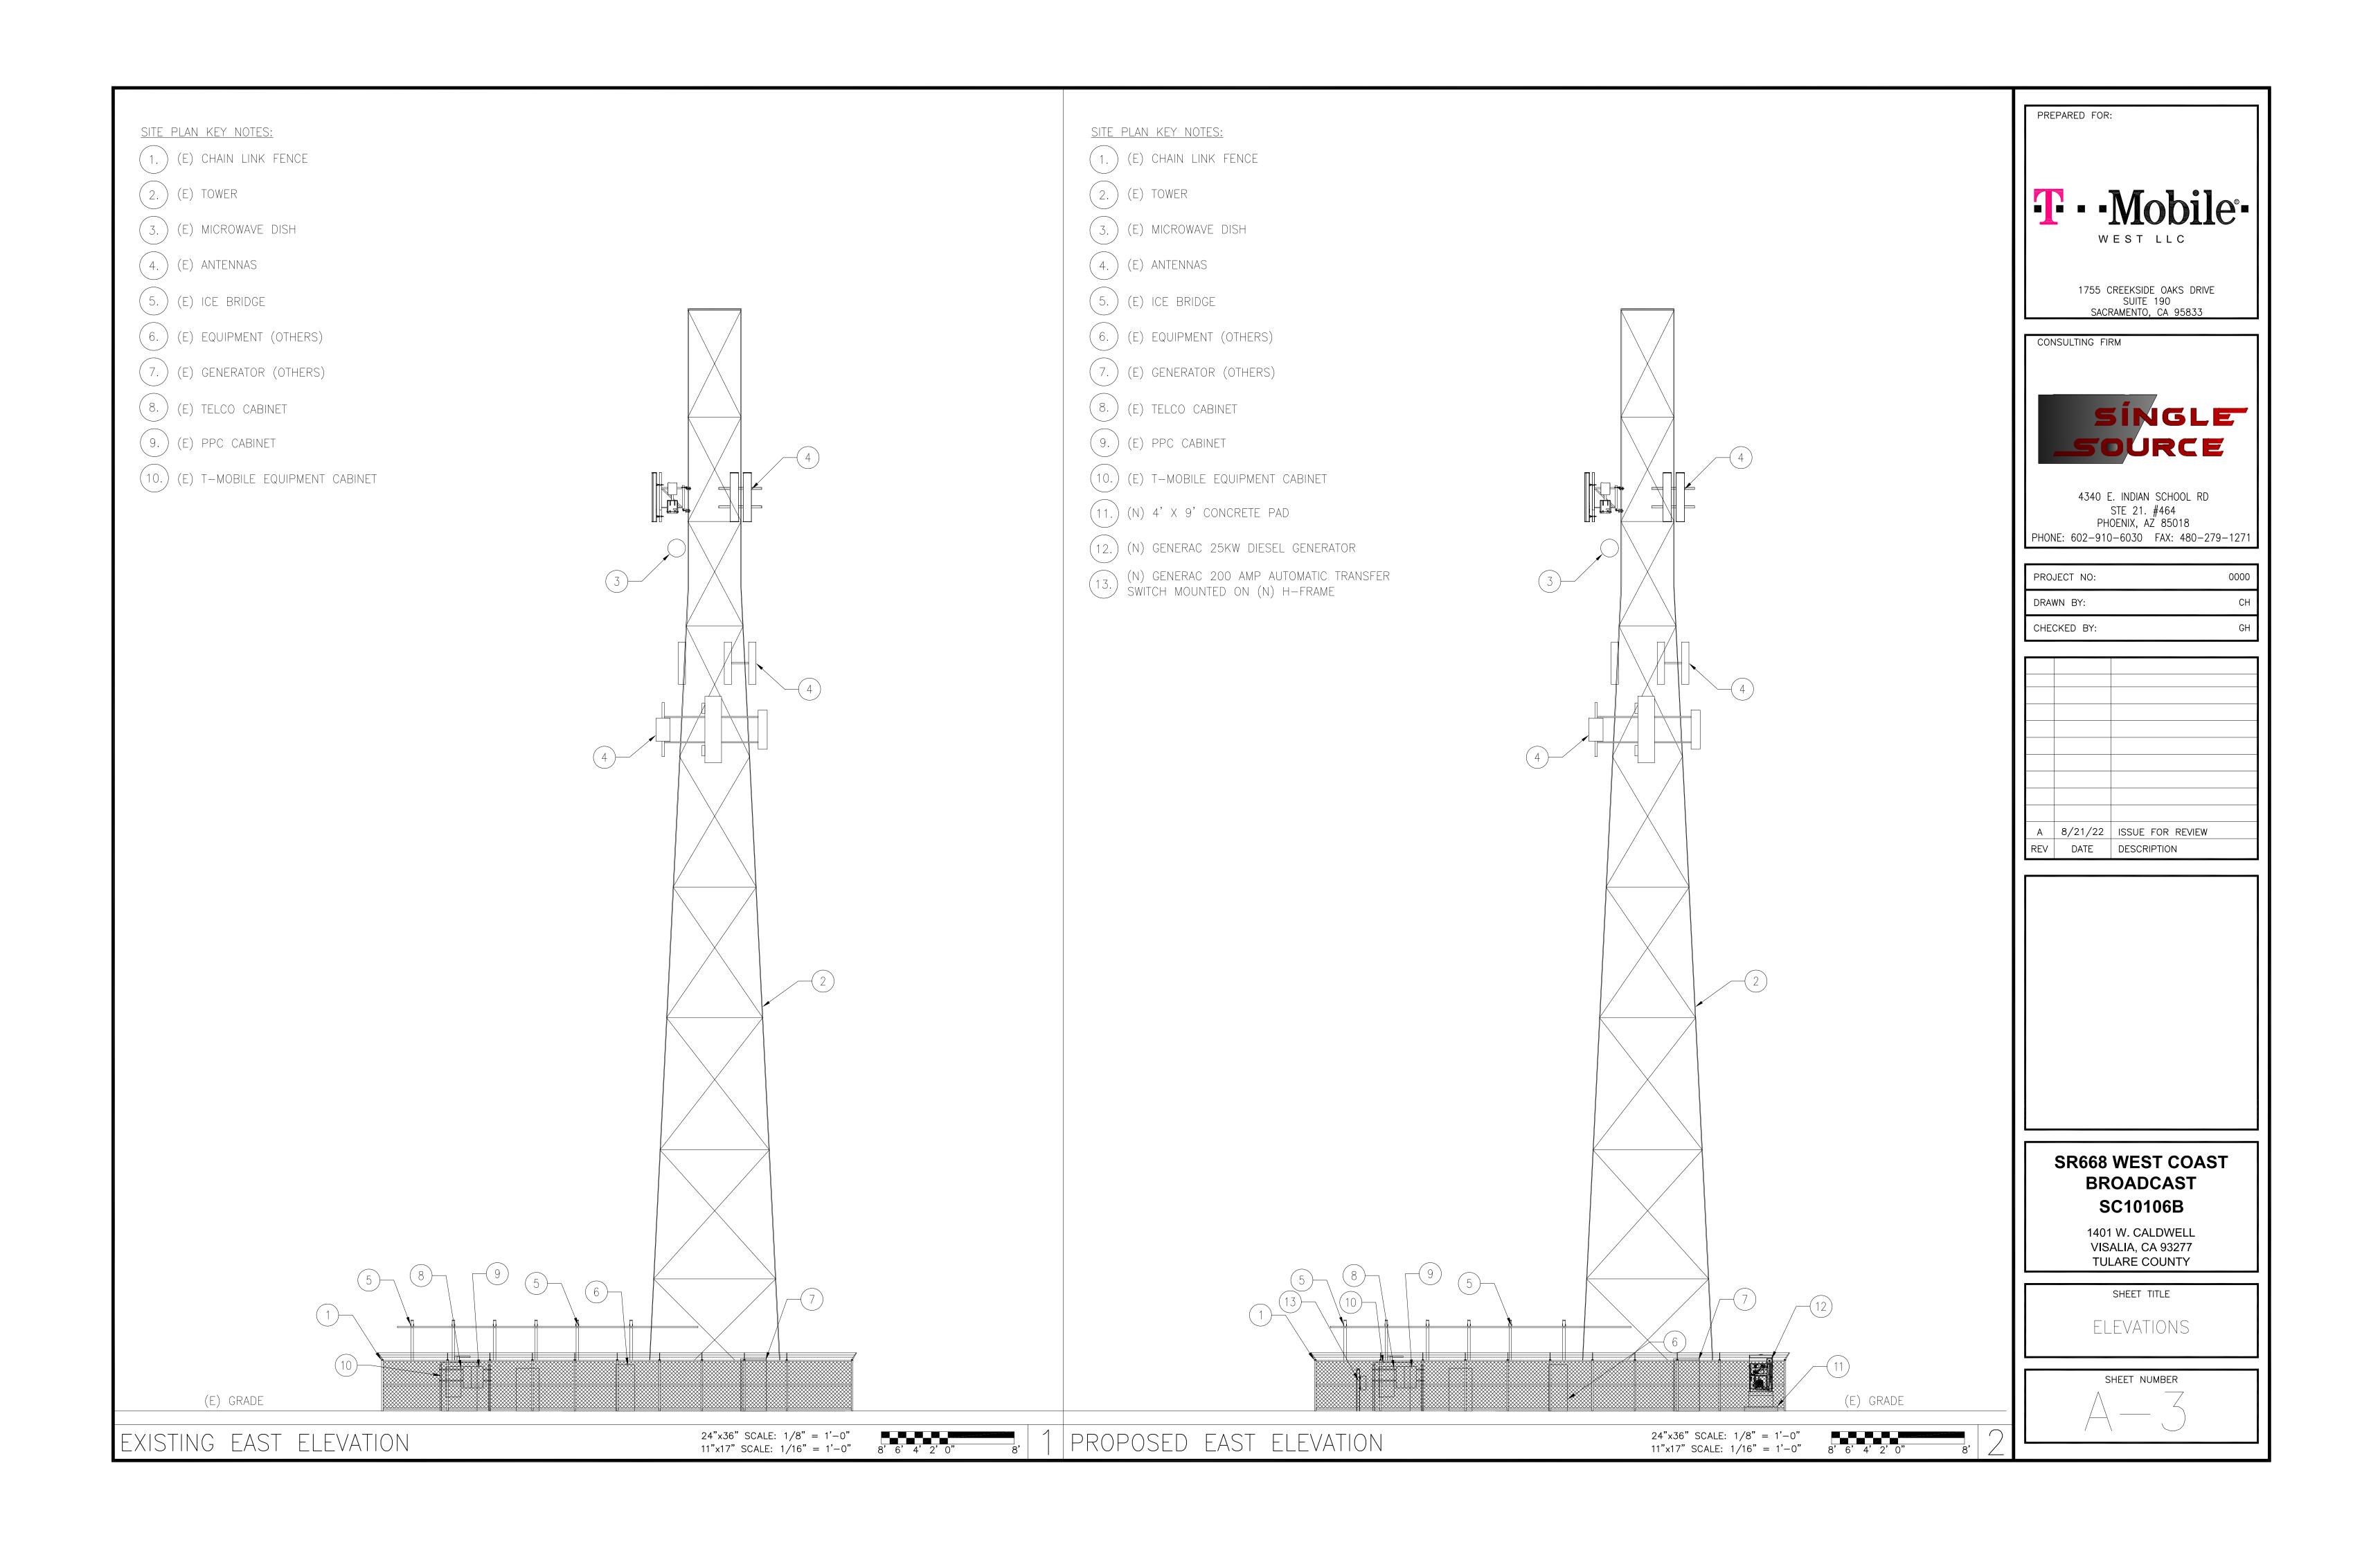



SPECIFICATIONS

MODEL	RXSC200A3
AMPS	200
VOLTAGE	120/240, 1ø
LOAD TRANSITION TYPE (AUTOMATIC)	OPEN TRANSITION
ENCLOSURE TYPE	NEMA/UL 3R
UL RATING	UL/CUL

DIMENSIONS


MODEL		RXSC200A3
HEIGHT (IN./MM)	Н1	17.24/437.9
	H2	20/508
WIDTH (IN./MM)	W 1	12.5/317.5
	W2	14.6/370.8
DEPTH (IN./MM)		7.09/180.1
WEIGHT (LBS./KILOS)		20/9.07

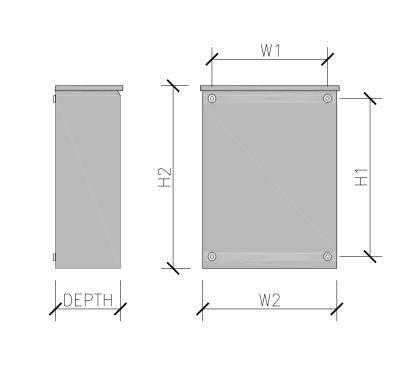

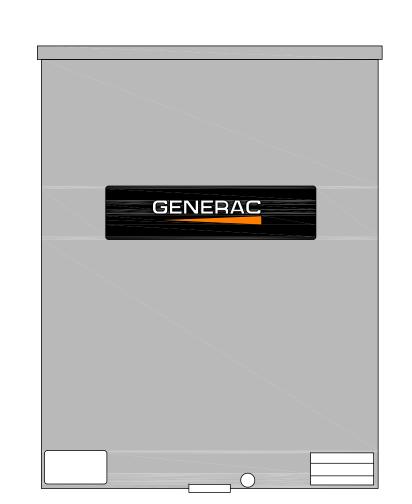

GENERAC 200 AMP AUTOMATIC TRANSFER SWITCH

SCALE: NTS

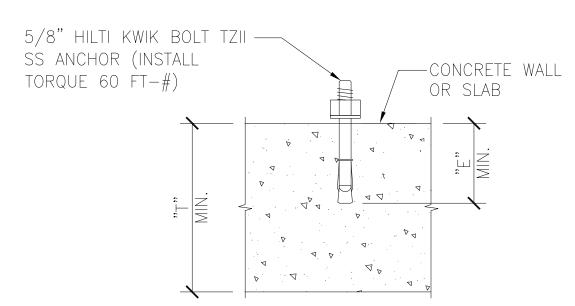



ANCHOR SCHEDULE				
BOLT DIAMETER 5/8"		′8"		
BIT 5/8"		′8"		
"E" MIN. EMBEDMENT DEPTH	3-1/4"	4"		
"T" MIN. THICKNESS	5"	6"	8"	
MIN. EDGE DISTANCE	5-1/4		2-3/8"	
PULLOUT STRENGTH CRACKED CONCRETE	N/A	5,840) LBS	

ANCHOR SCHEDULE NOTE:
INFORMATION SHOWN IN THIS TABLE IS IN
ACCORDANCE WITH: ICC REPORT ESR-4266

NOTES:

- 1. SUBSTITUTION OF A HILTI KWIK BOLT TZII SS ANCHOR WITH OTHER EXPANSION ANCHORS MANUFACTURED BY HILTI OR BY OTHER MANUFACTURERS IS NOT ALLOWED WITHOUT THE WRITTEN APPROVAL OF THIS ENGINEERING PRIOR TO INSTALLATION. THE CONTRACTOR SHALL BEAR THE ENTIRE COST OF REPLACEMENT OF NON-APPROVED ANCHORS
- 2. THE CONTRACTOR SHALL ACCURATELY LOCATE ALL EXISTING REINFORCING BY X-RAY OR EQUIVALENT METHOD. NO REBAR OR TENDONS SHALL BE CUT. ALL EXPENSES RELATED TO REPAIR OF CUT REBAR OR TENDONS SHALL BE ENTIRELY AT THE EXPENSE OF THE CONTRACTOR.
- 3. SPECIAL INSPECTION IS REQUIRED FOR INSTALLATION OF ANCHORS.
- 4. INSTALLATION OF CONCRETE ANCHORS IN MASONRY IS NOT ALLOWED.
- 5. USE STAINLESS STEEL FOR EXPOSED APPLICATIONS.
- 6. NORMAL—WEIGHT AND SAND—WEIGHT CONCRETE MUST CONFORM TO SECTIONS 1903 AND 1905 OF THE IBC.

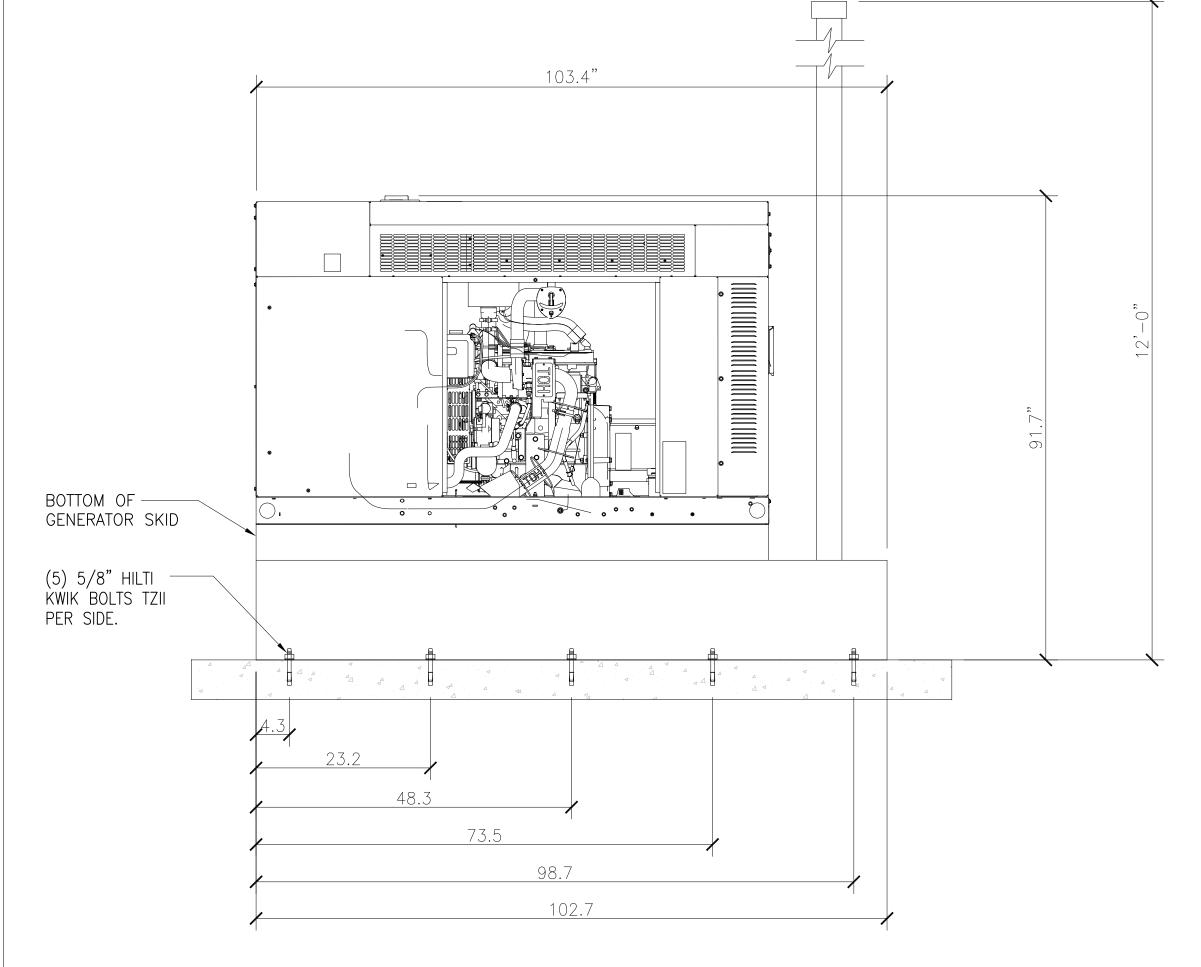

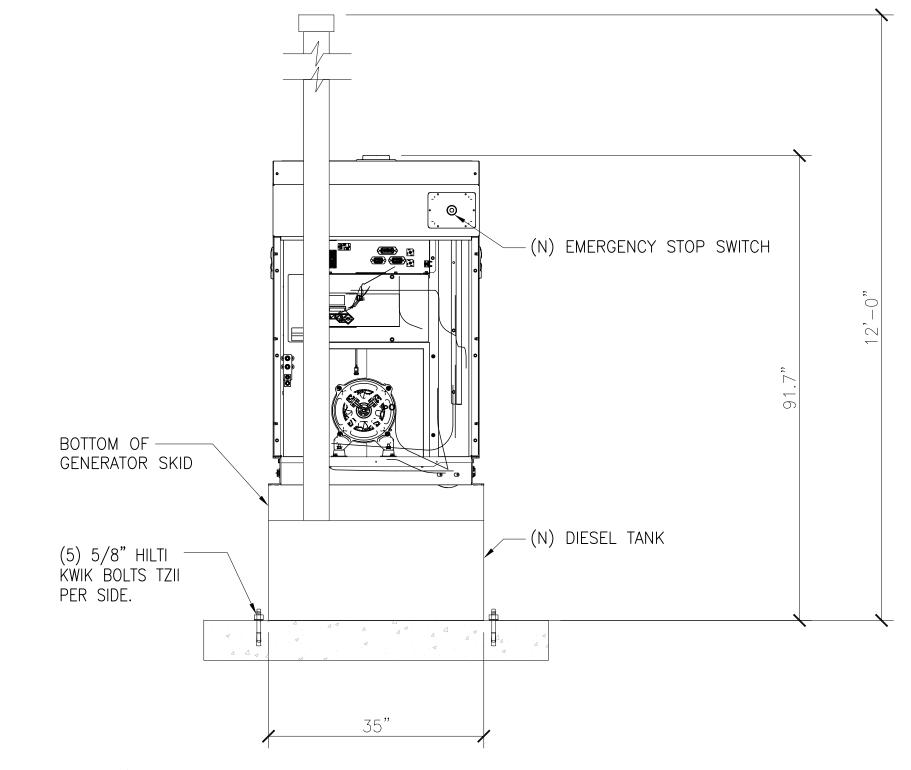

LEVEL 2 SOUND ATTENUATION ENCLOSURE
RUN TIME HOURS: 98

USABLE CAPACITY GAL: 240 L X W X H: 103.4 X 35 X 91.7

WEIGHT lbs (with skid): SOUND LEVEL:

65 dBA

2,161

T - Mobile®
Westllc

1755 Creekside Oaks Drive
Suite 190
SACRAMENTO, CA 95833

CONSULTING FIRM

PREPARED FOR:




4340 E. INDIAN SCHOOL RD STE 21. #464 PHOENIX, AZ 85018 PHONE: 602-910-6030 FAX: 480-279-1271

PROJECT NO: 0000

DRAWN BY: CH

CHECKED BY: GH

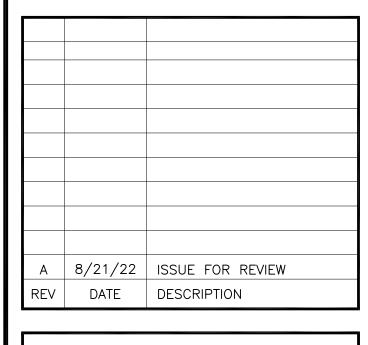

SR668 WEST COAST BROADCAST SC10106B

> 1401 W. CALDWELL VISALIA, CA 93277 TULARE COUNTY

DETAILS


SHEET TITLE

SHEET NUMBER

HILTI KWIK BOLT TZII SS ANCHOR

SCALE: 3 GENERAC 25KW DIESEL GENERATOR

SCALE:

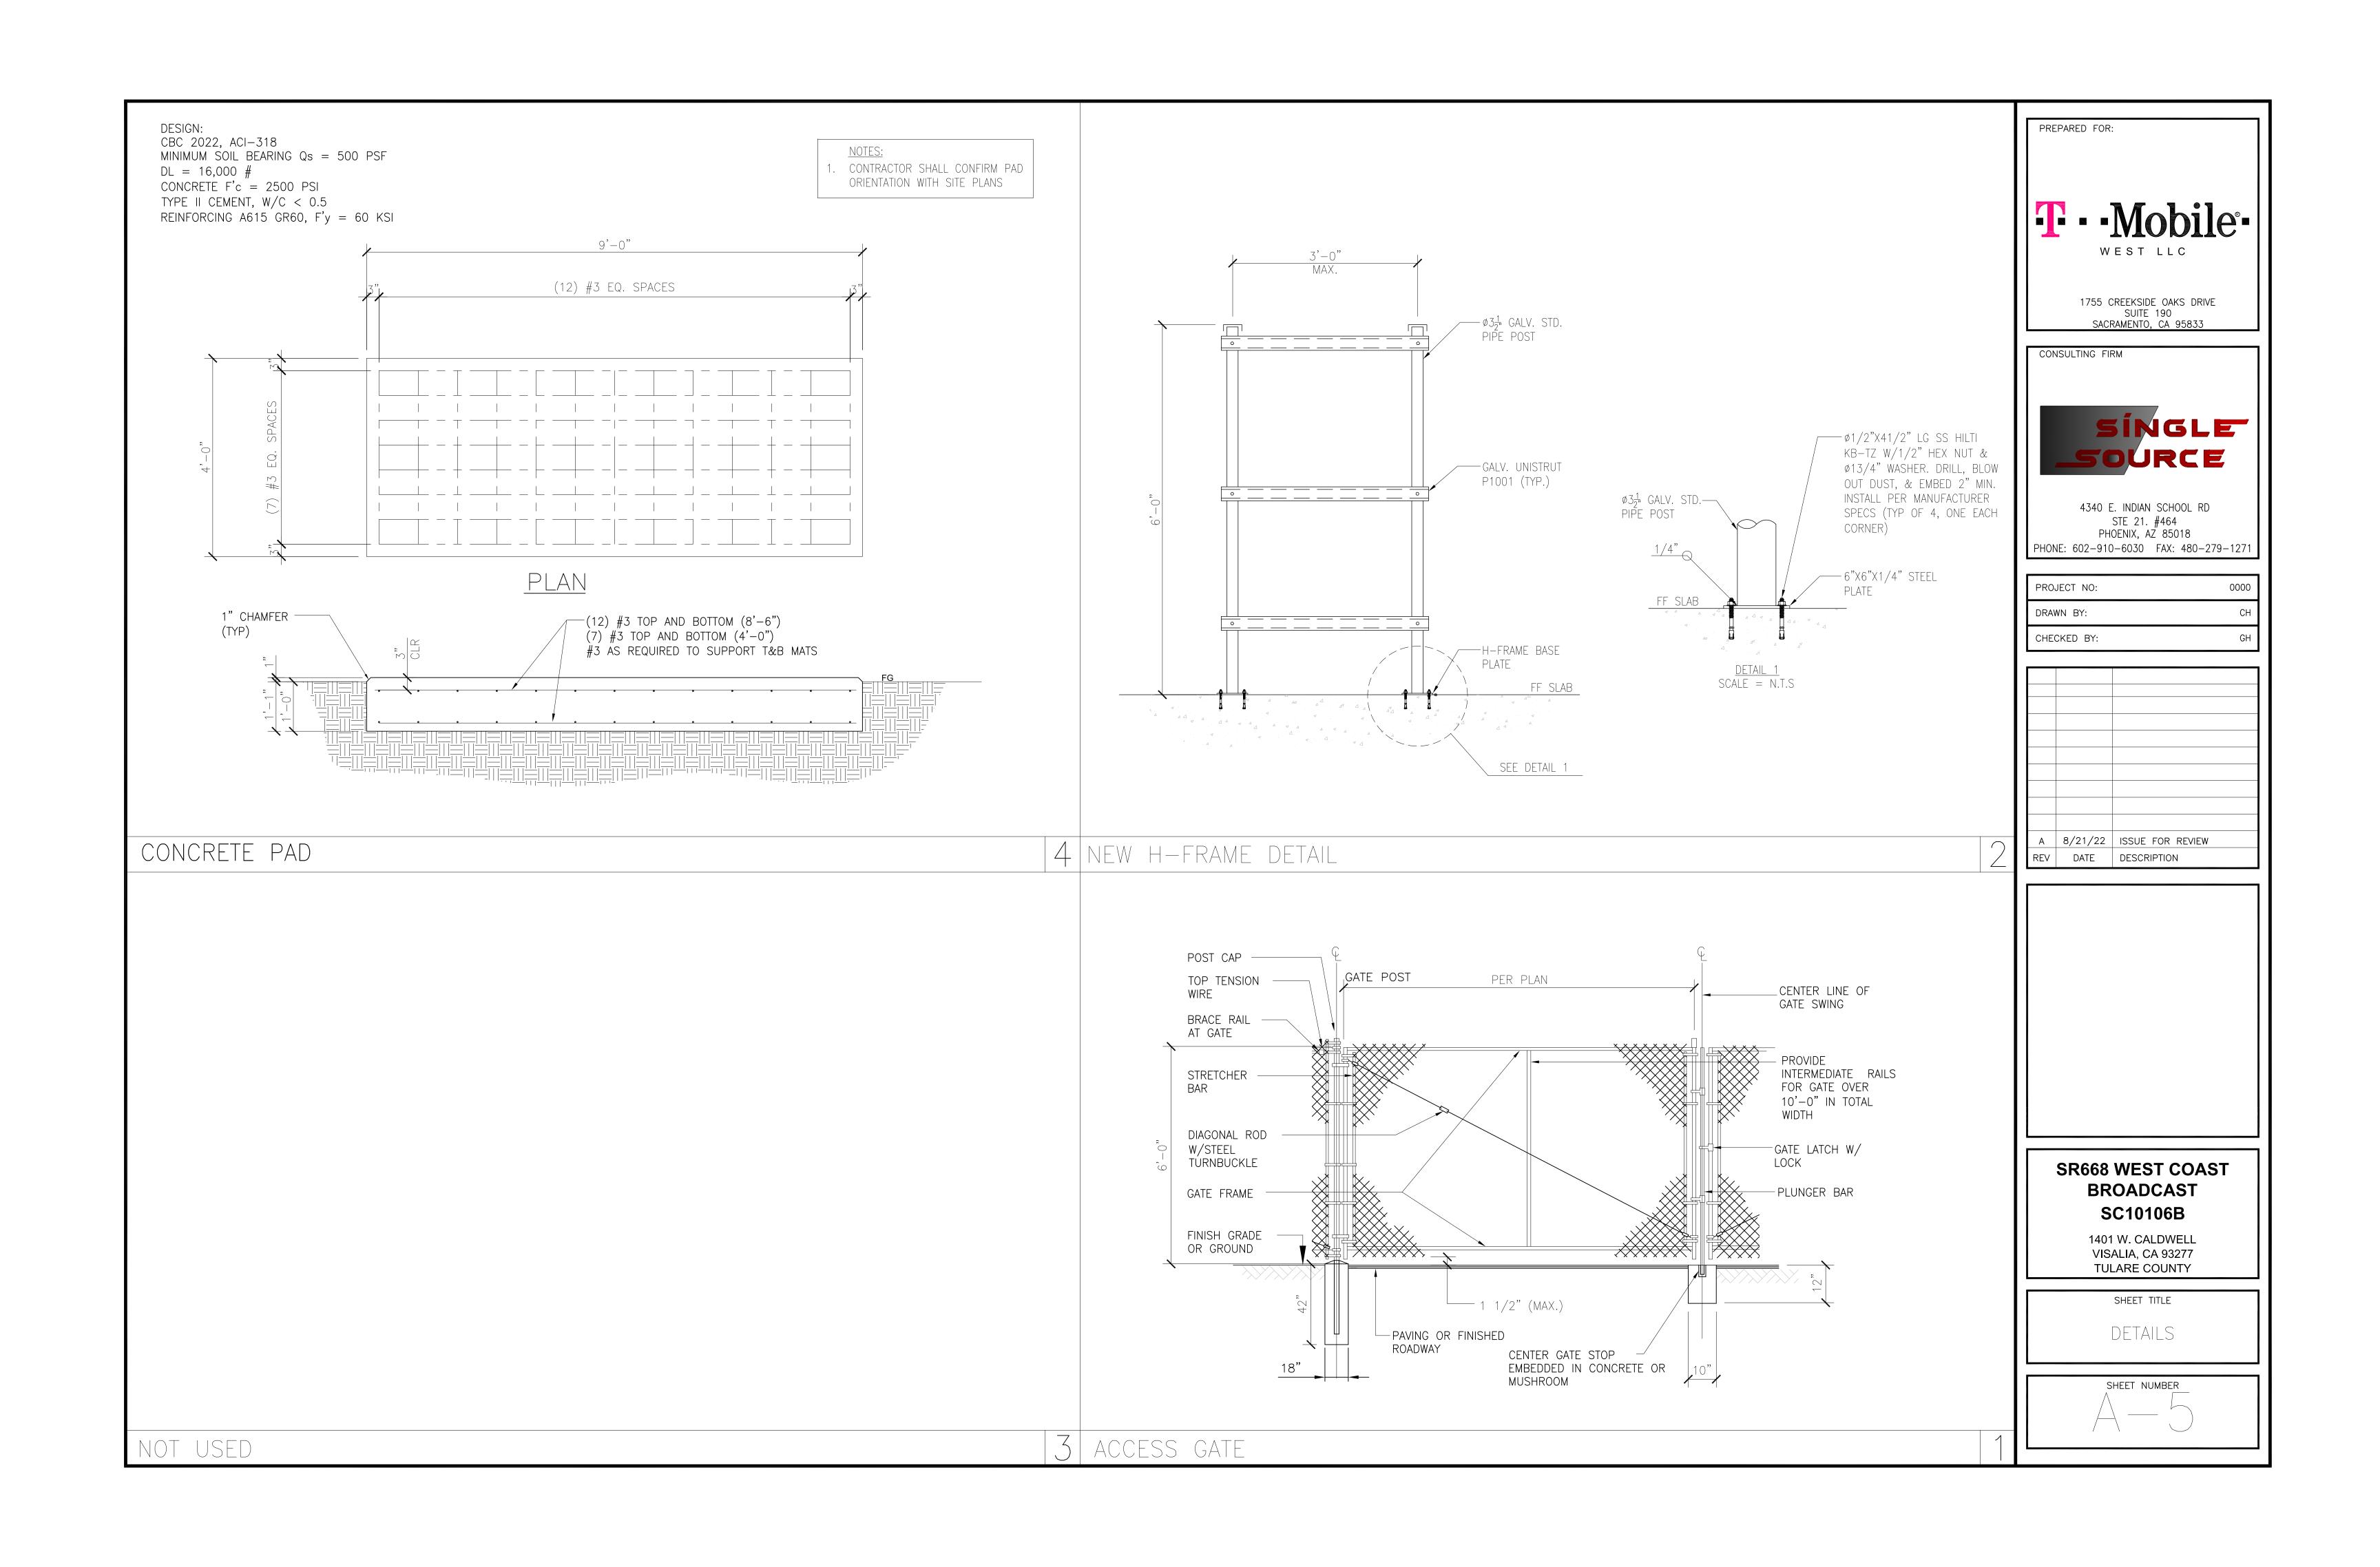

- 1. ALL SIGNS SHALL BE UV-RESISTANT FOR OUTDOOR USE.
- 2. ALL SIGNS SHALL HAVE A MINIMUM 5—YEAR GUARANTEE WITHOUT SHOWING ANY SIGNS OF FADING OR DEGRADATION
- 3. ALL SIGNS SHALL HAVE ROUNDED CORNERS WITH PRE-DRILLED HOLES AND WEATHER PROOF PRESSURE SENSITIVE ADHESIVE BACKING FOR MOUNTING.
- 4. ALL SIGNS SHALL BE PROVIDED PER THEIR SPECIFIC REQUIREMENTS, UNLESS OTHERWISE SPECIFIED DUE TO SIZE RESTRAINTS OR LANDLORD DEMANDS.

GENERAL SIGNAGE NOTES

NO SMOKING OR OPEN FLAMES WITHIN 25 FEET

SIGN REQUIREMENTS:

MATERIAL - 8 1/2"x11" 60MIL THICK WHITE PLASTIC.

COLOR AND LETTERING - PER OSHA 1910.145:

REGULATIONS OF ACCIDENT PREVENTION SIGNS AND TAGS.

MOUNTING — VERIFY MOUNTING LOCATION WITH LOCAL FIRE INSPECTOR

DANGER SIGNAGE


SPECIFICATIONS:

- 1. FONT STYLE USED:

 NUMBERS—HELVETICA BOLD EXTENDED


 LETTERS—HELVETICA BLACK BT
- 2. NUMBERS SHALL BE A MINIMUM OF 3-1/2" HIGH WITH 11/16" STOKE WIDTH
- 3. LETTERING FOR WHITE SPECIAL HAZARD BOX:
 ONE LINE: 1-3/4" HIGH WITH 9/16" STROKE WIDTH
 TWO LINES: 1-3/8" HIGH WITH 7/16" STROKE WIDTH
 THREE LINES: 1-1/4" HIGH WITH 3/8" STROKE WIDTH
- 4. NUMBERS AND LETTERS ARRANGED BY COLOR AS SHOWN ABOVE.
- 5. SIGN SHALL BE POSTED AT LOCATION APPROVED BY THE CITY'S FIRE DEPARTMENT

TANK SIGNAGE SPECIFICATIONS

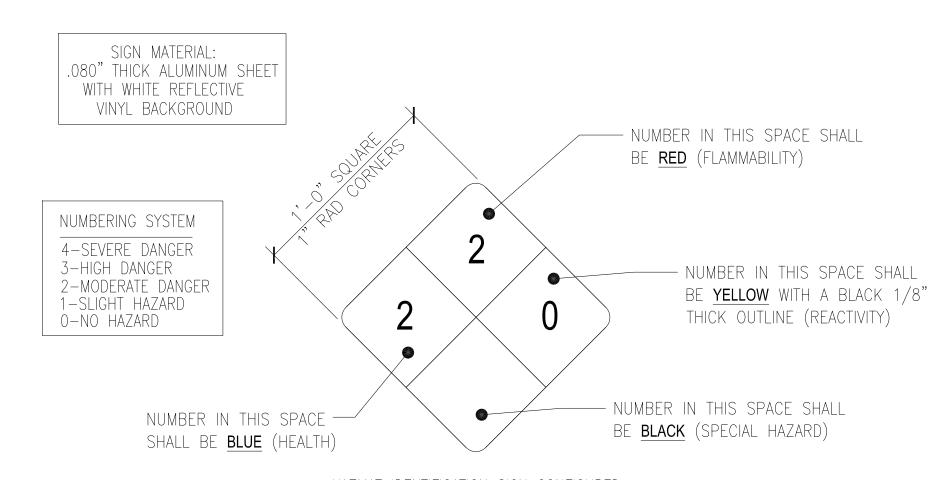

HAZMAT IDENTIFICATION SIGN CONFIGURED
FOR FUEL OIL #1 (GAS 068334-30-5)
(TYPICAL FOR DIESEL GENERATORS)
CONTRACTOR TO PROVIDE SIGN PER T-MOBILE STANDARDS

TANK SIGNAGE

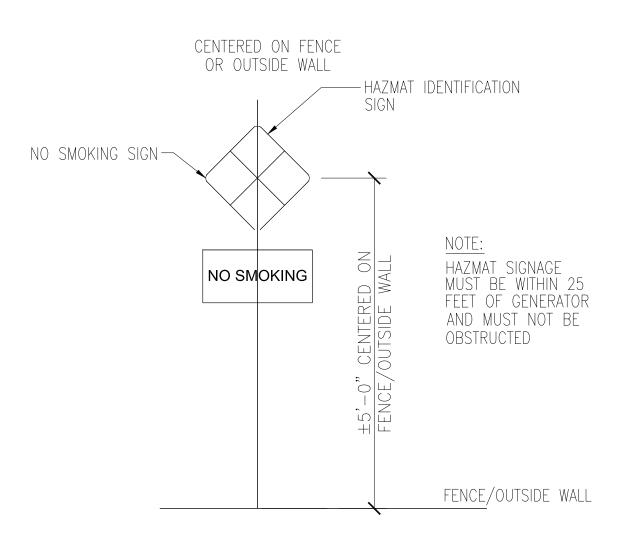

<u>HAZMAT SIGNAGE</u>

PREPARED FOR:

The Modile we still c

1755 CREEKSIDE OAKS DRIVE SUITE 190 SACRAMENTO, CA 95833

SÍNGLE SOURCE


CONSULTING FIRM

4340 E. INDIAN SCHOOL RD
STE 21. #464
PHOENIX, AZ 85018
PHONE: 602-910-6030 FAX: 480-279-1271

PROJECT NO: 0000

DRAWN BY: CH

CHECKED BY: GH

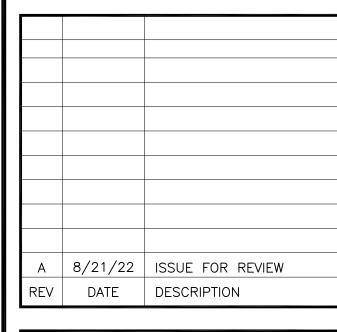


SR668 WEST COAST BROADCAST SC10106B


1401 W. CALDWELL VISALIA, CA 93277 TULARE COUNTY

> GENERATOR SIGNAGE


SHEET TITLE

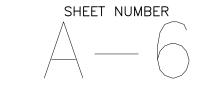



GENERATOR SIGNAGE

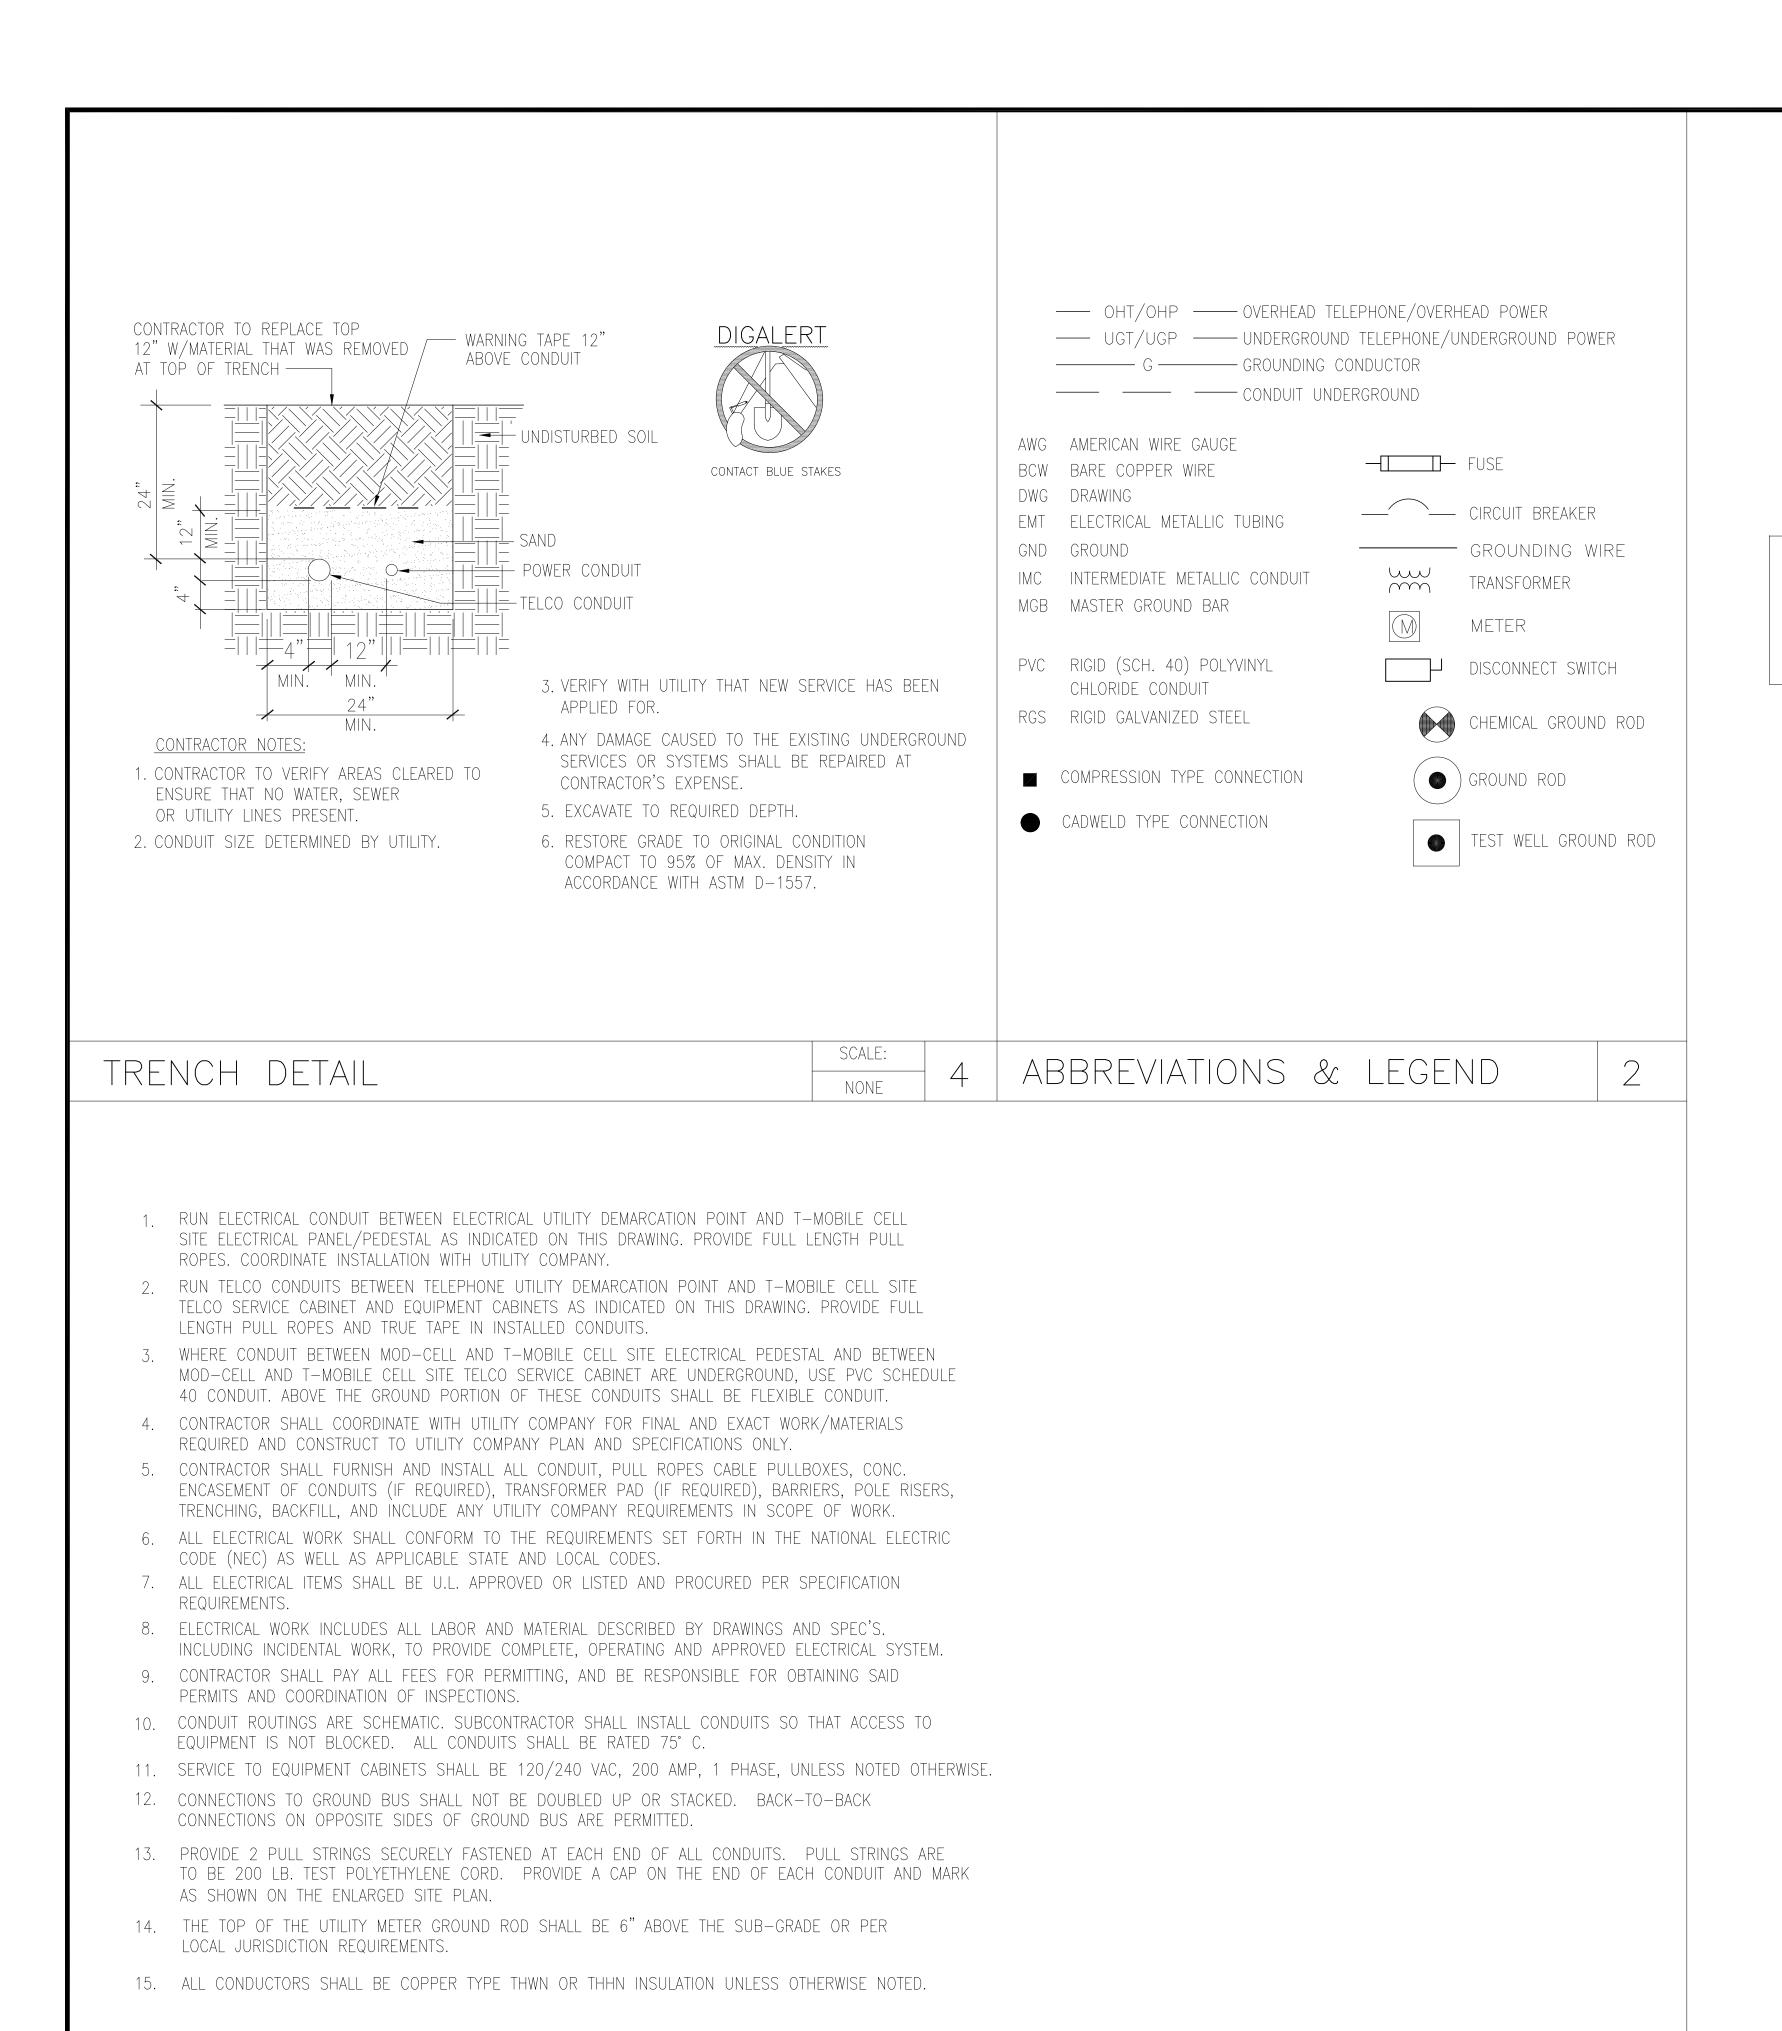

NOTE:
GC TO VERIFY STUB UP LOCATIONS
WITH GENERATOR SPECS. IF USING
EXISTING SLAB GC TO LB INTO
GENERATOR FOR ALL WIRING
CONNECTIONS.

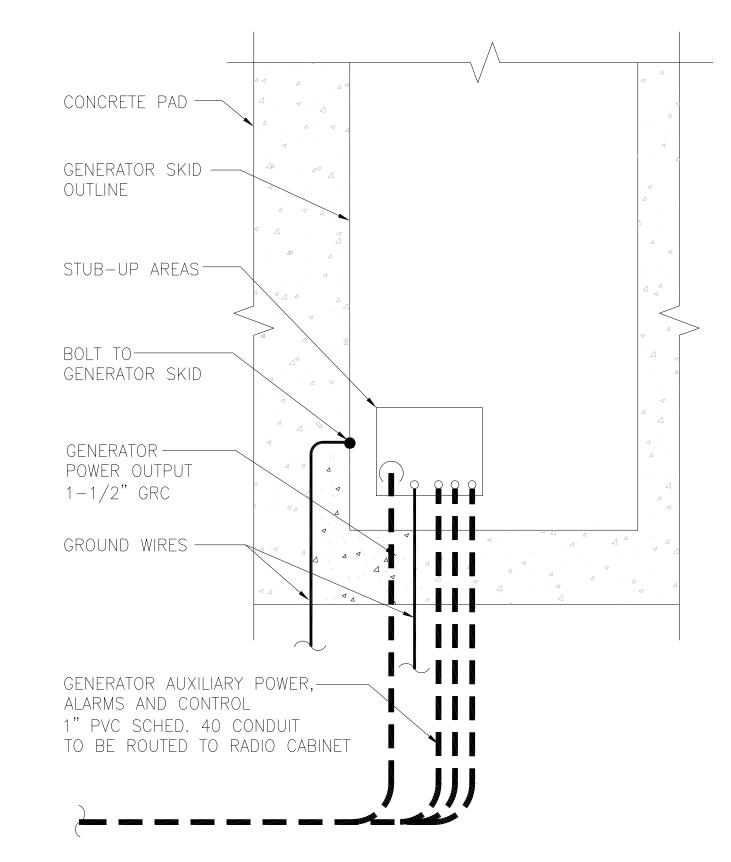

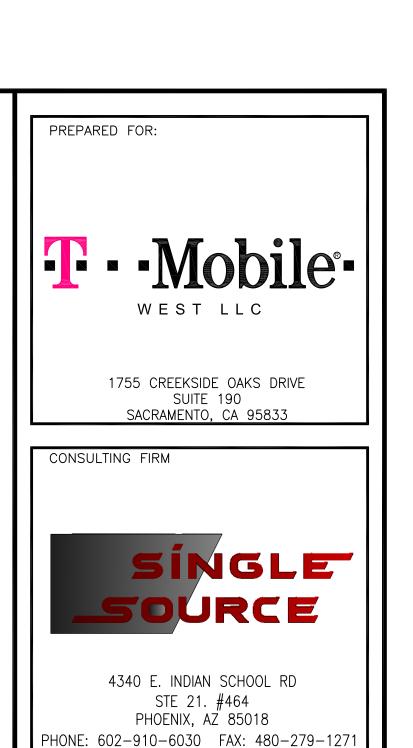

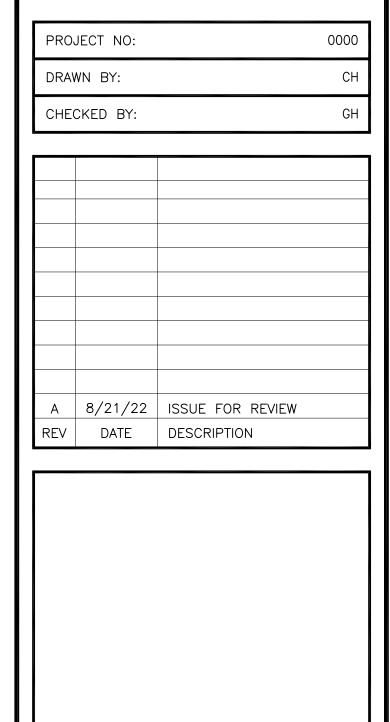

SR668 WEST COAST BROADCAST SC10106B

1401 W. CALDWELL VISALIA, CA 93277 TULARE COUNTY

SHEET TITLE

ELECTRICAL


DETAILS

SHEET NUMBER


CONDUIT ENTRY FOR GENERATOR INSTALLATIONS


NOTES:

- 1. SUBCONTRACTOR SHALL FIELD VERIFY, WITHIN THE SCOPE OF WORK, THAT ALL EXISTING CONDUITS, CONDUCTORS, CONDUIT STUB-UPS, AND ELECTRICAL EQUIPMENT/RATINGS ARE INSTALLED PER NEC AND LOCAL AUTHORITIES HAVING JURISDICTION.
- 2. FOR COMPLETE INTERNAL WIRING AND ARRANGEMENT REFER TO DRAWINGS PROVIDED BY EQUIPMENT MANUFACTURERS.
- 3. PROVIDE SIGNS AT SERVICE ENTRANCE EQUIPMENT AS REQUIRED BY NEC ARTICLE 702.8 INDICATING SITE HAS ON-SITE AUTOMATIC START STANDBY GENERATOR.
- 4. THIS SITE IS NOT REQUIRED BY A DETERMINING AGENCY TO BE A LEGALLY REQUIRED SYSTEM.
- 5. THE PROPOSED STANDBY GENERATOR IS <u>NOT</u> A SEPARATELY—DERIVED POWER SYSTEM.
- 6. THE GENERATOR SIZE HAS BEEN SPECIFIED BY THE CLIENT. THE CLIENT SHALL BE SOLELY RESPONSIBLE FOR ASSURING THAT THE LOAD APPLIED TO THE GENERATOR IS WITHIN THE GENERATOR'S RATING.
- 7. THE CONTRACTOR SHALL VERIFY THE AVAILABLE FAULT CURRENT WITH THE SERVING UTILITY AND SHALL USE THAT DATA TO CALCULATE THE AVAILABLE FAULT CURRENT AT THE AUTOMATIC TRANSFER SWITCH. THE AUTOMATING TRANSFER SWITCH SHALL BE SUITABLE FOR USE AT THE CALCULATED FAULT CURRENT.

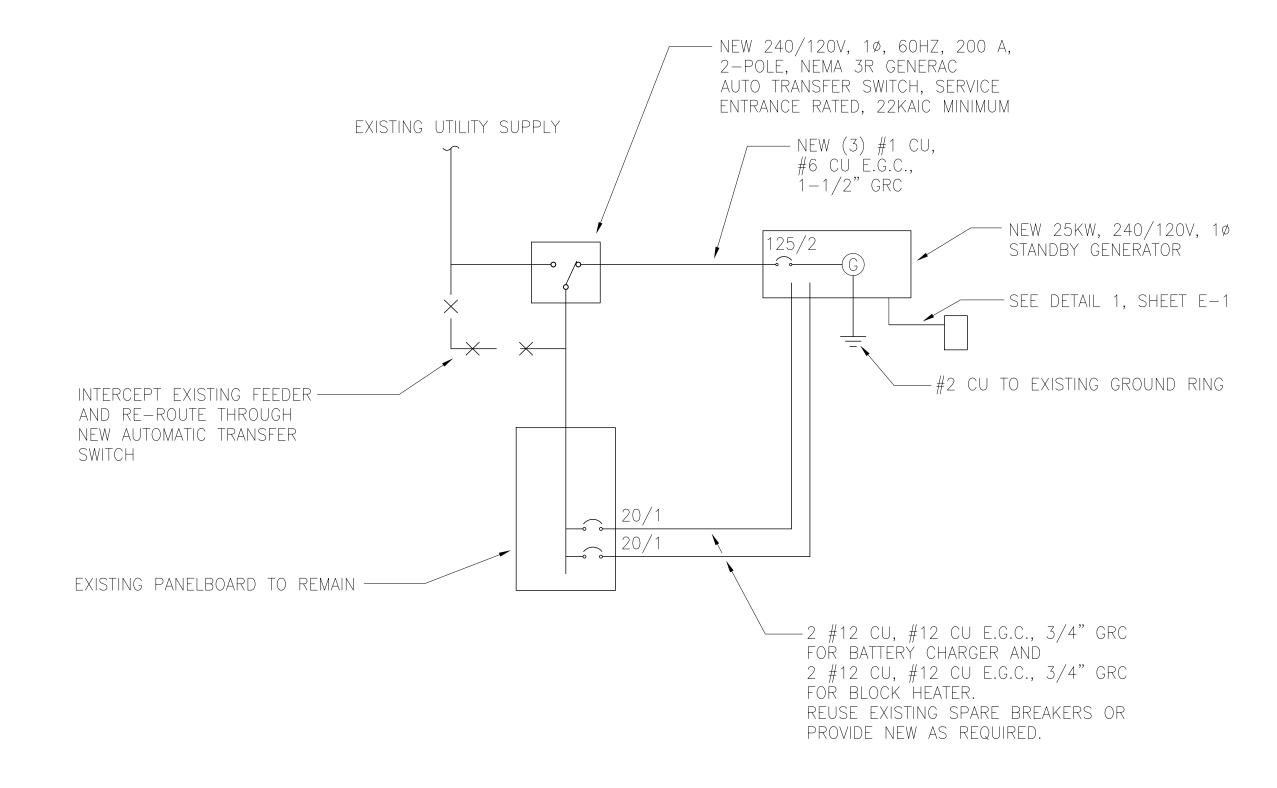

STANDBY GENERATOR SINGLE-LINE DIAGRAM

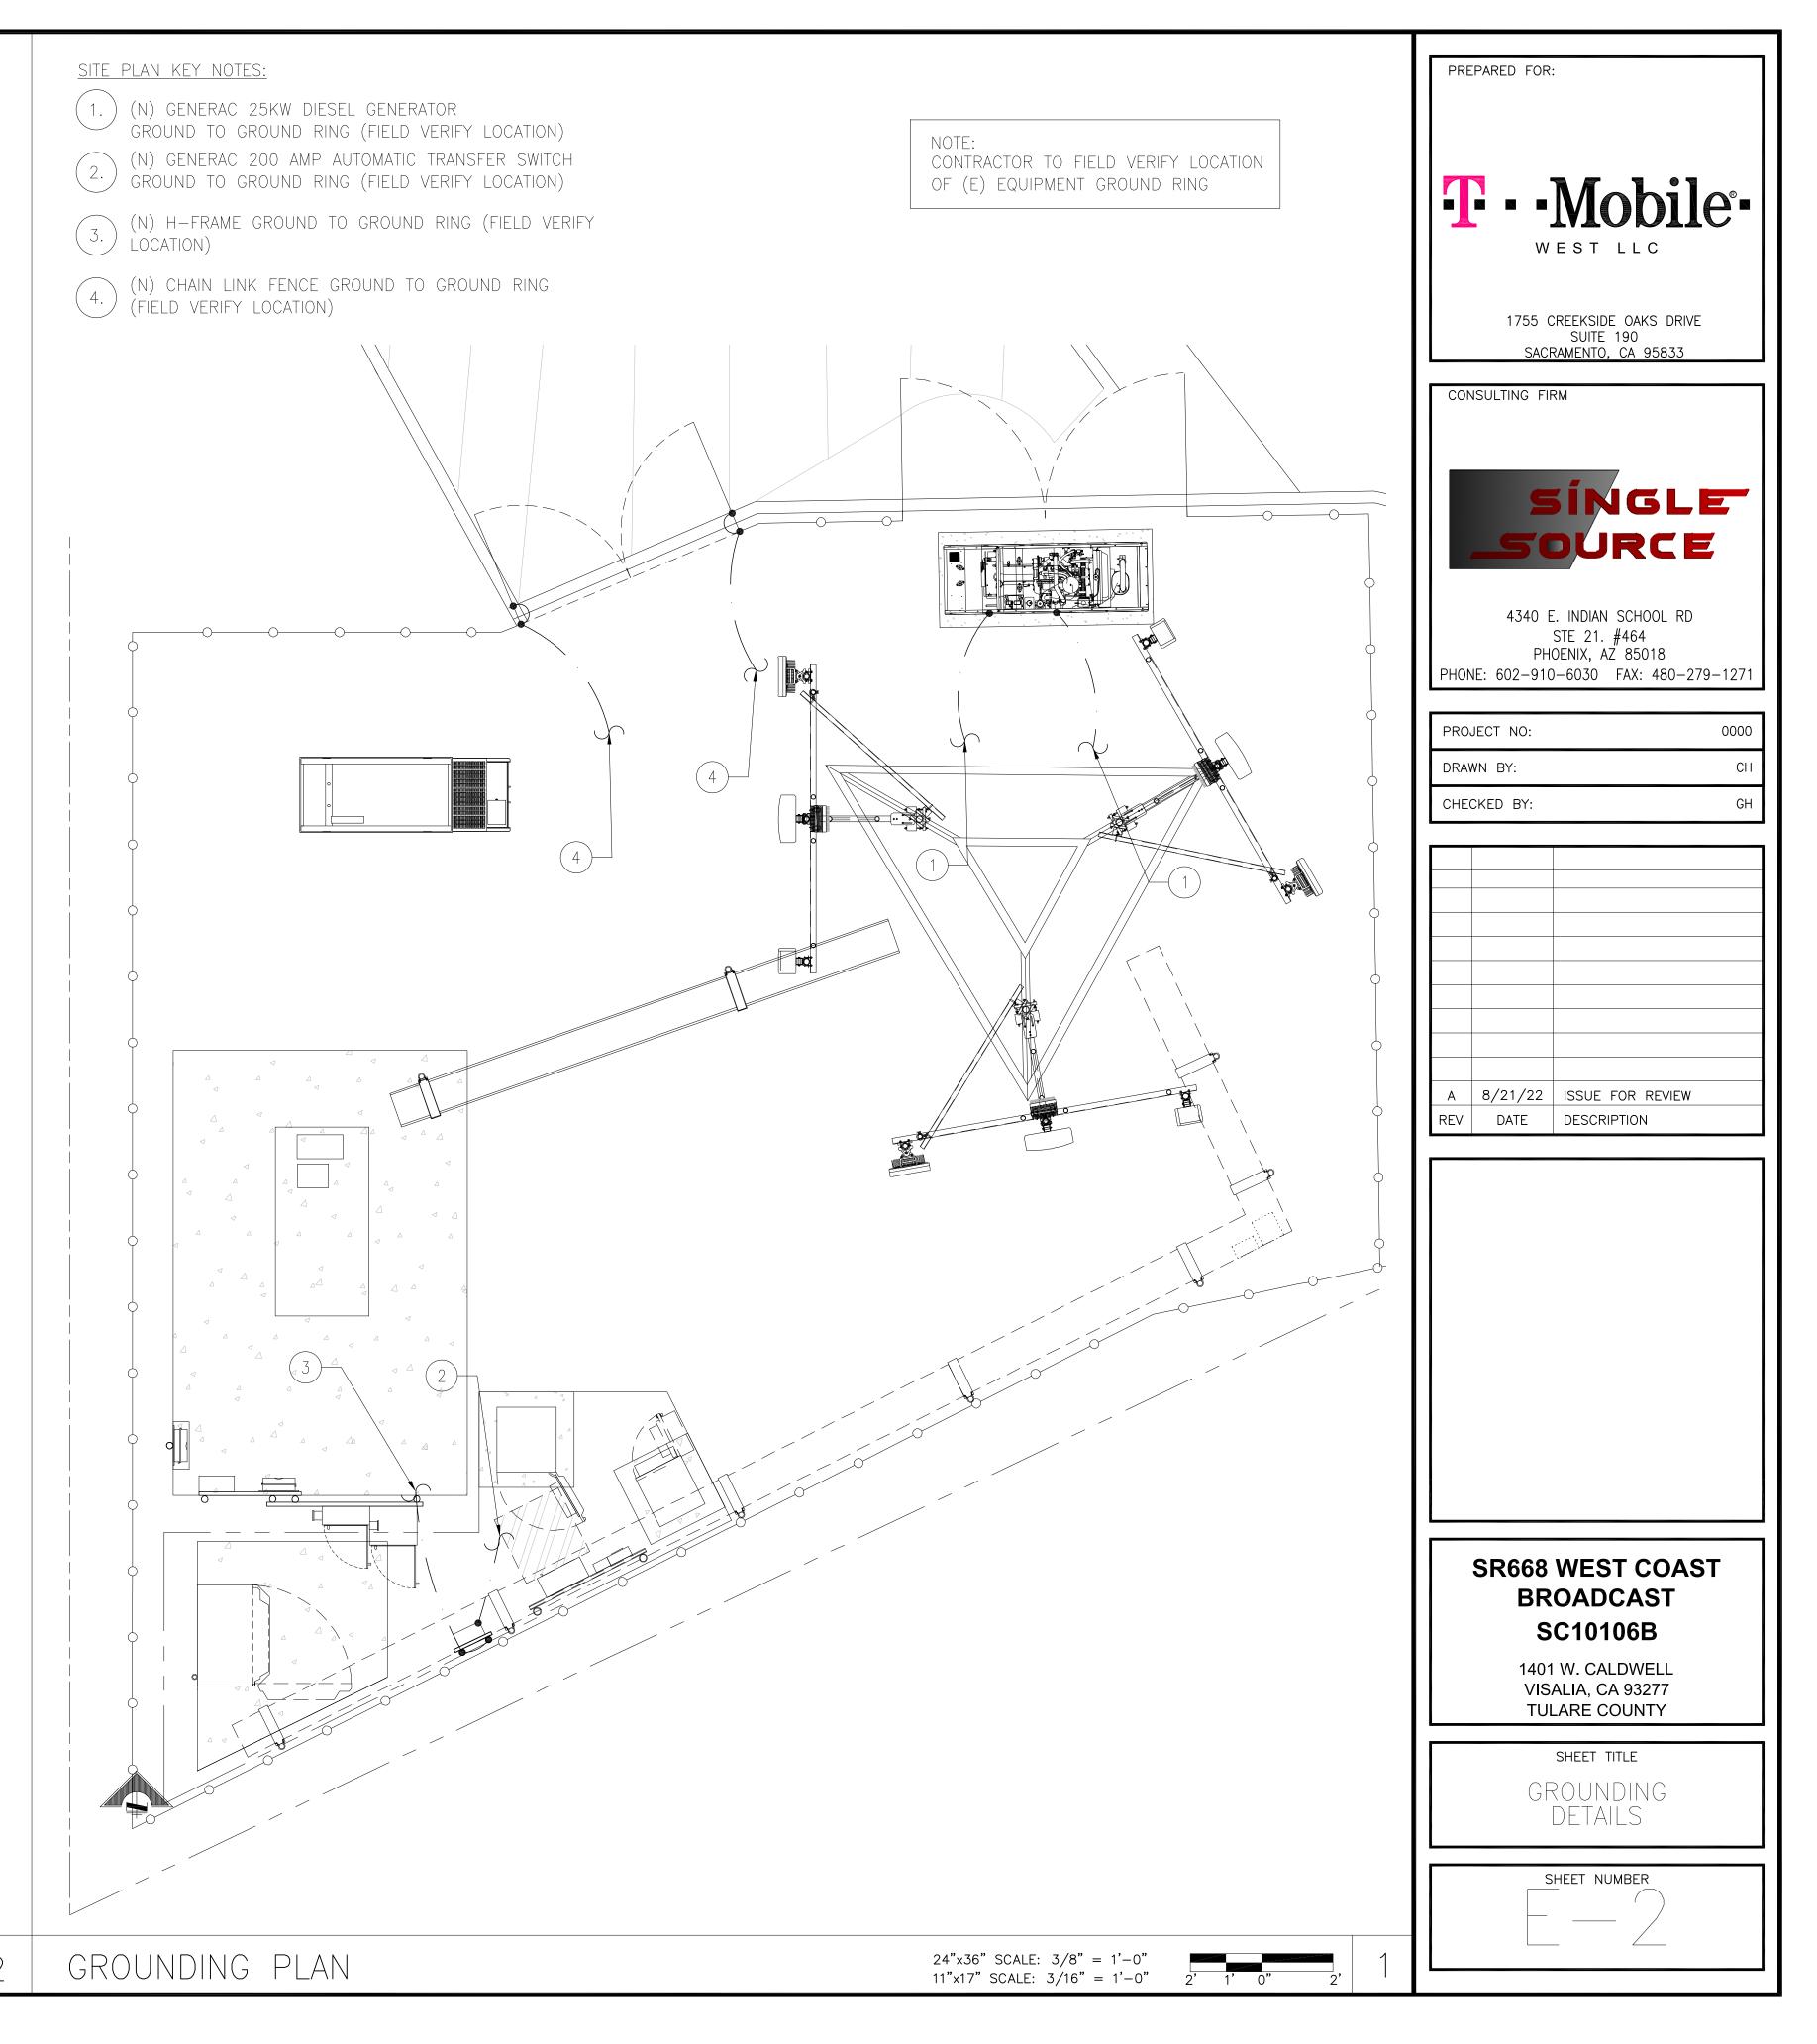

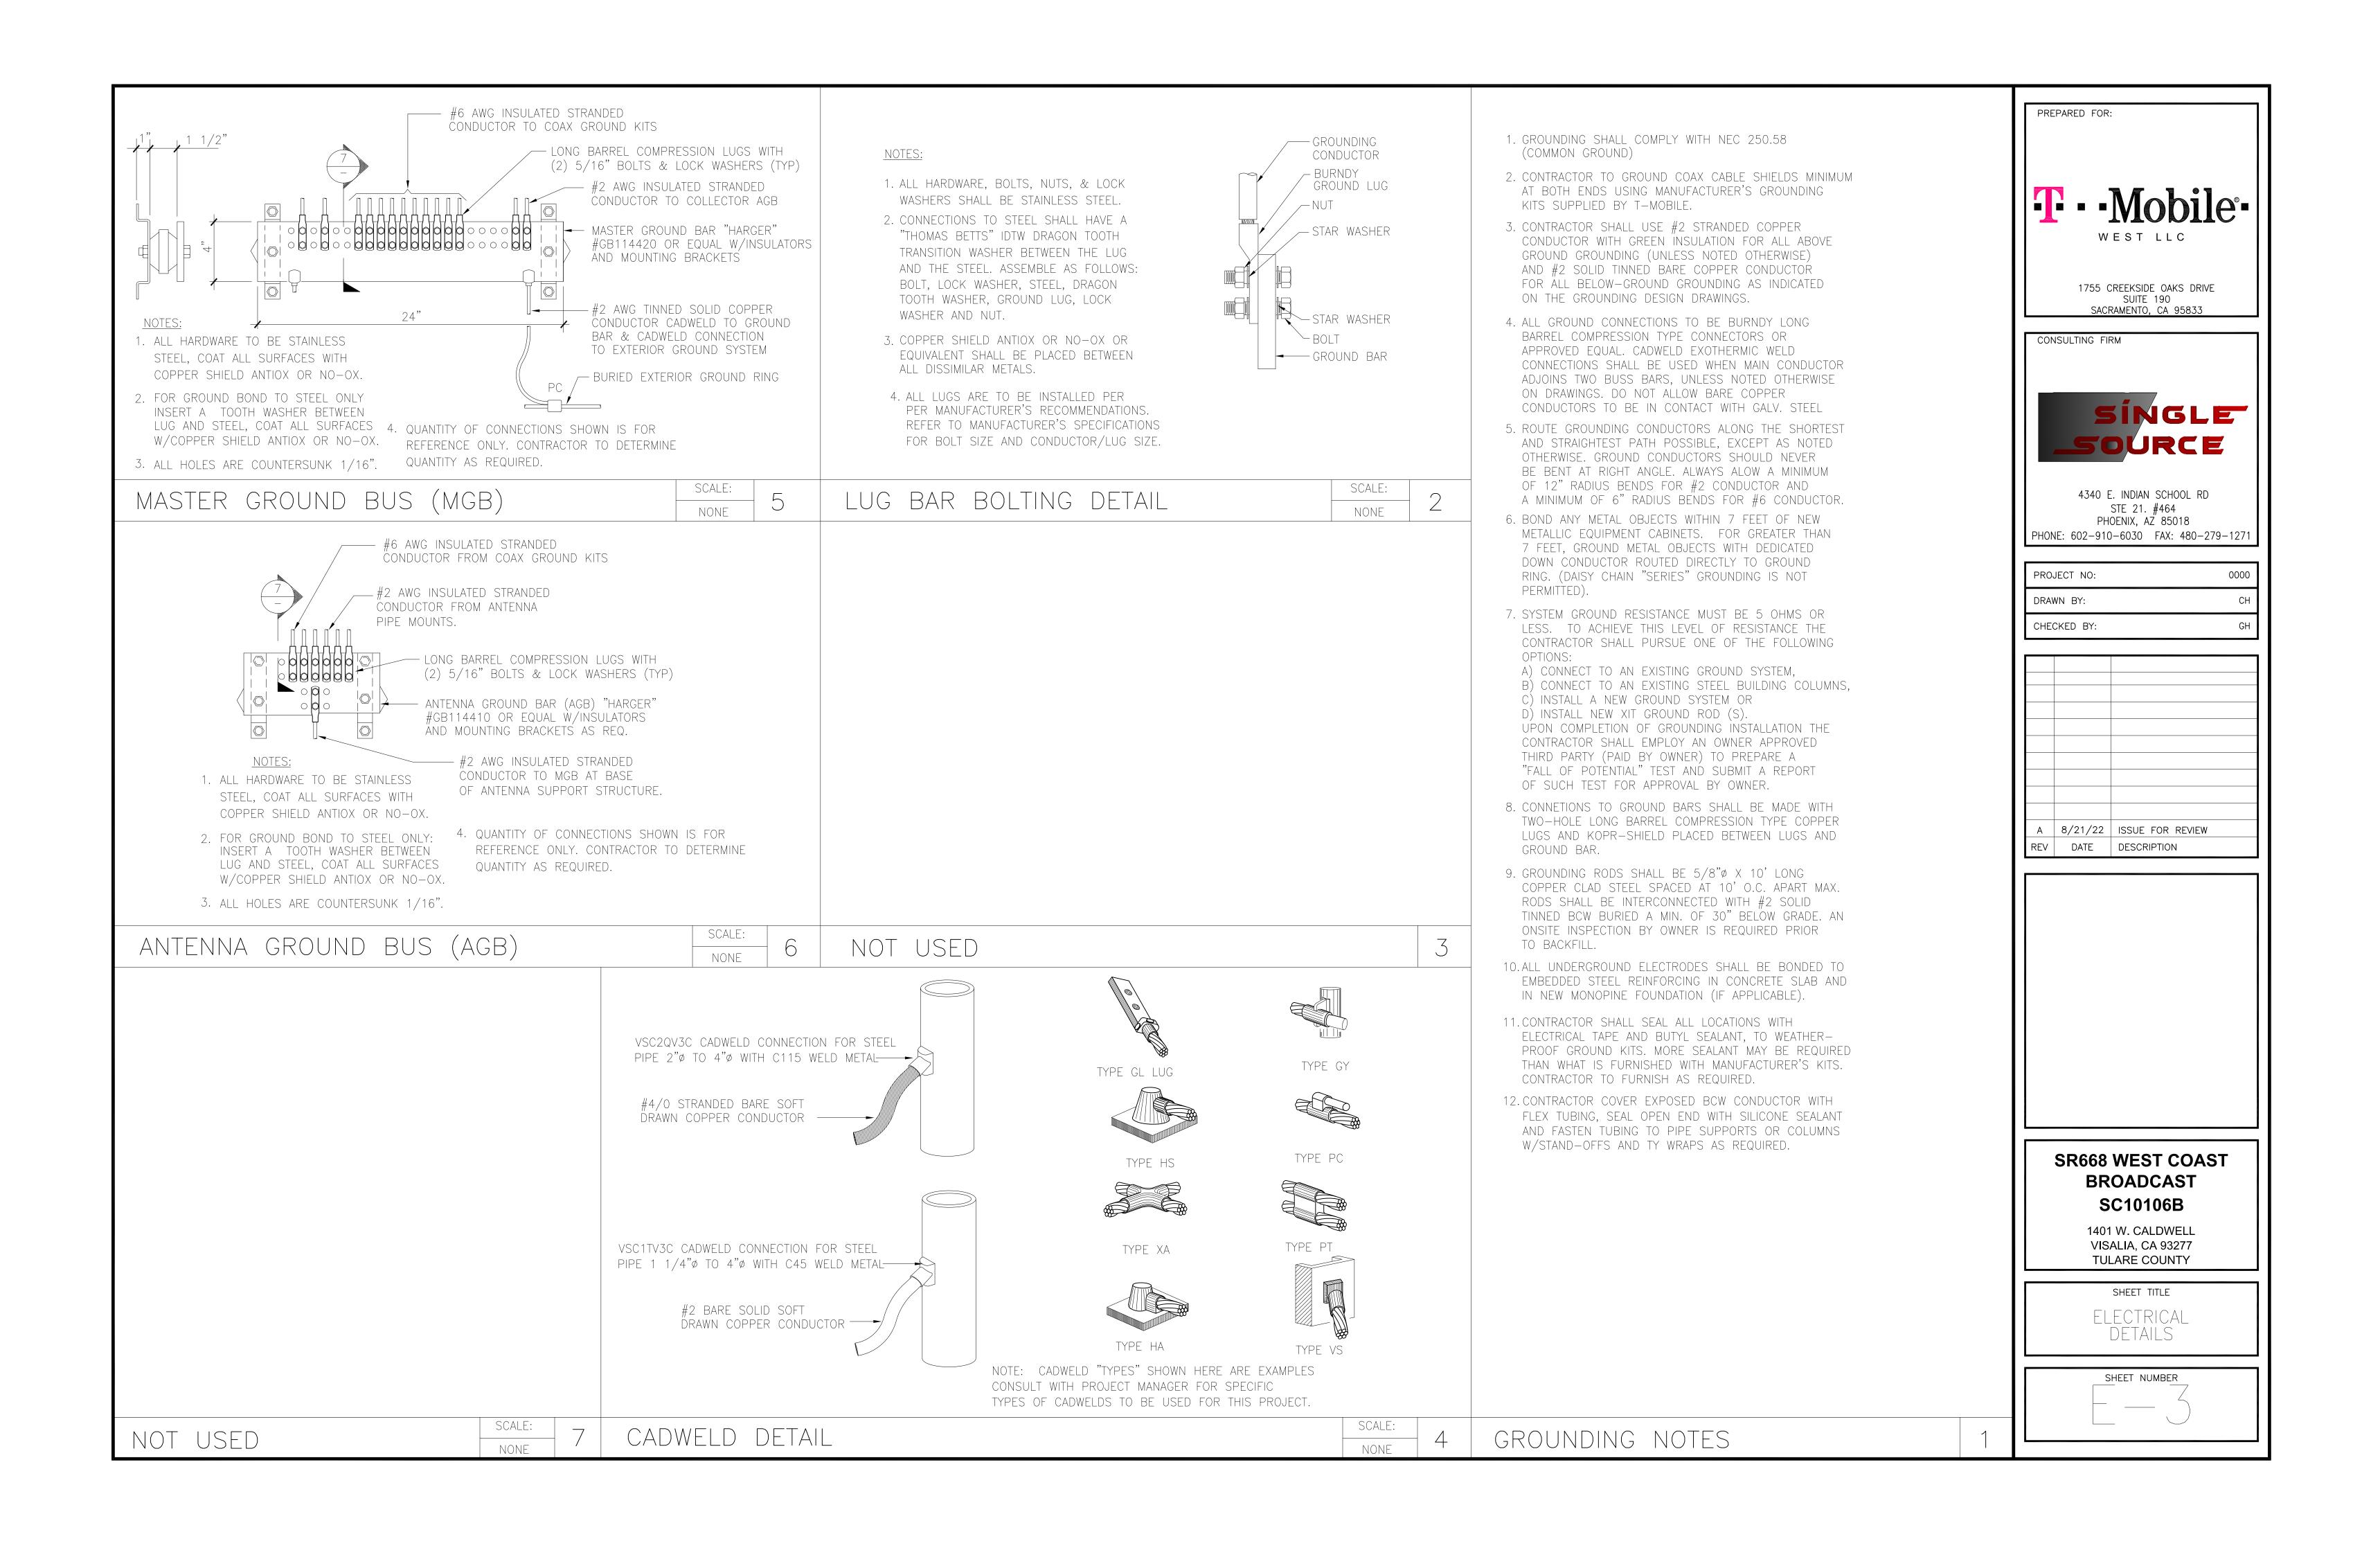

Additional information and assistance in filling out this application can be found at the City of Visalia website (www.visalia.city) or by calling (559) 713-4440.



This application MUST be filled out in its entirety and submitted with an acceptable site plan (see site plan minimum requirements & submittal details on Page 2). Failure to provide all requested information may result in rejection of your application and exclusion from the Site Plan Review agenda.

Site Plan Review meetings are held on Wednesdays at 9:00 a.m. online utilizing Microsoft Teams. The applicant or representative must be present.

	Application submittal deadline are Thursday at 4:00 p.m. to be scheduled	for the next available meeting.	
	Project/Business Name: 1744 S. MUNEY BUD	Date: 2-8-23	
NOIL	Project Description: INSTAN GATE AT FRONT OF R	ANKING LOT TO BE CLOSED	
	APTER BUSINESS HOURS. RELOCATE TRASH ENCLOSURE FROM PEAR OF BUILDIN		
RMA	Site Plan Review Resubmittal: Yes No Site Plan Review Resubmittal, Previous Site		
GENERAL PROJECT INFORMATION	Property Owner: LOREVAL, LLC		
JEC	Applicant(s) Name: Jim Robinson		
L PRC	Project Address/Location: 1744 S. MOONEN BUD		
IERA	Assessor Parcel Number: 0 9 6 3 0 4 XXXXXX 016		
GEN	Parcel Size (Acreage or Square Feet): 18,600 5.F. Building or Suite Square Footage:		
	Are There Any Proposed Building Modifications: Yes No	THIS AREA FOR CITY STAFF USE ONLY	
	Estimated Cost of Modifications to Building: \$ 5000	Date Received: 02/08/2023	
	Describe All Proposed Building Modifications: ADD GASE AND	SPR Agenda: 02/15/2023 Item No	
	VELOCATE TRASH ENCLOSURE	Zone: C-MU SPR No. 23-022	
		Historic District: Yes No	
		Flood Zone: X 🛇 AE 🔾 X/AE 🔾	
	A SEPARATE, DETAILED OPERATIONAL STATEMENT IS HIGHLY RECO	MMENDED FOR ALL CURMITTALS	
	A SET ARATE, DETAILED OPERATIONAL STATEMENT IS HIGHET RECO	MIMENDED FOR ALL SUBMITTALS	
3	Existing/Prior Building Use: POTAIL / OFFICE	IMMENDED FOR ALL SUBMITTALS	
1	Q = 1	IMMENDED FOR ALL SUBMITTALS	
	Existing/Prior Building Use: POTAIL OFFICE	IMMENDED FOR ALL SUBMITTALS	
TION	Existing/Prior Building Use: Proposed Building Use: Proposed Building Use: Proposed Building Use:	IMMENDED FOR ALL SUBMITTALS	
RMATION	Existing/Prior Building Use: Proposed Building Use: Proposed Hours of Operation: Proposed Hours of Operation: Proposed Hours of Operation:	6	
INFORMATION	Existing/Prior Building Use: Proposed Building Use: Proposed Hours of Operation: Days of Week In Operation (Circle): Proposed Hours of Operation (Circle):	sed 8	
AFFIC INFORMATION	Existing/Prior Building Use: Proposed Building Use: Proposed Hours of Operation: Days of Week In Operation (Circle): Number of Employees Per Day: Potal Office Proposed Hours of Operation (Circle): Su M D W D So Existing 8 Proposed Hours of Operation (Circle): Proposed Hours of Operation (Circle): Proposed Hours of Operation (Circle): Existing 8 Proposed Hours of Operation (Circle): Proposed	sed 8	
	Existing/Prior Building Use: Proposed Building Use: Proposed Hours of Operation: Days of Week In Operation (Circle): Number of Employees Per Day: Number of Customers Per Day (Estimated): Existing Proposed Pro	sed 8	
	Existing/Prior Building Use: Proposed Building Use: Proposed Hours of Operation: Days of Week In Operation (Circle): Number of Employees Per Day: Number of Customers Per Day (Estimated): Proposed Hours of Operation (Circle): Existing Proposed Hours of Operation (Circle): Existing Proposed Hours of Operation (Circle): Existing Proposed Hours of Operation (Circle): Number of Employees Per Day: Existing Proposed Hours of Customers Per Day (Estimated): Proposed Hours of Customers Per Day (Estimated): Existing Proposed Hours of Operation (Circle): Nos A Describe Any Truck Delivery Schedule & Operations:	sed <u>\$</u>	
	Existing/Prior Building Use: Proposed Building Use: Proposed Hours of Operation: Days of Week In Operation (Circle): Number of Employees Per Day: Number of Customers Per Day (Estimated): Predicted Peak Operating Hour: Describe Any Truck Delivery Schedule & Operations: Please Identify Any Unique or Specific Traffic Patterns That Will Require Accommodations For Operating Attackment if Newscape (Proposed)	sed 8 sed 9 r Operations, Customers, or Employees	
OPERATIONS & TRAFFIC INFORMATION	Existing/Prior Building Use: Proposed Building Use: Proposed Hours of Operation: Days of Week In Operation (Circle): Number of Employees Per Day: Number of Customers Per Day (Estimated): Proposed Hours of Operation (Circle): Existing Proposed Hours of Operation (Circle): Existing Proposed Hours of Operation (Circle): Existing Proposed Hours of Operation (Circle): Number of Employees Per Day: Existing Proposed Hours of Customers Per Day (Estimated): Proposed Hours of Customers Per Day (Estimated): Existing Proposed Hours of Operation (Circle): Nos A Describe Any Truck Delivery Schedule & Operations:	sed 8 sed 9 r Operations, Customers, or Employees	
	Existing/Prior Building Use: Proposed Building Use: Proposed Hours of Operation: Days of Week In Operation (Circle): Number of Employees Per Day: Number of Customers Per Day (Estimated): Predicted Peak Operating Hour: Describe Any Truck Delivery Schedule & Operations: Please Identify Any Unique or Specific Traffic Patterns That Will Require Accommodations For Operating Attackment if Newscape (Proposed)	sed 8 sed 9 r Operations, Customers, or Employees	
	Existing/Prior Building Use: Proposed Building Use: Proposed Hours of Operation: Days of Week In Operation (Circle): Number of Employees Per Day: Number of Customers Per Day (Estimated): Predicted Peak Operating Hour: Describe Any Truck Delivery Schedule & Operations: Please Identify Any Unique or Specific Traffic Patterns That Will Require Accommodations For (Provide Separate Attachment if Necessary):	sed 8 sed 9 r Operations, Customers, or Employees	

	SITE PLAN MINIMUM REQUIREMENTS
	Submit a digital copy of the site plan(s) and completed application on a flash drive or equivalent (PDF format preferred, hard paper copies
15	not accepted).
SITE PLAN REQUIREMENTS	⇒ Digital copies must be clear, legible, and on a layout sized appropriately to convey all necessary project information.
SE SE	⇒ Site plan shall provide for and indicate all of the following:
N RE	- North arrow - Existing & proposed structures - Loading/unloading areas
PLA	- All existing & proposed site features - Adjacent street names - Accessible path of travel from right of way
STE	- Site dimensions, including building - Refuse enclosures & containers - Accessible path of travel from ADA stall
	 Existing and proposed fencing at site Valley oak trees (show drip line) Location and width of drive approaches to site Public improvements (curbs, sidewalks, Existing & proposed landscaping Tentative maps shall adhere to requirements
	utility poles, hydrants, street lights, etc.) - Parking stalls (include ADA) of Visalia Municipal Code Section 16
	Applicant Information (Final comments will be mailed to the name and address provided below)
RE	Name: Signature of Owner or Authorized Agent*
ATU	Address: 5607 Avenion Delos Pogues 2-8-23
N9I	City, State, Zip VISACA LA 93291 Owner Date
ED S	
REQUIRED SIGNATURE	Phone: 559-732-2660 Email: JPORINSON & SJVHOMES Com Authorized Agent* Date
RE	
	* If signed by an authorized agent, the "Agency Authorization" information below must be completed for this application to be considered acceptable.
	AGENCY AUTHORIZATION
	OWNER:
	I,, declare as follows; I am the owner of certain real property bearing assessor's parcel number (APN):
	parcer number (AFN).
	AGENT:
	I designate, to act as my duly authorized agent for all purposes necessary to file
FORM	an application for, and obtain a permit to
	relative to the property mentioned herein.
ZATIC	I declare under penalty of perjury the foregoing is true and correct.
AGENCY AUTHORIZATION	Executed this day of, 20
4UT	
VCY /	OWNER Signatures AGENT
AGE	
	Signature of Agent
	5607 AVENDA DE las l'ABRES
	Owner Mailing Address VISAA VA. 93292 Agent Mailing Address Agent Mailing Address
	559-132-2660
	Owner Phone Number Agent Phone Number
_	Page 2 of 2

Operation Statement

February 8, 2023

1744 S. Mooney Blvd.

This property currently has two tenants, Cross Country Mortgage and Nurses Boutique. Both tenants have been in this location for years.

We have struggled with vandalism and brake-ins for the last several years. Nurses was broken into two weeks ago when a window was smashed. Money and merchandise were stolen. Employees and shoppers/clients are continually harassed in the parking lot. I personally drive through the parking lot every day and pick up trash, shopping carts, human waste, make-shift beds, etc. I have called the police at lease 25 times to help get a trespasser off the property. The tenants have also called the police for trespassers. I have toured City Councilmen around the property, and we are a member of the TEP program. We have installed locks on the trash enclosure, locks on our electrical meters, removed hose bibs, installed a fence in the back of the property, installed cameras, upgraded front doors, etc. but Nothing we have done to date has helped. I personally do not see any benefit in the TEP program. The police have no power except to make the trespasser leave and go to my neighbor's property. When I drive Mooney before daylight there are numerous people sleeping in doorways, trash enclosures, bus stops, etc. We have created a Visalia Skid Row on Mooney. As property owners we do not see any other way but to put fences and gates up.

<u>Our tenants are tired of dealing with this problem and plan to vacate the building later this year if we cannot fix the problem.</u>

We propose to install a rolling gate at the front of the parking lot and move the trash enclosure from the back of the building to the front of the property. The current enclosure is next to the building has recently been set on fire and flames burnt the side of the building. The existing enclosure is not in a safe location and needs to moved. The trash bin is a split trash and recycle container. The amount of green waste from the small yard is removed from the site by the Gardiner. The green waste is not put in the bin.

I have met with Roger Dhaliwal who owns the building to the South and he is in agreement to our plans. We will extend the wrought fence to the south to connect to his building. A 4 foot gate will be installed to he can access the side of his building.

Thank you for your consideration in this matter.

Jim Robinson 559-804-7419



CITY OF VISALIA SITE PLAN REVIEW APPLICATION

Additional information and assistance in filling out this application can be found at the City of Visalia website (www.visalia.city) or by calling (559) 713-4440.



This application MUST be filled out in its entirety and submitted with an acceptable site plan (see site plan minimum requirements & submittal details on Page 2). Failure to provide all requested information may result in rejection of your application and exclusion from the Site Plan Review agenda.

Site Plan Review meetings are held on Wednesdays at 9:00 a.m. online utilizing Microsoft Teams. The applicant or representative must be present.

Application submittal deadline are Thursday at 4:00 p.m. to be scheduled for the next available meeting.

	Project/Business Name: T-Mobile Wireless Communications Facility	y Date: 2/7/2023
	Project Description: Proposed installation of an emergency standby (b	pack-up) generator at an existing
	T-Mobile wireless communications facility.	
JKIM/	Site Plan Review Resubmittal: Yes No If Resubmittal, Previous Site Plan	lan Review Number:
GENERAL PROJECI INFORMATION	Property Owner: T-Mobile	
OJEC	Applicant(s) Name: T-Mobile West LLC (Agent: Jeff Lienert)	
۲. P.R	Project Address/Location: 1345 N. American Street, Visalia, CA	
NEK/	Assessor Parcel Number: <u>073-160-024</u> & <u>073-160</u> -026	
5	Parcel Size (Acreage or Square Feet): T-Mobile Building or Suite Sc	quare Footage: N/A
	Are There Any Proposed Building Modifications: Yes No	THIS AREA FOR CITY STAFF USE ONLY
	Estimated Cost of Modifications to Building: \$30,000 (cost of generator installation)	Date Received:
	Describe All Proposed Building Modifications: No building modifications are proposed	02/15/2023 SPR Agenda: Item No
	with this application. The applicant is seeking approval of an emergency standby	Zone: SPR No
	generator installation at its existing wireless communications facility, within the	Historic District: Yes No
	existing fenced communication site compound.	Flood Zone: X X AE X/AE
	A SEPARATE, DETAILED OPERATIONAL STATEMENT IS HIGHLY RECOM	MENDED FOR ALL SUBMITTALS
	A SEPARATE, DETAILED OPERATIONAL STATEMENT IS HIGHLY RECOM Existing/Prior Building Use: Existing T-Mobile wireless communications facility.	MENDED FOR ALL SUBMITTALS
	Existing/Prior Building Use: Existing T-Mobile wireless communications facility. Proposed Building Use: No changes other than adding an emergency backup general	ntor to the existing T-Mobile wireless facility.
	Existing/Prior Building Use: Proposed Building Use: No changes other than adding an emergency backup genera The wireless facility operates 24/7/365. Aside from routine maint For maintenance the generator is exercised once per week for a	ntor to the existing T-Mobile wireless facility.
NOIN	Existing/Prior Building Use: Existing T-Mobile wireless communications facility. Proposed Building Use: No changes other than adding an emergency backup genera The wireless facility operates 24/7/365. Aside from routine maint	ntor to the existing T-Mobile wireless facility.
JRIMALION	Existing/Prior Building Use: Proposed Building Use: No changes other than adding an emergency backup genera The wireless facility operates 24/7/365. Aside from routine maintreproposed Hours of Operation: For maintenance the generator is exercised once per week for a on a non-holiday weekday.	ntor to the existing T-Mobile wireless facility. enance the generator will operate during a power outage opproximately 15-minutes during normal business hours
INFORMATION	Existing/Prior Building Use: Proposed Building Use: No changes other than adding an emergency backup genera The wireless facility operates 24/7/365. Aside from routine mainter proposed Hours of Operation: Proposed Hours of Operation: Days of Week In Operation (Circle): Su M T W Th F Sa	ntor to the existing T-Mobile wireless facility. enance the generator will operate during a power outage opproximately 15-minutes during normal business hours d 0 (unmanned)
AFFIC INFORMALION	Existing/Prior Building Use: Proposed Building Use: No changes other than adding an emergency backup general The wireless facility operates 24/7/365. Aside from routine mainton an emergency backup general The wireless facility operates 24/7/365. Aside from routine mainton a non-holiday weekday. Days of Week In Operation (Circle): Su M T W Th F Sa Number of Employees Per Day: Existing 0 (unmanned) Propose Number of Customers Per Day (Estimated): Existing 0 (unmanned) Propose	ntor to the existing T-Mobile wireless facility. enance the generator will operate during a power outage opproximately 15-minutes during normal business hours d 0 (unmanned)
AFF	Existing / Prior Building Use: Proposed Building Use: No changes other than adding an emergency backup general The wireless facility operates 24/7/365. Aside from routine mainting For maintenance the generator is exercised once per week for all on a non-holiday weekday. Days of Week In Operation (Circle): Su M T W Th F Sa Number of Employees Per Day: Existing 0 (unmanned) Propose Predicted Peak Operating Hour: Unknown/TBD. The generator will operation will operation will operation will operation will operation.	ator to the existing T-Mobile wireless facility. enance the generator will operate during a power outage opproximately 15-minutes during normal business hours d 0 (unmanned) d 0 (unmanned)
AFF	Existing / Prior Building Use: Proposed Building Use: No changes other than adding an emergency backup general The wireless facility operates 24/7/365. Aside from routine mainting For maintenance the generator is exercised once per week for all on a non-holiday weekday. Days of Week In Operation (Circle): Su M T W Th F Sa Number of Employees Per Day: Existing 0 (unmanned) Propose Predicted Peak Operating Hour: Unknown/TBD. The generator will operation will operation will operation will operation will operation.	ator to the existing T-Mobile wireless facility. enance the generator will operate during a power outage opproximately 15-minutes during normal business hours d 0 (unmanned) d 0 (unmanned) te during power outages and/or shutdowns. ed. The 240-gallon fuel tank will be refueled
AFF	Existing/Prior Building Use: Proposed Building Use: No changes other than adding an emergency backup general The wireless facility operates 24/7/365. Aside from routine mainting For maintenance the generator is exercised once per week for an on a non-holiday weekday. Days of Week In Operation (Circle): Number of Employees Per Day: Number of Customers Per Day (Estimated): Existing O (unmanned) Propose Predicted Peak Operating Hour: Unknown/TBD. The generator will operation No regular truck delivery requires	ator to the existing T-Mobile wireless facility. enance the generator will operate during a power outage opproximately 15-minutes during normal business hours d 0 (unmanned) d 0 (unmanned) te during power outages and/or shutdowns. ed. The 240-gallon fuel tank will be refueled nerator on and off.
OPERATIONS & TRAFFIC INFORMATION	Existing/Prior Building Use: Proposed Building Use: No changes other than adding an emergency backup general The wireless facility operates 24/7/365. Aside from routine mainting For maintenance the generator is exercised once per week for an on a non-holiday weekday. Days of Week In Operation (Circle): Number of Employees Per Day: Number of Customers Per Day (Estimated): Existing O (unmanned) Propose Predicted Peak Operating Hour: Unknown/TBD. The generator will operate Sulvery Schedule & Operations: No regular truck delivery requires as necessary. An automatic transfer switch will be installed to power the generator will be set to prove the generator will be installed to power the generator will be installed to powe	ator to the existing T-Mobile wireless facility. enance the generator will operate during a power outage opproximately 15-minutes during normal business hours d
AFF	Existing/Prior Building Use: Proposed Building Use: No changes other than adding an emergency backup general The wireless facility operates 24/7/365. Aside from routine mainting For maintenance the generator is exercised once per week for an on a non-holiday weekday. Days of Week In Operation (Circle): Number of Employees Per Day: Number of Customers Per Day (Estimated): Existing O (unmanned) Propose Predicted Peak Operating Hour: Unknown/TBD. The generator will operate as necessary. An automatic transfer switch will be installed to power the generator and the propose Predicted Peak Operation of Customers Per Day (Estimated): No regular truck delivery required as necessary. An automatic transfer switch will be installed to power the generator in the propose Predicted Peak Operation of Customers Per Day (Estimated): No regular truck delivery required as necessary. An automatic transfer switch will be installed to power the generator in the propose Predicted Peak Operation of Customers Per Day (Estimated): No regular truck delivery required as necessary. An automatic transfer switch will be installed to power the generator in the propose Predicted Peak Operation of Customers Per Day (Estimated): No regular truck delivery required to power the generator is exercised once per week for a power to a non-holiday weekday. Days of Week In Operation (Circle): Su M T W Th F Sa Number of Customers Per Day (Estimated): Existing O (unmanned) Propose Per Day: Describe Any Truck Delivery Schedule & Operations: No regular truck delivery required Peak Operations Per Oper	ator to the existing T-Mobile wireless facility. enance the generator will operate during a power outage opproximately 15-minutes during normal business hours d
AFF	Existing/Prior Building Use: Proposed Building Use: No changes other than adding an emergency backup general The wireless facility operates 24/7/365. Aside from routine mainting For maintenance the generator is exercised once per week for an on a non-holiday weekday. Days of Week In Operation (Circle): Su M T W Th F Sa Number of Employees Per Day: Existing 0 (unmanned) Propose Predicted Peak Operating Hour: Unknown/TBD. The generator will operate as necessary. An automatic transfer switch will be installed to power the generate Attachment if Necessary): This is an unmanned facility and the installed to power the generator will operate the generator and the propose of the propose	ator to the existing T-Mobile wireless facility. enance the generator will operate during a power outage opproximately 15-minutes during normal business hours d
AFF	Existing/Prior Building Use: Proposed Building Use: No changes other than adding an emergency backup general The wireless facility operates 24/7/365. Aside from routine mainter For maintenance the generator is exercised once per week for a on a non-holiday weekday. Days of Week In Operation (Circle): Number of Employees Per Day: Existing O (unmanned) Propose Predicted Peak Operating Hour: Unknown/TBD. The generator will operate as necessary. An automatic transfer switch will be installed to power the generator will operate the generator will operate the generator will operate as necessary. An automatic transfer switch will be installed to power the generator will operate the generator is exercised once per week for a maintenance the generator is exercised once per week for a maintenance the generator is exercised once per week for a maintenance the generator is exercised once per week for a maintenance the generator is exercised once per week for a maintenance the generator is exercised once per wee	ator to the existing T-Mobile wireless facility. enance the generator will operate during a power outage opproximately 15-minutes during normal business hours d

	SITE PLAN MINIMUM REQUIREMENTS				
٠,	Submit a digital copy of the site plan(s) and completed application on a flash drive or equivalent (PDF format preferred, hard paper copies				
ENT	not accepted).				
IREM	Digital copies must be clear, legible, and on a layout sized appropriately to convey all necessary project information.				
SITE PLAN REQUIREMENTS	Site plan shall provide for and indicate all of the following: - North arrow - All existing & proposed site features - Site dimensions, including building - Existing and proposed fencing at site - Public improvements (curbs, sidewalks, utility poles, hydrants, street lights, etc.) - Site plan shall provide for and indicate all of the following: - Existing & proposed structures - Accessible path of travel from right of way - Accessible path of travel from ADA stall - Location and width of drive approaches to site - Tentative maps shall adhere to requirements of Visalia Municipal Code Section 16				
	Applicant Information (Final comments will be mailed to the name and address provided below)				
REQUIRED SIGNATURE	Name: Jeff Lienert for T-Mobile Address: 2154 Medici Way City, State, Zip El Dorado Hills, CA 95762 Phone: (916) 505-3683 Signature of Owner or Authorized Agent* Owner signature is not required per Assembly Bill 2421 Section 65850.75 of the Government Code Owner Date 2/7/2023				
EQL	Email: Jeff.Lienert@gmail.com Authorized Agent* Date				
4	* If signed by an authorized agent, the "Agency Authorization" information below must be completed for this application to be considered acceptable.				
	AGENCY AUTHORIZATION				
	OWNER: I,, declare as follows; I am the owner of certain real property bearing assessor's parcel number (APN): 073-160-024 & 073-160-026 AGENT:				
	I designateJeff Lienert for T-Mobile, to act as my duly authorized agent for all purposes necessary to file				
ORM	an application for, and obtain a permit to <u>install an emergency power generator</u> relative to the property mentioned herein.				
) NC	relative to the property mentioned herein.				
ZATI	I declare under penalty of perjury the foregoing is true and correct.				
AGENCY AUTHORIZATION FORN	Executed this <u>7th</u> day of <u>February</u> , 20 <u>23</u> .				
/ AUT					
ENC	OWNER Signatures AGENT				
AG	Owner signature is not required per Assembly Bill 2421 Section 65850.75 of the Government Code				
	Signature of Owner Signature of Agent				
	2154 Medici Way				
	Owner Mailing Address Agent Mailing Address El Dorado Hills, CA 95762				
	(916) 505-3683 / jeff.lienert@gmail.com				
	Owner Phone Number Agent Phone Number				
	<u></u>				

Page 2 of 2

SINGLE SOURCE CONSULTING, INC.

Agent for T-Mobile: Single Source Consulting, Inc. Site Address: 1345 N. American Street, Visalia, CA

February 7, 2023

City of Visalia Planning Division 315 E. Acequia Avenue Visalia, CA 93291

Re: Request to Install an Emergency Standby Generator to Serve a Macro Cell Tower Site located at 1345 N. American Street, Visalia, CA 93291 for existing T-Mobile Site # SC70000A

Dear Planning Division:

Attached is an application to install an Emergency Standby Generator to Serve a Macro Cell Tower. Effective January 1, 2021, <u>California General Assembly Bill 2421</u> allows wireless providers to prepare for future fire seasons and power outages by creating an administrative process to expedite the installation of standby generators.

The attached application qualifies for expedited administrative process under Section 65850.75(b) of the Government Code because it meets the following criteria (see the attached plans and application for details):

- (1) The emergency standby generator is rated below 50 horsepower, complies with applicable air quality regulations, has a double-walled storage tank that does not exceed 300 gallons, and is mounted on a concrete pad. (The proposed generator will reach up to 48.8 horsepower and will have a 240-gallon tank.)
- (2) The macro cell tower site at which the emergency standby generator is proposed to be installed is an existing site that was previously permitted by the applicable local agency.
- (3) The emergency standby generator complies with all applicable state and local laws and regulations, including building and fire safety codes.
- (4) The physical dimensions of the emergency standby generator and storage tank are cumulatively no more than 250 cubic feet in volume. (The volume for the proposed generator + tank = Volume = 192.05 cubic feet)
- (5) The emergency standby generator shall be located not more than 100 feet from the physical structure of the macro cell tower or base station.

Pursuant to Section 65850.75(c), applications may not require any new or different information than routine applications for other emergency generators. Notice of incomplete applications must be given within 10 days of submittal. The notice must indicate the manner in which the application can be made complete, including a list and thorough description of the specific information needed to complete the application. To further expedite the approval process, AB 2421 provides that proof of underlying property owner approval is not required as part of the initial application but may be required prior to installation.¹

-

¹ Cal. Gov't Code § 65850.75(f)

SINGLE SOURCE CONSULTING, INC.

A complete application must be approved within 60 days of receiving the application or it shall be deemed approved. ²

According to Section 65850.75(g) a cost-based fees may be imposed but the fee shall not exceed the reasonable costs of providing the service for which the fee is charged and shall not be levied for general revenue purposes.

Please contact me if you have any questions. I can be reached at (916) 505-3683 or at jeff.lienert@gmail.com.

Sincerely,

Jeff Lienert

Phone: (916) 505-3683 Email: jeff.lienert@gmail.com

Address: 2154 Medici Way, El Dorado Hills, CA 95762

² *Id.* § 65850.75(d)



OPERATIONAL STATEMENT

Proposed T-Mobile Emergency Standby Generator

T-Mobile Site # SC70000A

1345 N. American Street, Visalia, CA

APN: 073-160-024 & 073-160-026

T-Mobile currently operates an existing wireless communications facility at 1345 N. American Street in Visalia, CA. T-Mobile's existing facility includes the collocation of panel antennas on an existing self-support water tower together with ground equipment located on an existing concrete pad at the base of the water tower. T-Mobile needs to install a standby power generator for backup power. In order to meet California Public Utilities Commission requirements, which include a minimum of 72-hours backup power at cell site locations serving high-risk wildfire areas, T-Mobile is proposing to install a new Generac 25kW diesel generator on a new 4' x 9' concrete pad on the west side of the northwest tower leg. New swing gates will be added to the existing fence to allow access to the generator.

The proposed Generac 25kW diesel generator measures 103.4" (L) x 35" (W) x 91.7" (H). A new power 1-1/2" conduit will connect to a new automatic transfer switch that will be mounted on a new H-Frame within T-Mobile's existing lease area. The automatic transfer switch measures 20" x 14.6" x 7" (H x W x D) and will allow for ease of operation and will help reduce switchover problems.

Additional details:

- Generac 25kW diesel generator specifications are incorporated into the plans.
- The generator will extend roughly 91.7" above grade.
- The fuel will be stored in a 240-gallon double-walled belly tank (the tank and the generator are comprised within the same unit, there is no separate fuel tank).
- The fuel tank is registered with Underwriters Laboratories Standard to meet or exceed U.L. 142
- The fuel tank includes a secondary containment basin to prevent escape of fuel into the environment in the event of a tank rupture.
- The generator operates below 50 horsepower.
- The generator includes a factory installed sound attenuated aluminum enclosure.
- The rated load sound output at 23 feet is 65 dB(A).
- The generator will be serviced approximately once every 6-months.
- Routine testing will occur once a week for approximately 15-minutes during normal business hours on a non-holiday weekday.

T··Mobile·



Above: View of typical 25kW Generac diesel generator.

In an effort to provide a more reliable network and to ensure continuous operation in the event of a power outage and/or emergency situation, T-Mobile is proposing to install a new 25kW diesel generator for backup power. As consumers increasingly use their wireless devices at home and in their neighborhoods, T-Mobile needs to ensure its network can continue to handle voice and data traffic during a power outage and/or emergency situation. By installing a permanent generator, for backup power, T-Mobile is better positioned to ensure its customers will have access to a more robust network when needed most. The proposed generator will not be detrimental to the public health, safety, or general welfare of the City of Visalia. The proposed facility will not materially or adversely affect adjacently located properties or their permitted uses. T-Mobile's wireless communications facility is a modern-day utility and will contribute to the provision of enhanced wireless communication technology for the general public and emergency services use.

I - Mobile-

WEST LLC


GOSHEN WATER TANK SC70000A

GENERATOR PROJECT 1345 N. AMERICAN STREET VISALIA, CA 93291

TULARE COUNTY

SITE DIRECTIONS

DEPART 1755 CREEKSIDE OAKS DR, SACRAMENTO, CA 95833 ON CREEKSIDE OAKS DR (WEST). TURN LEFT (SOUTH-WEST) ONTO CAPITAL PARK DR, THEN IMMEDIATELY TURN LEFT (SOUTH) ONTO NATOMAS PARK DR. TURN RIGHT (WEST) ONTO GARDEN HWY. TAKE RAMP (RIGHT) ONTO 1-5 [CA-99]. TURN RIGHT ONTO RAMP. KEEP STRAIGHT TO STAY ON RAMP. TAKE RAMP (LEFT) ONTO I-80 BRANCH [US-50]. KEEP RIGHT ONTO RAMP [CA-99]. TAKE RAMP (RIGHT) ONTO CA-99 [GOLDEN STATE HWY S]. ROAD NAME CHANGES TO CA-12 [CA-99]. ROAD NAME CHANGES TO CA-99. ROAD NAME CHANGES TO CA-26 [CA-99]. AT EXIT 253, ROAD NAME CHANGES TO CA-4 [CA-99]. ROAD NAME CHANGES TO CA-99. ROAD NAME CHANGES TO CA-120 [CA-99]. ROAD NAME CHANGES TO CA-99. ROAD NAME CHANGES TO CA-140 [[CA-99]. ROAD NAME CHANGES TO CA-99. AT EXIT 98B, KEEP RIGHT ONTO RAMP. TURN LEFT (EAST) ONTO CR-J32 [BETTY DR]. KEEP STRAIGHT ONTO CR-J32 [ELDER AVE]. BEAR LEFT (EAST) ONTO CR-J32 [ELDER DR]. TURN RIGHT (SOUTH) ONTO CR-J32 [CAMP DR]. TURN LEFT (EAST) ONTO CR-J32 [W GOSHEN AVE]. TURN RIGHT (SOUTH) ONTO LOCAL ROAD(S). ARRIVE AT THE EXISTING SITE.

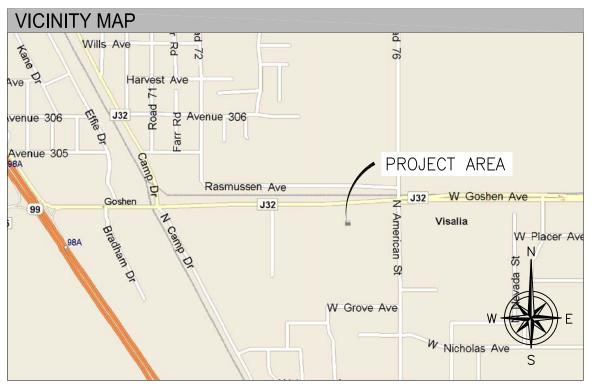

PROJECT DESCRIPTION

THE PROJECT CONSISTS OF INSTALLING (1) 200 AMP GENERAC AUTOMATIC TRANSFER SWITCH, (1) GENERAC 25KW DIESEL GENERATOR ON (N) CONCRETE PAD AND ASSOCIATED EQUIPMENT LOCATED WITHIN A (N) LEASE AREA. INSTALL CHAIN LINK ACCESS GATES

DEVELOPMENT AND CONSTRUCTION OF THIS PROJECT WILL COMPLY WITH ALL APPLICABLE CODES AND ORDINANCES.

THIS PROJECT DOES NOT INCLUDE WATER OR SEWER.

EXISTING PARKING IS NOT AFFECTED BY THIS PROJECT.

SHEET INDEX

- T-1 PROJECT INFORMATION AND DATA
- GN-1 GENERAL NOTES
- A-1 SITE PLAN
- A-2 ENLARGED SITE PLANA-3 ELEVATIONS
- A-4 DETAILS
- A-4 DETAILSA-5 DETAILS
 - 4-6 GENERATOR SIGNAGE
- E-1 ELECTRICAL DETAILS
- E-2 GROUNDING DETAILS
- E-3 ELECTRICAL DETAILS

PROJECT CONTACTS

T-MOBILE WEST, LLC 1755 CREEKSIDE OAKS DRIVE SUITE 190 SACRAMENTO, CA 95833

PROPERTY OWNER: RACE LEASING, LP

3031 WEST CHERRY VISALIA, CA 93291

PROJECT MANAGER:
T-MOBILE WEST, LLC
1755 CREEKSIDE OAKS DRIVE

SUITE 190 SACRAMENTO, CA 95833 CONTACT: JIM MORAN PHONE: (707) 450-5653

SITE ACQUISITION: T-MOBILE WEST, LLC

1755 CREEKSIDE OAKS DRIVE SUITE 190 SACRAMENTO, CA 95833 CONTACT: JEFF LIENERT PHONE: (916) 505-3683

CONSULTING FIRM:

SINGLE SOURCE INC.
4340 E. INDIAN SCHOOL RD
STE 21. #464
PHOENIX, AZ 85018
CONTACT: JEREMY WATTERBERG
PHONE: (602) 910-6030

DJECT DATA

ZONING: S

APN: 073-160-024-000 & 073-160-026-000

USE:

PARENT PARCEL: — ACRES

EXISTING LEASE AREA: — SQ. FT

JURISDICTION: CITY OF VISALIA

BUILDING CODES:

- 2022 CALIFORNIA ADMINISTRATIVE CODE, PART 1, TITLE 24 C.C.R.
 2022 CALIFORNIA BUILDING CODE (CBC), PART 2, VOLUMES 1 & 2 TITLE 24 C.C.R.
- 2022 CALIFORNIA ELECTRICAL CODE (CEC), PART 3, TITLE 24 C.C.R.
 2022 CALIFORNIA MECHANICAL CODE (CMC), PART 4, TITLE 24 C.C.R.
 2022 CALIFORNIA PLUMBING CODE (CPC), PART 5, TITLE 24 C.C.R.
- 2022 CALIFORNIA PLUMBING CODE (CPC), PART 5, TITLE 24 C.C.R. 2022 CALIFORNIA ENERGY CODE (CEC), PART 6, TITLE 24 C.C.R. 2022 CALIFORNIA FIRE CODE, PART 9, TITLE 24 C.C.R.
- 2022 CALIFORNIA GREEN BUÍLDING STÁNDARDS CODE, PART 11, TITLE 24 C.C.R. 2022 CALIFORNIA REFERENCED STARNDARDS, PART 12, TITLE 24 C.C.R. ANSI/EIA-TIA-222-H
- ALONG WITH ANY OTHER APPLICABLE LOCAL & STATE LAWS AND REGULATIONS

POLE COORDINATES

LATITUDE: 36° 20' 27.960" NORTH (NAD83) LONGITUDE: -119° 24' 20.988" WEST (NAD83)

GENERAL NOTES

- 1. THIS WIRELESS TELECOMMUNICATIONS FACILITY WILL MEET THE HEALTH AND SAFETY STANDARDS FOR ELECTROMAGNETIC FIELD EMISSIONS AS ESTABLISHED BY THE FEDERAL COMMUNICATIONS COMMISSION OR ANY SUCCESSOR THEREOF, AND ANY OTHER FEDERAL OR STATE AGENCY.
- 2. THIS WIRELESS TELECOMMUNICATIONS FACILITY WILL MEET THE REGULATIONS OF THE FEDERAL COMMUNICATIONS COMMISSION REGARDING PHYSICAL AND ELECTROMAGNETIC INTERFERENCE.
- 3. LIGHTING OR SIGNS WILL BE PROVIDED ONLY AS REQUIRED BY FEDERAL OR STATE AGENCIES.

APPROVALS

 T-MOBILE (RF):
 DATE:

 T-MOBILE (CONST.):
 DATE:

 T-MOBILE (RE):
 DATE:

 LANDLORD:
 DATE:

PREPARED FOR:



1755 CREEKSIDE OAKS DRIN SUITE 190 SACRAMENTO, CA 95833

CONSULTING FIRM



4340 E. INDIAN SCHOOL RD STE 21. #464 PHOENIX, AZ 85018 HONE: 602-910-6030 FAX: 480-279-1271

PROJECT NO: 0000

DRAWN BY: CH

CHECKED BY: GH

	Α	1/18/23	ISSUE FOR REVIEW
	REV	DATE	DESCRIPTION
. '			

GOSHEN WATER TANK

SC70000A

1345 N. AMERICAN STREET VISALIA, CA 93291 TULARE COUNTY

sheet title PROJECT INFORMATION AND DATA

SHEET NUMBER

GENERAL NOTES:

- 1. FOR THE PURPOSE OF CONSTRUCTION DRAWING, THE FOLLOWING DEFINITIONS SHALL APPLY: CONTRACTOR - TBD SUBCONTRACTOR - GENERAL CONTRACTOR (CONSTRUCTION) OWNER - T-MOBILE
- PRIOR TO THE SUBMISSION OF BIDS, THE BIDDING SUBCONTRACTOR SHALL VISIT THE CELL SITE TO FAMILIARIZE WITH THE EXISTING CONDITIONS AND TO CONFIRM THAT THE WORK CAN BE ACCOMPLISHED AS SHOWN ON THE CONSTRUCTION DRAWINGS. ANY DISCREPANCY FOUND SHALL BE BROUGHT TO THE ATTENTION OF CONTRACTOR.

OEM — ORIGINAL EQUIPMENT MANUFACTURE

- 3. ALL MATERIALS FURNISHED AND INSTALLED SHALL BE IN STRICT ACCORDANCE WITH ALL APPLICABLE CODES, REGULATIONS, AND ORDINANCES. SUBCONTRACTOR SHALL ISSUE ALL APPROPRIATE NOTICES AND COMPLY WITH ALL LAWS, ORDINANCES, RULES, REGULATIONS, AND LAWFUL ORDERS OF ANY PUBLIC AUTHORITY REGARDING THE PERFORMANCE OF THE WORK.ALL WORK CARRIED OUT SHALL COMPLY WITH ALL APPLICABLE MUNICIPAL AND UTILITY COMPANY SPECIFICATIONS AND LOCAL JURISDICTIONAL CODES, ORDINANCES AND APPLICABLE REGULATIONS.
- 4. DRAWINGS PROVIDED HERE ARE NOT TO BE SCALED AND ARE INTENDED TO SHOW OUTLINE
- 5. UNLESS NOTED OTHERWISE, THE WORK SHALL INCLUDE FURNISHING MATERIALS, EQUIPMENT, APPURTENANCES, AND LABOR NECESSARY TO COMPLETE ALL INSTALLATIONS AS INDICATED ON THE DRAWINGS.
- 6. DELETED.
- 7. THE SUBCONTRACTOR SHALL INSTALL ALL EQUIPMENT AND MATERIALS IN ACCORDANCE WITH MANUFACTURER'S RECOMMENDATIONS UNLESS SPECIFICALLY STATED OTHERWISE.
- 8. IF THE SPECIFIED EQUIPMENT CANNOT BE INSTALLED AS SHOWN ON THESE DRAWINGS, THE SUBCONTRACTOR SHALL PROPOSE AN ALTERNATIVE INSTALLATION FOR APPROVAL BY THE CONTRACTOR.
- 9. SUBCONTRACTOR SHALL DETERMINE ACTUAL ROUTING OF CONDUIT, POWER AND T1 CABLES, GROUNDING CABLES AS SHOWN ON THE POWER, GROUNDING AND TELCO PLAN DRAWING. SUBCONTRACTOR SHALL UTILIZE EXISTING TRAYS AND/OR SHALL ADD NEW TRAYS AS NECESSARY. SUBCONTRACTOR SHALL CONFIRM THE ACTUAL ROUTING WITH THE CONTRACTOR. ROUTING OF TRENCHING SHALL BE APPROVED BY CONTRACTOR
- 10. THE SUBCONTRACTOR SHALL PROTECT EXISTING IMPROVEMENTS, PAVEMENTS, CURBS, LANDSCAPING AND STRUCTURES. ANY DAMAGED PART SHALL BE REPAIRED AT SUBCONTRACTOR'S EXPENSE TO THE SATISFACTION OF OWNER.
- 11. SUBCONTRACTOR SHALL LEGALLY AND PROPERLY DISPOSE OFF ALL SCRAP MATERIALS SUCH AS COAXIAL CABLES AND OTHER ITEMS REMOVED FROM THE EXISTING FACILITY. ANTENNAS REMOVED SHALL BE RETURNED TO THE OWNER'S DESIGNATED LOCATION.
- 12. SUBCONTRACTOR SHALL LEAVE PREMISES IN CLEAN CONDITION.
- 13. ALL CONCRETE REPAIR WORK SHALL BE DONE IN ACCORDANCE WITH AMERICAN CONCRETE INSTITUTE (ACI) 301.
- 14. ANY NEW CONCRETE NEEDED FOR THE CONSTRUCTION SHALL HAVE 4000 PSI STRENGTH AT 28 DAYS UNLESS OTHERWISE SPECIFIED.ALL CONCRETING WORK SHALL BE DONE IN ACCORDANCE WITH ACI 318 CODE REQUIREMENTS.
- 15. ALL STRUCTURAL STEEL WORK SHALL BE DONE IN ACCORDANCE WITH AISC SPECIFICATIONS.
- 16. CONSTRUCTION SHALL COMPLY WITH SPECIFICATION 25741-000-3APS-A00Z-00002, "GENERAL CONSTRUCTION SERVICES.
- 17. SUBCONTRACTOR SHALL VERIFY ALL EXISTING DIMENSIONS AND CONDITIONS PRIOR TO COMMENCING ANY WORK. ALL DIMENSIONS OF EXISTING CONSTRUCTION SHOWN ON THE DISCREPANCIES PRIOR TO ORDERING MATERIAL OR PROCEEDING WITH CONSTRUCTION.
- 18. THE EXISTING CELL SITE IS IN FULL COMMERCIAL OPERATION. ANY CONSTRUCTION WORK BY SUBCONTRACTOR SHALL NOT DISRUPT THE EXISTING NORMAL OPERATION, ANY WORK ON EXISTING EQUIPMENT MUST BE COORDINATED WITH CONTRACTOR. ALSO, WORK MAY NEED TO BE SCHEDULED FOR AN APPROPRIATE MAINTENANCE WINDOW USUALLY IN LOW TRAFFIC PERIODS
- 19. SINCE THE CELL SITE MAY BE ACTIVE, ALL SAFETY PRECAUTIONS MUST BE TAKEN WHEN WORKING AROUND HIGH LEVELS OF ELECTROMAGNETIC RADIATION. EQUIPMENT SHOULD BE SHUTDOWN PRIOR TO PERFORMING ANY WORK THAT COULD EXPOSE THE WORKERS TO DANGER. PERSONAL RF EXPOSURE MONITORS ARE REQUIRED TO BE WORN TO ALERT OF ANY DANGEROUS EXPOSURE LEVELS.

CONCRETE AND REINFORCING STEEL NOTES:

NOTED OTHERWISE.

- 1. ALL CONCRETE WORK SHALL BE IN ACCORDANCE WITH THE ACI 301, ACI 318, ACI 336, ASTM A184, ASTM A185 AND THE DESIGN AND CONSTRUCTION SPECIFICATION FOR CAST-IN-PLACE CONCRETE.
- 2. ALL CONCRETE SHALL HAVE A MINIMUM COMPRESSIVE STRENGTH OF 4000 PSI AT 28 DAYS, UNLESS
- 3. REINFORCING STEEL SHALL CONFORM TO ASTM A 615, GRADE 60, DEFORMED UNLESS NOTED OTHERWISE. WELDED WIRE FABRIC SHALL CONFORM TO ASTM A 185 WELDED STEEL WIRE FABRIC UNLESS NOTED OTHERWISE. SPLICES SHALL BE CLASS "B" AND ALL HOOKS SHALL BE STANDARD,
- 4. THE FOLLOWING MINIMUM CONCRETE COVER SHALL BE PROVIDED FOR REINFORCING STEEL UNLESS SHOWN OTHERWISE ON DRAWINGS:

CONCRETE EXPOSED TO EARTH OR WEATHER:

CONCRETE NOT EXPOSED TO EARTH OR WEATHER OR NOT CAST AGAINST THE GROUND:

- A CHAMFER 3/4" SHALL BE PROVIDED AT ALL EXPOSED EDGES OF CONCRETE, UNO, IN ACCORDANCE WITH ACI 301 SECTION 4.2.4.
- 5. POST INSTALLED ANCHORS SHALL BE PROVIDED IN ACCORDANCE WITH SPECIFICATION 3GS-T18-00013 "SELECTION, DESIGN, INSTALLATION, INSPECTION AND TESTING OF ADHESIVE AND MECHANICAL EXPANSION ANCHORS FOR WIRELESS SITE FACILITIES". ANCHORS SHALL BE HILTI OR APPROVED EQUAL, INSTALLED, INSPECTED AND TESTED AS SHOWN ON THE DESIGN DRAWINGS. NO REINFORCING STEEL SHALL BE CUT WITHOUT PRIOR ENGINEERING APPROVAL.
- 6. CONCRETE CYLINDER TEST IS NOT REQUIRED FOR SLAB ON GRADE WHEN CONCRETE IS LESS THAN 50 CUBIC YARDS (IBC 1905.6.2) IN THAT EVENT THE FOLLOWING RECORDS SHALL BE PROVIDED BY THE CONCRETE SUPPLIER;
- (A) RESULTS OF CONCRETE CYLINDER TESTS PERFORMED AT THE SUPPLIER'S PLANT,
- (B) CERTIFICATION OF MINIMUM COMPRESSIVE STRENGTH FOR
- THE CONCRETE GRADE SUPPLIED. FOR GREATER THAN 50 CUBIC YARDS THE GC SHALL PERFORM THE CONCRETE CYLINDER TEST, TAKING THREE CYLINDERS FROM EACH TRUCK.

GROUNDING NOTES:

- 1. THE SUBCONTRACTOR SHALL REVIEW AND INSPECT THE EXISTING FACILITY GROUNDING SYSTEM AND LIGHTNING PROTECTION SYSTEM (AS DESIGNED AND INSTALLED) FOR STRICT COMPLIANCE WITH THE NEC (AS ADOPTED BY THE AHJ), THE SITE-SPECIFIC (UL, LPI, OR NFPA) LIGHTING PROTECTION CODE, AND GENERAL COMPLIANCE WITH TELCORDIA AND TIA GROUNDING STANDARDS. THE SUBCONTRACTOR SHALL REPORT ANY VIOLATIONS OR ADVERSE FINDINGS TO THE CONTRACTOR FOR RESOLUTION.
- 2. ALL GROUND ELECTRODE SYSTEMS (INCLUDING TELECOMMUNICATION, RADIO, LIGHTNING PROTECTION, AND AC POWER GES'S) SHALL BE BONDED TOGETHER, AT OR BELOW GRADE, BY TWO OR MORE COPPER BONDING CONDUCTORS IN ACCORDANCE WITH THE NEC.
- 3. THE SUBCONTRACTOR SHALL PERFORM IEEE FALL-OF-POTENTIAL RESISTANCE TO EARTH TESTING (PER IEEE 1100 AND 81) FOR NEW GROUND ELECTRODE SYSTEMS. THE SUBCONTRACTOR SHALL FURNISH AND INSTALL SUPPLEMENTAL GROUND ELECTRODES AS NEEDED TO ACHIEVE A TEST RESULT OF 5 OHMS OR LESS. TESTS SHALL BE PERFORMED IN ACCORDANCE WITH 25471-000-3PS-EG00-0001, DESIGN & TESTING OF FACILITY GROUNDING FOR CELL SITES.
- 4. METAL RACEWAY SHALL NOT BE USED AS THE NEC REQUIRED EQUIPMENT GROUND CONDUCTOR. STRANDED COPPER CONDUCTORS WITH GREEN INSULATION, SIZED IN ACCORDANCE WITH THE NEC, SHALL BE FURNISHED AND INSTALLED WITH THE POWER CIRCUITS TO BTS EQUIPMENT.
- 5. EACH BTS CABINET FRAME SHALL BE DIRECTLY CONNECTED TO THE MASTER GROUND BAR WITH GREEN INSULATED SUPPLEMENTAL EQUIPMENT GROUND WIRES, 6 AWG STRANDED COPPER OR LARGER FOR INDOOR BTS; 2 AWG STRANDED COPPER FOR OUTDOOR BTS.
- 6. EXOTHERMIC WELDS SHALL BE USED FOR ALL GROUNDING CONNECTIONS BELOW GRADE.
- 7. APPROVED ANTIOXIDANT COATINGS (I.E., CONDUCTIVE GEL OR PASTE) SHALL BE USED ON ALL COMPRESSION AND BOLTED GROUND CONNECTIONS.
- 8. ICE BRIDGE BONDING CONDUCTORS SHALL BE EXOTHERMICALLY BONDED OR BOLTED WITH STAINLESS STEEL HARDWARE TO THE BRIDGE AND THE MONOPOLE GROUND BAR.
- 9. ALUMINUM CONDUCTOR OR COPPER CLAD STEEL CONDUCTOR SHALL NOT BE USED FOR GROUNDING CONNECTIONS.
- 10. MISCELLANEOUS ELECTRICAL AND NON-ELECTRICAL METAL BOXES, FRAMES AND SUPPORTS SHALL BE BONDED TO THE GROUND RING, IN ACCORDANCE WITH THE NEC.
- 11. METAL CONDUIT AND TRAY SHALL BE GROUNDED AND MADE ELECTRICALLY CONTINUOUS WITH LISTED BONDING FITTINGS OR BY BONDING ACROSS THE DISCONTINUITY WITH 6 AWG COPPER WIRE UL APPROVED GROUNDING TYPE CONDUIT CLAMPS.
- 12. GROUND CONDUCTORS USED IN THE FACILITY GROUND AND LIGHTNING PROTECTION SYSTEMS SHALL NOT BE ROUTED THROUGH METALLIC OBJECTS THAT FORM A RING AROUND THE CONDUCTOR, SUCH AS METALLIC CONDUITS, METAL SUPPORT CLIPS OR SLEEVES THROUGH WALLS OR FLOORS. WHEN IT IS REQUIRED TO BE HOUSED IN CONDUIT TO MEET CODE REQUIREMENTS OR LOCAL CONDITIONS, NON-METALLIC MATERIAL SUCH AS PVC PLASTIC CONDUIT SHALL BE USED. WHERE USE OF METAL CONDUIT IS UNAVOIDABLE (E.G., NON-METALLIC CONDUIT PROHIBITED BY LOCAL CODE) THE GROUND CONDUCTOR SHALL BE BONDED TO EACH END OF THE METAL CONDUIT.
- 13. ALL MONOPOLE GROUNDING SYSTEMS SHALL COMPLY WITH THE REQUIREMENTS OF ANSI/TIA 222.
- MONOPOLES BEING BUILT TO REV G OF THE STANDARD, THE WIRE SIZE OF THE BURIED GROUND RING AND CONNECTIONS BETWEEN THE MONOPOLE AND THE BURIED GROUND RING SHALL BE CHANGED FROM 2 AWG TO 2/0 AWG. IN ADDITION, THE MINIMUM LENGTH OF THE GROUND RODS SHALL BE INCREASED FROM 8 FEET TO 10 FEET.

SITE WORK GENERAL NOTES:

- 1. THE SUBCONTRACTOR SHALL CONTACT UTILITY LOCATING SERVICES PRIOR TO THE START OF CONSTRUCTION.
- 2. ALL EXISTING ACTIVE SEWER, WATER, GAS, ELECTRIC, AND OTHER UTILITIES WHERE ENCOUNTERED IN THE WORK, SHALL BE PROTECTED AT ALL TIMES, AND WHERE REQUIRED FOR THE PROPER EXECUTION OF THE WORK, SHALL BE RELOCATED AS DIRECTED BY CONTRACTOR. EXTREME CAUTION SHOULD BE USED BY THE SUBCONTRACTOR WHEN EXCAVATING OR DRILLING PIERS AROUND OR NEAR UTILITIES. SUBCONTRACTOR SHALL PROVIDE SAFETY TRAINING FOR THE WORKING CREW. THIS WILL INCLUDE BUT NOT BE LIMITED TO A) FALL PROTECTION B) CONFINED SPACE C) ELECTRICAL SAFETY D) TRENCHING & EXCAVATION.
- 3. ALL SITE WORK SHALL BE AS INDICATED ON THE DRAWINGS AND PROJECT SPECIFICATIONS.
- 4. IF NECESSARY, RUBBISH, STUMPS, DEBRIS, STICKS, STONES AND OTHER REFUSE SHALL BE REMOVED FROM THE SITE AND DISPOSED OFF LEGALLY.
- 5. ALL EXISTING INACTIVE SEWER. WATER. GAS. ELECTRIC AND OTHER UTILITIES. WHICH INTERFERE WITH THE EXECUTION OF THE WORK, SHALL BE REMOVED AND/OR CAPPED. PLUGGED OR OTHERWISE DISCONTINUED AT POINTS WHICH WILL NOT INTERFERE WITH THE EXECUTION OF THE WORK, SUBJECT TO THE APPROVAL OF CONTRACTOR, OWNER AND/OR LOCAL UTILITIES.
- 6. SUBCONTRACTOR SHALL MINIMIZE DISTURBANCE TO EXISTING SITE DURING CONSTRUCTION.
- 7. THE SUBCONTRACTOR SHALL PROVIDE SITE SIGNAGE IN ACCORDANCE WITH THE T-MOBILE WIRELESS SPECIFICATION FOR SITE SIGNAGE.
- 8. THE SITE SHALL BE GRADED TO CAUSE SURFACE WATER TO FLOW AWAY FROM THE BTS EQUIPMENT AND MONOPOLE AREAS.
- 9. NO FILL OR EMBANKMENT MATERIAL SHALL BE PLACED ON FROZEN GROUND. FROZEN MATERIALS, SNOW OR ICE SHALL NOT BE PLACED IN ANY FILL OR EMBANKMENT.
- 10. THE SUB GRADE SHALL BE COMPACTED AND BROUGHT TO A SMOOTH UNIFORM GRADE PRIOR TO FINISHED SURFACE APPLICATION.
- 11. THE AREAS OF THE OWNERS PROPERTY DISTURBED BY THE WORK AND NOT COVERED BY THE MONOPOLE, EQUIPMENT OR DRIVEWAY, SHALL BE GRADED TO A UNIFORM SLOPE, AND STABILIZED TO PREVENT EROSION.
- 12. SUBCONTRACTOR SHALL MINIMIZE DISTURBANCE TO EXISTING SITE DURING CONSTRUCTION. EROSION CONTROL MEASURES, IF REQUIRED DURING CONSTRUCTION, SHALL BE IN CONFORMANCE WITH THE LOCAL JURISDICTION'S GUIDELINES FOR EROSION AND SEDIMENT CONTROL.

- **ELECTRICAL INSTALLATION NOTES:**
- 1. WIRING, RACEWAY, AND SUPPORT METHODS AND MATERIALS SHALL COMPLY WITH THE REQUIREMENTS OF THE NEC AND TELCORDIA.
- 2. SUBCONTRACTOR SHALL MODIFY EXISTING CABLE TRAY SYSTEM AS REQUIRED TO SUPPORT RF AND TRANSPORT CABLING TO THE NEW BTS EQUIPMENT. SUBCONTRACTOR SHALL SUBMIT MODIFICATIONS TO CONTRACTOR FOR APPROVAL.
- 3. ALL CIRCUITS SHALL BE SEGREGATED AND MAINTAIN MINIMUM CABLE SEPARATION AS REQUIRED BY THE NEC AND TELCORDIA.
- 4. CABLES SHALL NOT BE ROUTED THROUGH LADDER-STYLE CABLE TRAY RUNGS.
- 5. EACH END OF EVERY POWER, GROUNDING, AND T1 CONDUCTOR AND CABLE SHALL BE LABELED WITH COLOR-CODED INSULATION OR ELECTRICAL TAPE (3M BRAND, 1/2 INCH PLASTIC ELECTRICAL TAPE WITH UV PROTECTION, OR EQUAL). THE IDENTIFICATION METHOD SHALL CONFORM WITH NEC & OSHA, AND MATCH EXISTING INSTALLATION REQUIREMENTS.
- 6. POWER PHASE CONDUCTORS (I.E., HOTS) SHALL BE LABELED WITH COLOR-CODED INSULATION OR ELECTRICAL TAPE (3M BRAND, ½ INCH PLASTIC ELECTRICAL TAPE WITH UV PROTECTION, OR EQUAL). PHASE CONDUCTOR COLOR CODES SHALL CONFORM WITH THE NEC & OSHA AND MATCH EXISTING INSTALLATION REQUIREMENTS.
- 7. ALL ELECTRICAL COMPONENTS SHALL BE CLEARLY LABELED WITH ENGRAVED LAMACOID PLASTIC LABELS. ALL EQUIPMENT SHALL BE LABELED WITH THEIR VOLTAGE RATING, PHASE CONFIGURATION, WIRE CONFIGURATION, POWER OR AMPACITY RATING, AND BRANCH CIRCUIT ID NUMBERS (I.E., PANELBOARD AND CIRCUIT ID'S).
- 8. PANELBOARDS (ID NUMBERS) AND INTERNAL CIRCUIT BREAKERS (CIRCUIT ID NUMBERS) SHALL BE CLEARLY LABELED WITH ENGRAVED LAMACOID PLASTIC LABELS.
- 9. ALL TIE WRAPS WHERE PERMITTED SHALL BE CUT FLUSH WITH APPROVED CUTTING TOOL TO REMOVE SHARP EDGES. USE LOW PROFILES TIE WRAPS.
- 10. POWER, CONTROL, AND EQUIPMENT GROUND WIRING IN TUBING OR CONDUIT SHALL BE SINGLE CONDUCTOR (12 AWG OR LARGER), 600 V, OIL RESISTANT THHN OR THWN-2, CLASS B STRANDED COPPER CABLE RATED FOR 90 °C (WET AND DRY) OPERATION; LISTED OR LABELED FOR THE LOCATION AND RACEWAY SYSTEM USED, UNLESS OTHERWISE SPECIFIED.
- 11. SUPPLEMENTAL EQUIPMENT GROUND WIRING LOCATED INDOORS SHALL BE SINGLE CONDUCTOR (6 AWG OR LARGER), 600 V, OIL RESISTANT THHN OR THWN-2 GREEN INSULATION, CLASS B STRANDED COPPER CABLE RATED FOR 90 °C (WET AND DRY) OPERATION; LISTED OR LABELED FOR THE LOCATION AND RACEWAY SYSTEM USED, UNLESS OTHERWISE SPECIFIED.
- 12. SUPPLEMENTAL EQUIPMENT GROUND WIRING LOCATED OUTDOORS, OR BELOW GRADE, SHALL BE SINGLE CONDUCTOR 2 AWG SOLID TINNED COPPER CABLE, UNLESS OTHERWISE SPECIFIED.
- 13. POWER WIRING, NOT IN TUBING OR CONDUIT, SHALL BE MULTI-CONDUCTOR, TYPE TC CABLE (12 AWG OR LARGER), 600 V, OIL RESISTANT THHN OR THWN-2, CLASS B STRANDED COPPER CABLE RATED FOR 90 °C (WET AND DRY) OPERATION; WITH OUTER JACKET; LISTED OR LABELED FOR THE LOCATION USED, UNLESS OTHERWISE SPECIFIED.
- 14. ALL POWER AND GROUNDING CONNECTIONS SHALL BE CRIMP-STYLE, COMPRESSION WIRE LUGS AND WIRENUTS BY THOMAS AND BETTS (OR EQUAL). LUGS AND WIRENUTS SHALL BE RATED FOR OPERATION AT NO LESS THAN 75°C (90°C IF AVAILABLE).
- 15. RACEWAY AND CABLE TRAY SHALL BE LISTED OR LABELED FOR ELECTRICAL USE IN ACCORDANCE WITH NEMA, UL, ANSI/IEEE, AND NEC.
- 16. NEW RACEWAY OR CABLE TRAY WILL MATCH THE EXISTING INSTALLATION WHERE POSSIBLE.
- 17. ELECTRICAL METALLIC TUBING (EMT) OR RIGID NONMETALLIC CONDUIT (I.E., RIGID PVC SCHEDULE 40. OR RIGID PVC SCHEDULE 80 FOR LOCATIONS SUBJECT TO PHYSICAL DAMAGE) SHALL BE USED FOR EXPOSED INDOOR LOCATIONS.
- 18. ELECTRICAL METALLIC TUBING (EMT), ELECTRICAL NONMETALLIC TUBING (ENT), OR RIGID NONMETALLIC CONDUIT (RIGID PVC, SCHEDULE 40) SHALL BE USED FOR CONCEALED INDOOR
- 19. GALVANIZED STEEL INTERMEDIATE METALLIC CONDUIT (IMC) SHALL BE USED FOR OUTDOOR LOCATIONS ABOVE GRADE.
- 20. RIGID NONMETALLIC CONDUIT (I.E., RIGID PVC SCHEDULE 40 OR RIGID PVC SCHEDULE 80) SHALL BE USED UNDERGROUND; DIRECT BURIED, IN AREAS OF OCCASIONAL LIGHT VEHICLE TRAFFIC OR ENCASED IN REINFORCED CONCRETE IN AREAS OF HEAVY VEHICLE TRAFFIC.
- 21. LIQUID-TIGHT FLEXIBLE METALLIC CONDUIT (LIQUID-TITE FLEX) SHALL BE USED INDOORS AND OUTDOORS, WHERE VIBRATION OCCURS OR FLEXIBILITY IS NEEDED.
- 22. CONDUIT AND TUBING FITTINGS SHALL BE THREADED OR COMPRESSION—TYPE AND APPROVED FOR THE LOCATION USED. SETSCREW FITTINGS ARE NOT ACCEPTABLE.
- 23. CABINETS, BOXES, AND WIREWAYS SHALL BE LISTED OR LABELED FOR ELECTRICAL USE IN ACCORDANCE WITH NEMA, UL, ANSI/IEEE, AND NEC.
- 24. CABINETS, BOXES, AND WIREWAYS TO MATCH THE EXISTING INSTALLATION WHERE POSSIBLE.
- 25. WIREWAYS SHALL BE EPOXY-COATED (GRAY) AND INCLUDE A HINGED COVER, DESIGNED TO SWING OPEN DOWNWARD; SHALL BE PANDUIT TYPE E (OR EQUAL); AND RATED NEMA 1 (OR BETTER) INDOORS, OR NEMA 3R (OR BETTER) OUTDOORS.
- 26. EQUIPMENT CABINETS, TERMINAL BOXES, JUNCTION BOXES, AND PULL BOXES SHALL BE GALVANIZED OR EPOXY-COATED SHEET STEEL, SHALL MEET OR EXCEED UL 50, AND RATED NEMA 1 (OR BETTER) INDOORS, OR NEMA 3R (OR BETTER) OUTDOORS
- 27. METAL RECEPTACLE, SWITCH, AND DEVICE BOXES SHALL BE GALVANIZED, EPOXY-COATED, OR NON-CORRODING; SHALL MEET OR EXCEED UL 514A AND NEMA OS 1; AND RATED NEMA 1 (OR BETTER) INDOORS, OR WEATHER PROTECTED (WP OR BETTER) OUTDOORS.
- 28. NONMETALLIC RECEPTACLE, SWITCH, AND DEVICE BOXES SHALL MEET OR EXCEED NEMA OS 2; AND RATED NEMA 1 (OR BETTER) INDOORS, OR WEATHER PROTECTED (WP OR BETTER) OUTDOORS.
- 29. THE SUBCONTRACTOR SHALL NOTIFY AND OBTAIN NECESSARY AUTHORIZATION FROM THE CONTRACTOR BEFORE COMMENCING WORK ON THE AC POWER DISTRIBUTION PANELS.
- 30. THE SUBCONTRACTOR SHALL PROVIDE NECESSARY TAGGING ON THE BREAKERS, CABLES AND DISTRIBUTION PANELS IN ACCORDANCE WITH THE APPLICABLE CODES AND STANDARDS TO SAFEGUARD AGAINST LIFE AND PROPERTY.

SOIL COMPACTION NOTES FOR SLAB ON GRADE:

- EXCAVATE AS REQUIRED TO REMOVE VEGETATION & TOPSOIL EXPOSE UNDISTURBED NATURAL SUBGRADE AND PLACE CRUSHED STONE AS REQUIRED.
- 2a. COMPACTION CERTIFICATION: AN INSPECTION AND WRITTEN CERTIFICATION

BY A QUALIFIED GEOTECHNICAL TECHNICIAN OR ENGINEER IS ACCEPTABLE.

- 2b. AS AN ALTERNATIVE TO ITEM 2a. THE "UNDISTURBED SOIL" BASE SHALL BE COMPACTED WITH "COMPACTION EQUIPMENT". LISTED BELOW, TO AT LEAST 90% MODIFIED PROCTOR MAXIMUM DENSITY PER ASTM D 1557 METHOD C.
- 2c. AS AN ALTERNATIVE TO ITEMS 2a AND 2b PROOFROLL THE SUBGRADE SOILS WITH 5 PASSES OF A MEDIUM SIZED VIBRATORY PLATE COMPACTOR (SUCH AS BOMAG BPR 30/38) OR HAND-OPERATED SINGLE DRUM VIBRATORY ROLLER (SUCH AS BOMAG BW 55E). ANY SOFT AREAS THAT ARE ENCOUNTERED SHOULD BE REMOVED AND REPLACED WITH A WELL-GRADED GRANULAR FILL, AND COMPACTED AS STATED ABOVE.
- 3. COMPACTED SUBBASE SHALL BE UNIFORM & LEVELED. PROVIDE 6" MINIMUM CRUSHED STONE OR GRAVEL COMPACTED IN 3" LIFTS ABOVE COMPACTED SOIL. GRAVEL SHALL BE NATURAL OR CRUSHED WITH 100% PASSING 1" SIEVE.

COMPACTION EQUIPMENT:

HAND OPERATED DOUBLE DRUM, VIBRATORY ROLLER, VIBRATORY PLATE COMPACTOR OR JUMPING JACK COMPACTOR.

SYMBOLS

SOLID GROUND BUS BAR

SOLID NEUTRAL BUS BAR

₩ SUPPLEMENTAL GROUND BAR

CIRCUIT BREAKER SINGLE-POLE THERMAL-MAGNETIC

CIRCUIT BREAKER

2-POLE THERMAL-MAGNETIC

CHEMICAL GROUND ROD

GROUND ROD

CADWELD TYPE CONNECTION

DISCONNECT SWITCH

COMPRESSION TYPE CONNECTION

---- GROUNDING WIRE

ABBREVIATIONS

- AGL ABOVE GRADE LEVEL
- BTS BASE TRANSCEIVER STATION
 - (E) EXISTING
 - NEW NEW
 - MIN MINIMUM
- N.T.S. NOT TO SCALE
- REF REFERENCE
- RF RADIO FREQUENCY

TYP TYPICAL

- REQ REQUIRED
- EGR EQUIPMENT GROUND RING
- AWG AMERICAN WIRE GAUGE CRGB MASTER GROUND BAR

(MASTER GROUND BAR)

- EG EQUIPMENT GROUND
- BCW BARE COPPER WIRE
- SIAD SMART INTEGRATED ACCESS DEVICE
- GEN GENERATOR
- IGR INTERIOR GROUND RING (HALO)
- RBS RADIO BASE STATION

SYMBOLS & ABBREVIATIONS

PREPARED FOR:

SUITE 190 SACRAMENTO, CA 95833 CONSULTING FIRM

1755 CREEKSIDE OAKS DRIVE



4340 E. INDIAN SCHOOL RD STE 21. #464 PHOENIX, AZ 85018 PHONE: 602-910-6030 FAX: 480-279-1271

PROJECT NO:	0000
DRAWN BY:	CI
CHECKED BY:	GI

A 1/18/23 ISSUE FOR REVIEW REV DATE DESCRIPTION


> **GOSHEN WATER TANK** SC70000A


1345 N. AMERICAN STREET VISALIA, CA 93291 TULARE COUNTY


GENERAL NOTES

SHEET TITLE

SHEET NUMBER

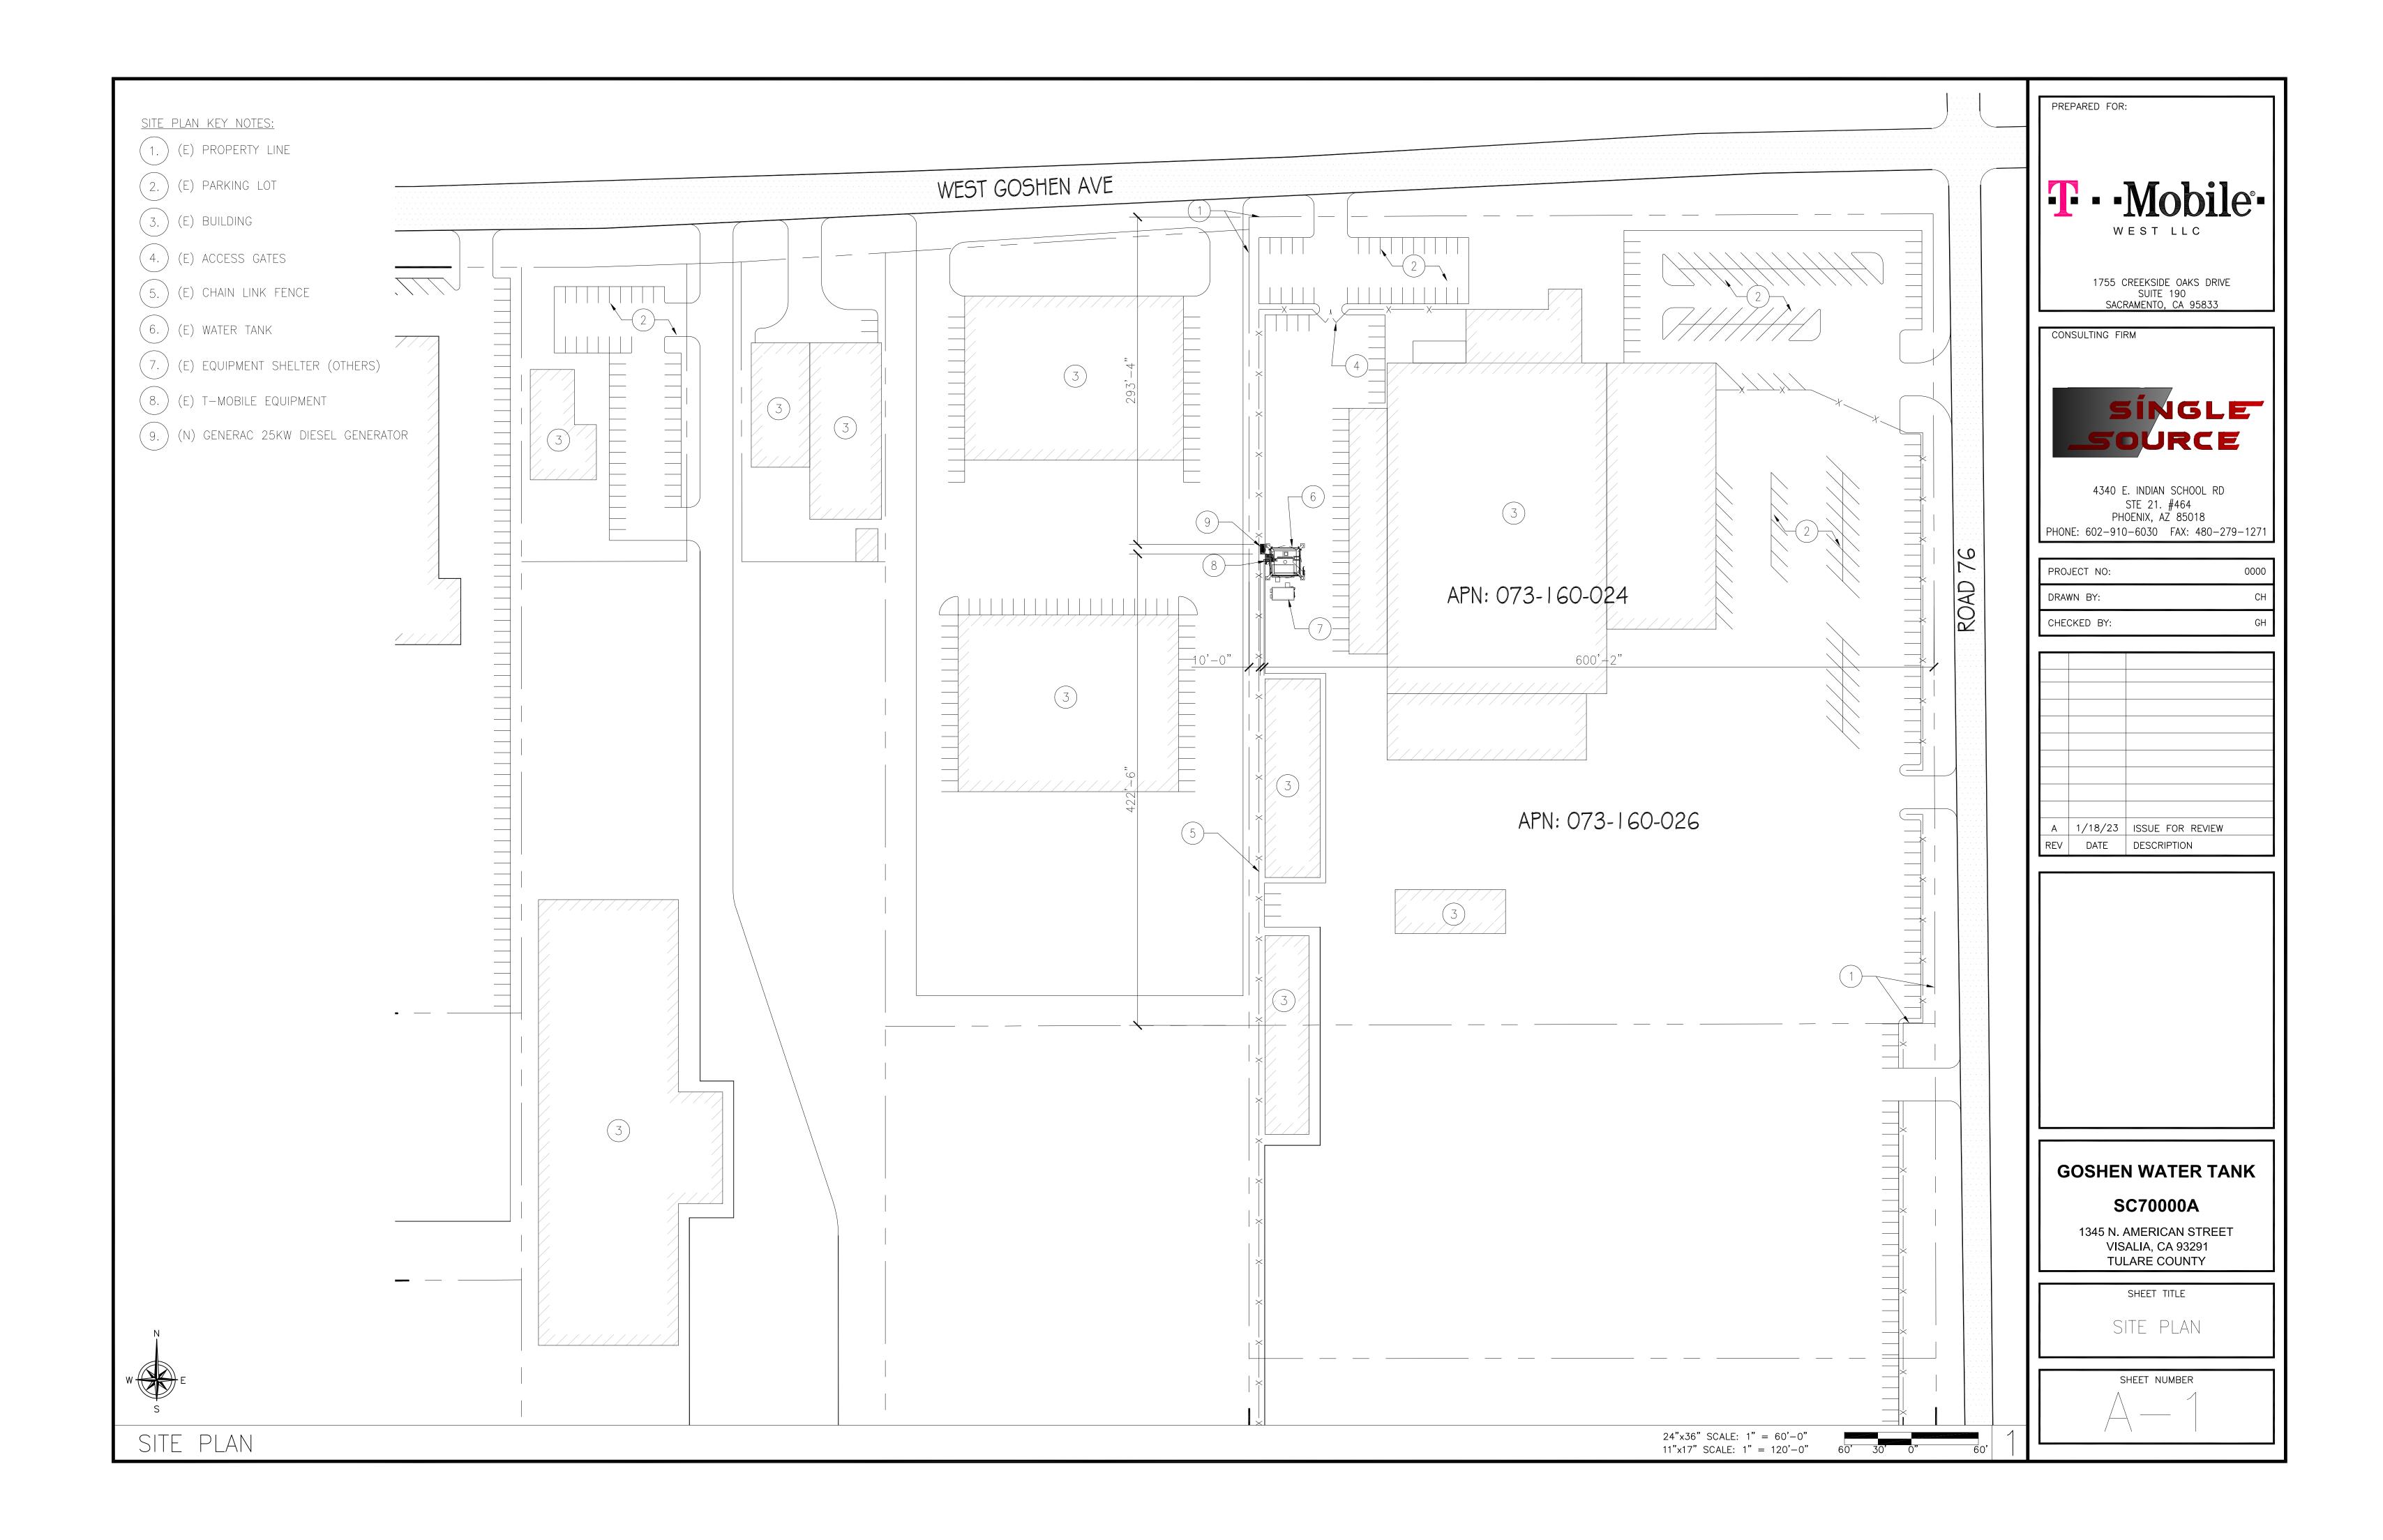

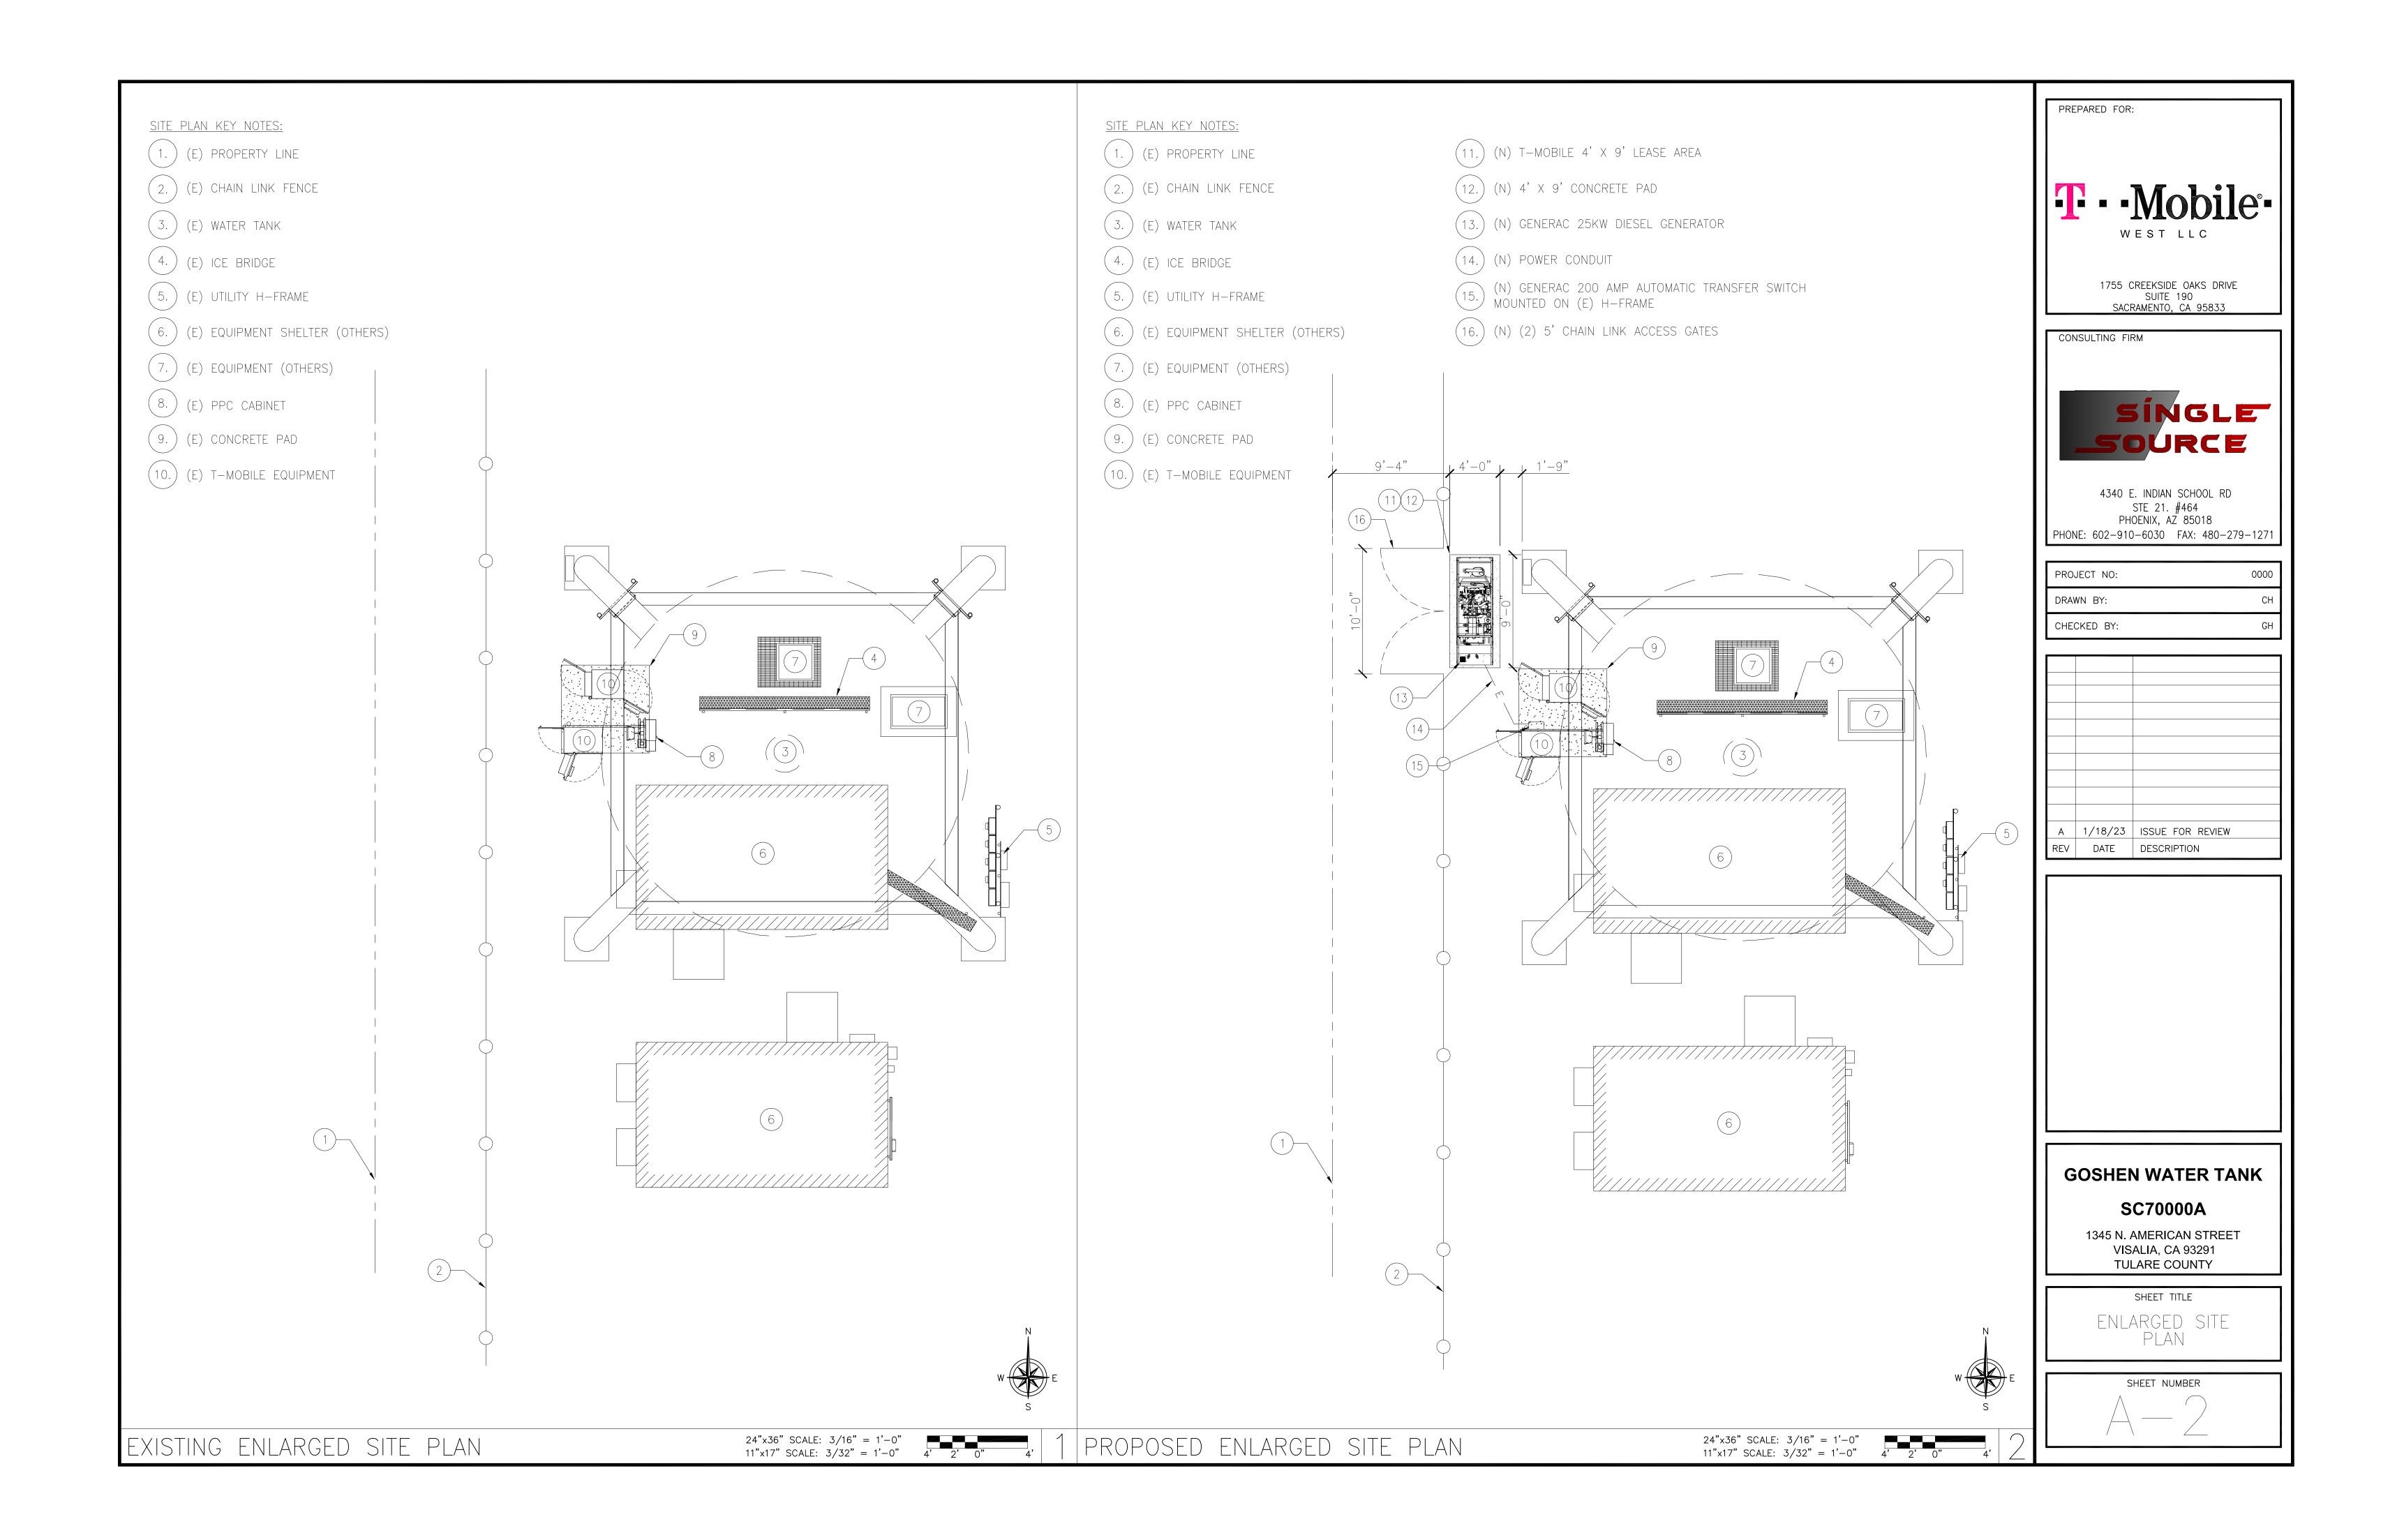

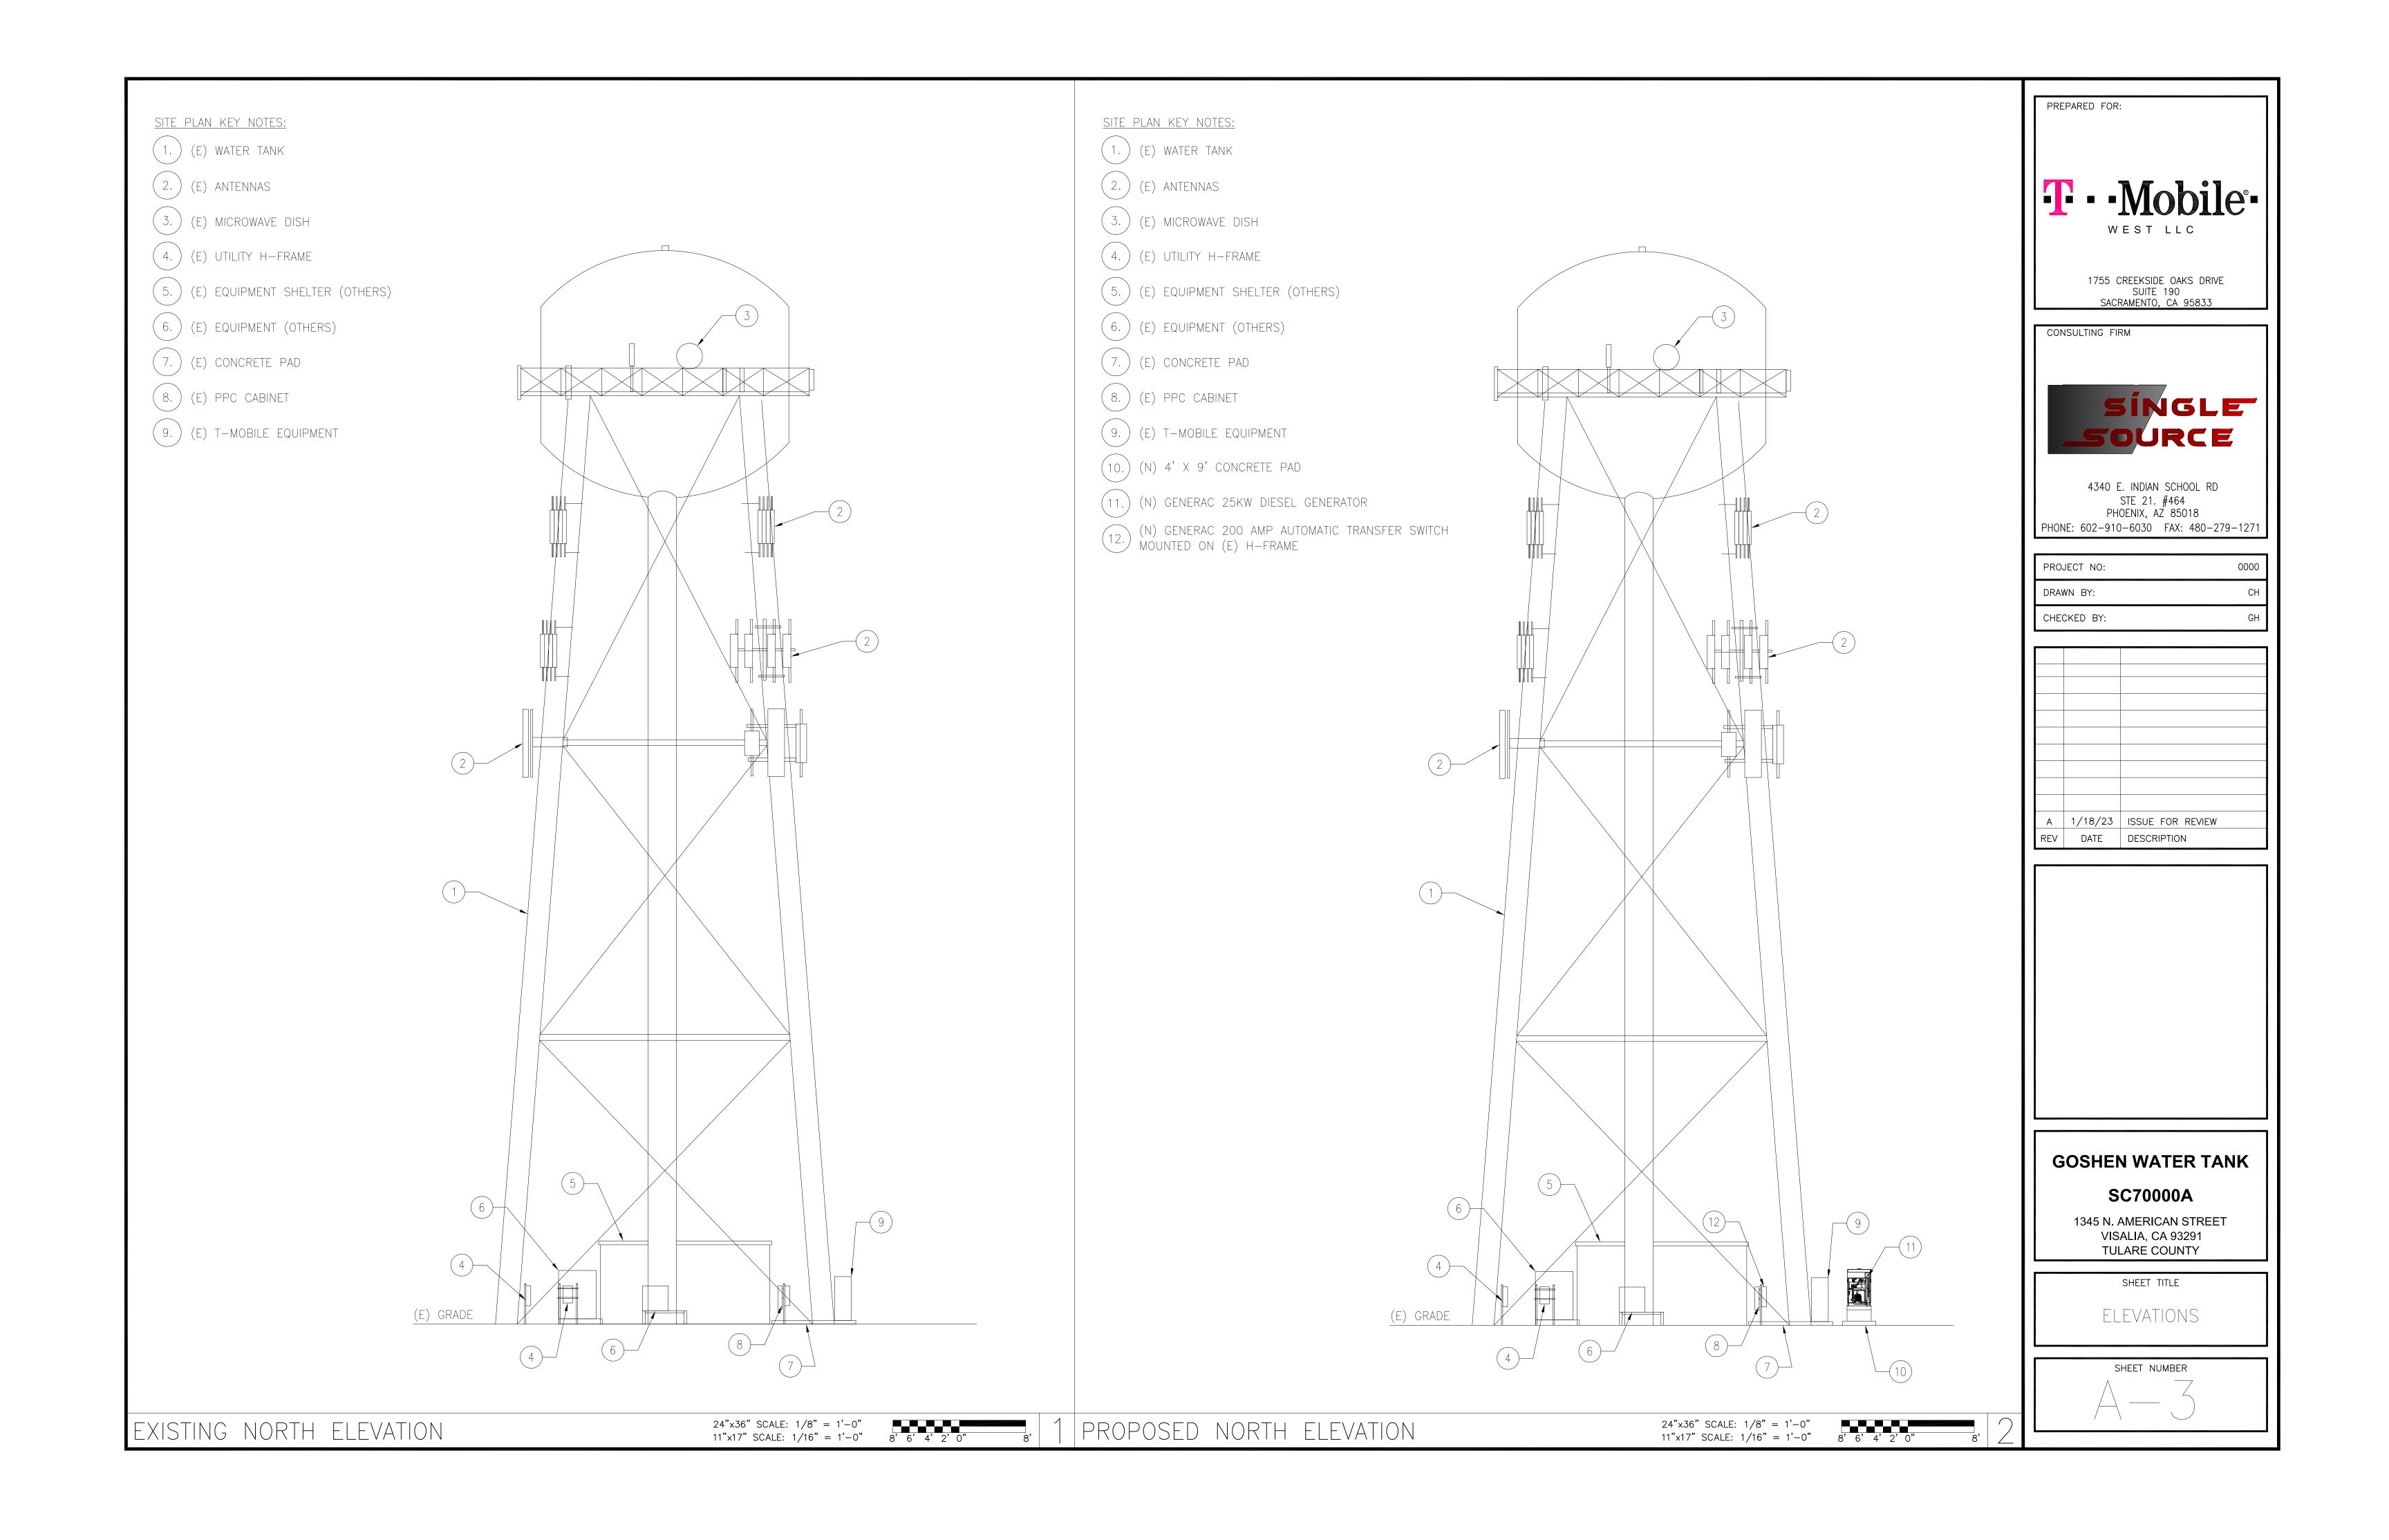



SPECIFICATIONS

MODEL	RXSC200A3
AMPS	200
VOLTAGE	120/240, 1ø
LOAD TRANSITION TYPE (AUTOMATIC)	OPEN TRANSITION
ENCLOSURE TYPE	NEMA/UL 3R
UL RATING	UL/CUL

DIMENSIONS


MODEL		RXSC200A3
HEIGHT	Н1	17.24/437.9
(IN./MM)	H2	20/508
WIDTH (IN./MM)	W 1	12.5/317.5
	W2	14.6/370.8
DEPTH (IN./MM) WEIGHT (LBS./KILOS)		7.09/180.1
		20/9.07

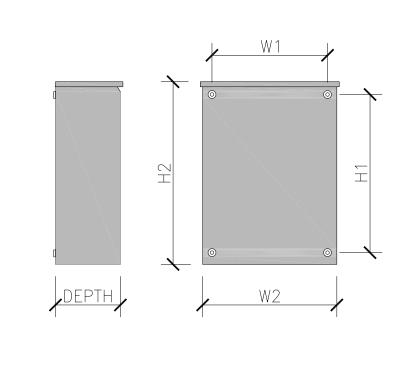

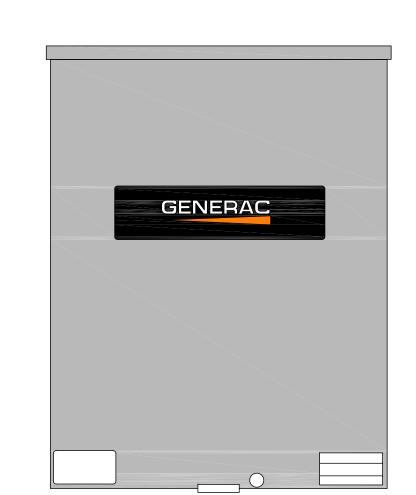

GENERAC 200 AMP AUTOMATIC TRANSFER SWITCH

SCALE: 2

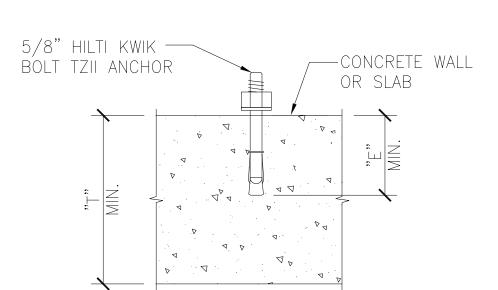



	ANCHOR SCHEDUL	.E	
BOLT DIAMETER	5/	/8"	
BIT DIAMETER	5/	/8"	
"E" MIN. EMBEDMENT DEPTH	3-1/4"	4	"
"T" MIN. THICKNESS	5"	6"	8"
MIN. EDGE DISTANCE	3-1/4"	2-3	/8"
PULLOUT STRENGTH CRACKED CONCRETE	N/A	5,840) LBS

ANCHOR SCHEDULE NOTE: INFORMATION SHOWN IN THIS TABLE IS IN ACCORDANCE WITH: ICC REPORT ESR-1917

NOTES:

- 1. SUBSTITUTION OF A HILTI KWIK BOLT TZ ANCHOR WITH OTHER EXPANSION ANCHORS MANUFACTURED BY HILTI OR BY OTHER MANUFACTURERS IS NOT ALLOWED WITHOUT THE WRITTEN APPROVAL OF THIS ENGINEERING PRIOR TO INSTALLATION. THE CONTRACTOR SHALL BEAR THE ENTIRE COST OF REPLACEMENT OF NON—APPROVED ANCHORS.
- 2. THE CONTRACTOR SHALL ACCURATELY LOCATE ALL EXISTING REINFORCING BY X-RAY OR EQUIVALENT METHOD. NO REBAR OR TENDONS SHALL BE CUT. ALL EXPENSES RELATED TO REPAIR OF CUT REBAR OR TENDONS SHALL BE ENTIRELY AT THE EXPENSE OF THE CONTRACTOR.
- 3. SPECIAL INSPECTION IS REQUIRED FOR INSTALLATION OF ANCHORS.
- 4. INSTALLATION OF CONCRETE ANCHORS IN MASONRY IS NOT ALLOWED.
- 5. USE STAINLESS STEEL FOR EXPOSED APPLICATIONS.
- 6. NORMAL-WEIGHT AND SAND-WEIGHT CONCRETE MUST CONFORM TO SECTIONS 1903 AND 1905 OF THE IBC.

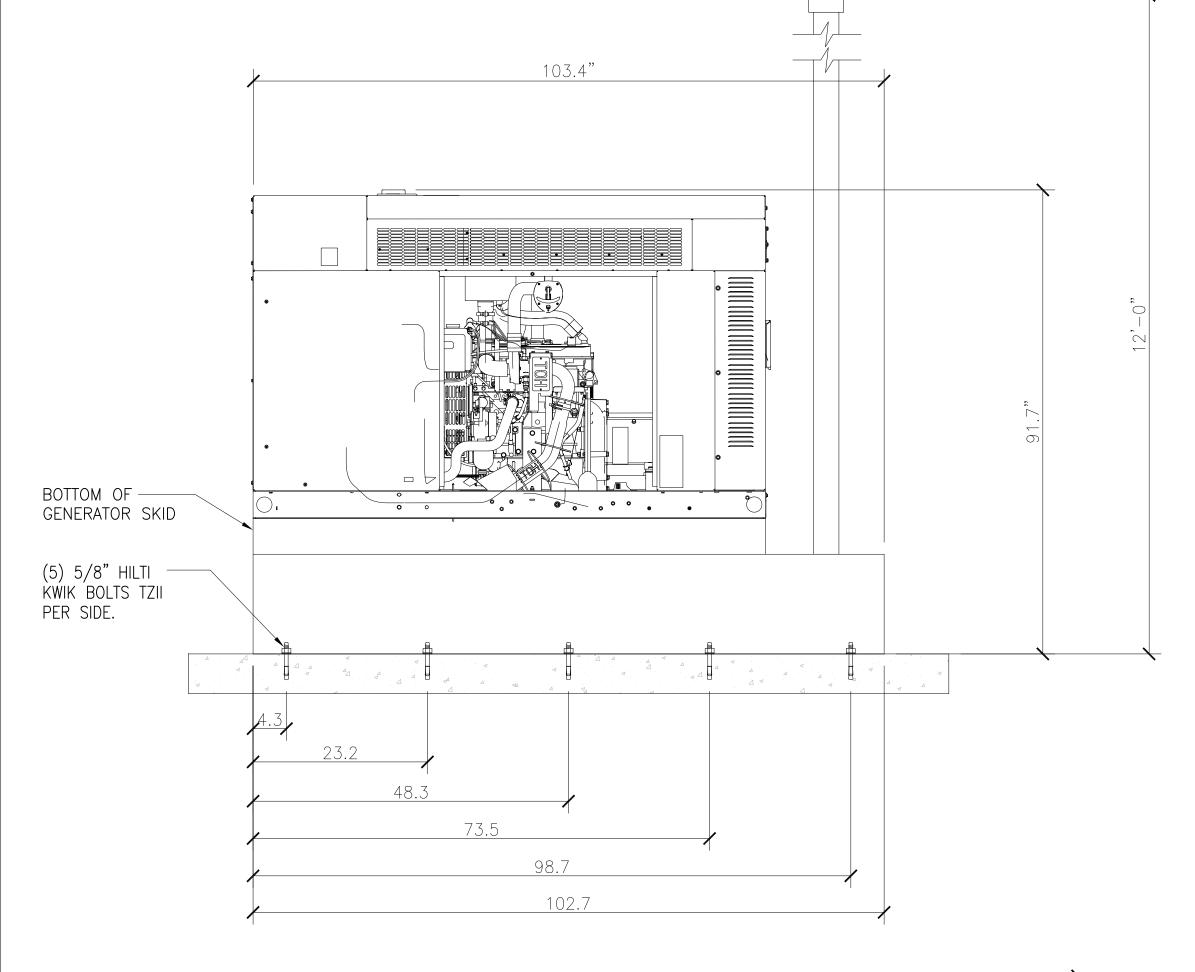

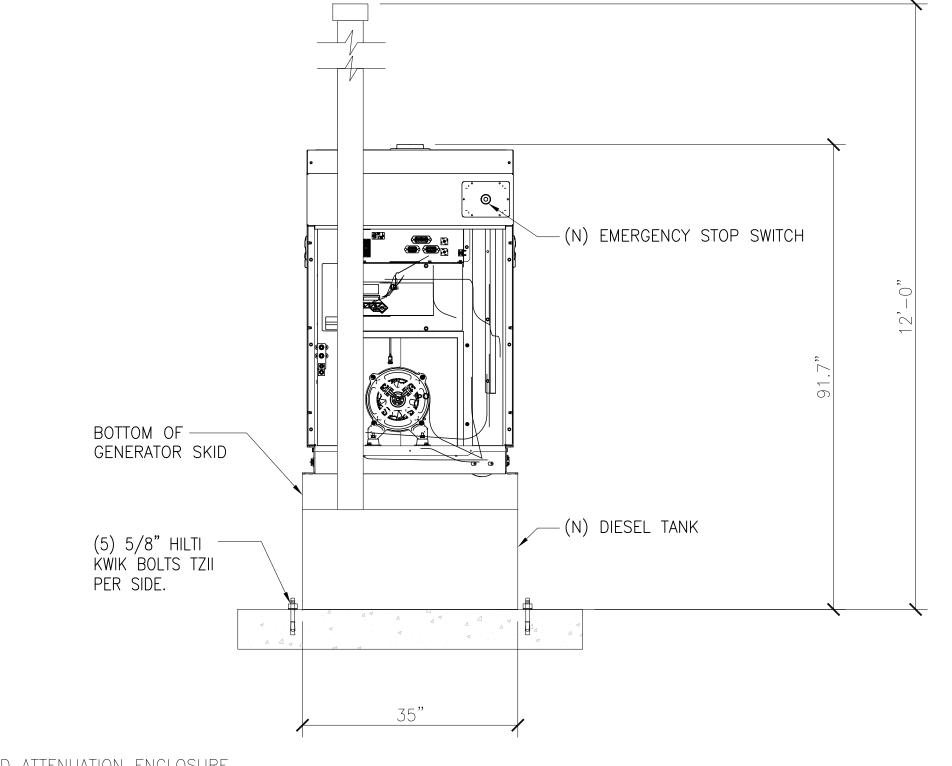

LEVEL 2 SOUND ATTENUATION ENCLOSURE RUN TIME HOURS:

240 USABLE CAPACITY GAL : 103.4 X 35 X 91.7 L X W X H:

WEIGHT lbs (with skid): 2,161 SOUND LEVEL: 65 dBA

3 GENERAC 25KW DIESEL GENERATOR

PREPARED FOR:


1755 CREEKSIDE OAKS DRIVE SUITE 190 SACRAMENTO, CA 95833

CONSULTING FIRM



4340 E. INDIAN SCHOOL RD STE 21. #464 PHOENIX, AZ 85018

PROJECT NO: 0000 DRAWN BY: CHECKED BY:

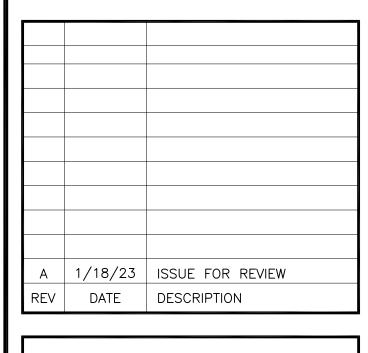

GOSHEN WATER TANK SC70000A


1345 N. AMERICAN STREET VISALIA, CA 93291 **TULARE COUNTY**

> SHEET TITLE DETAILS

SHEET NUMBER

HILTI KWIK BOLT TZII ANCHOR

SCALE: NTS

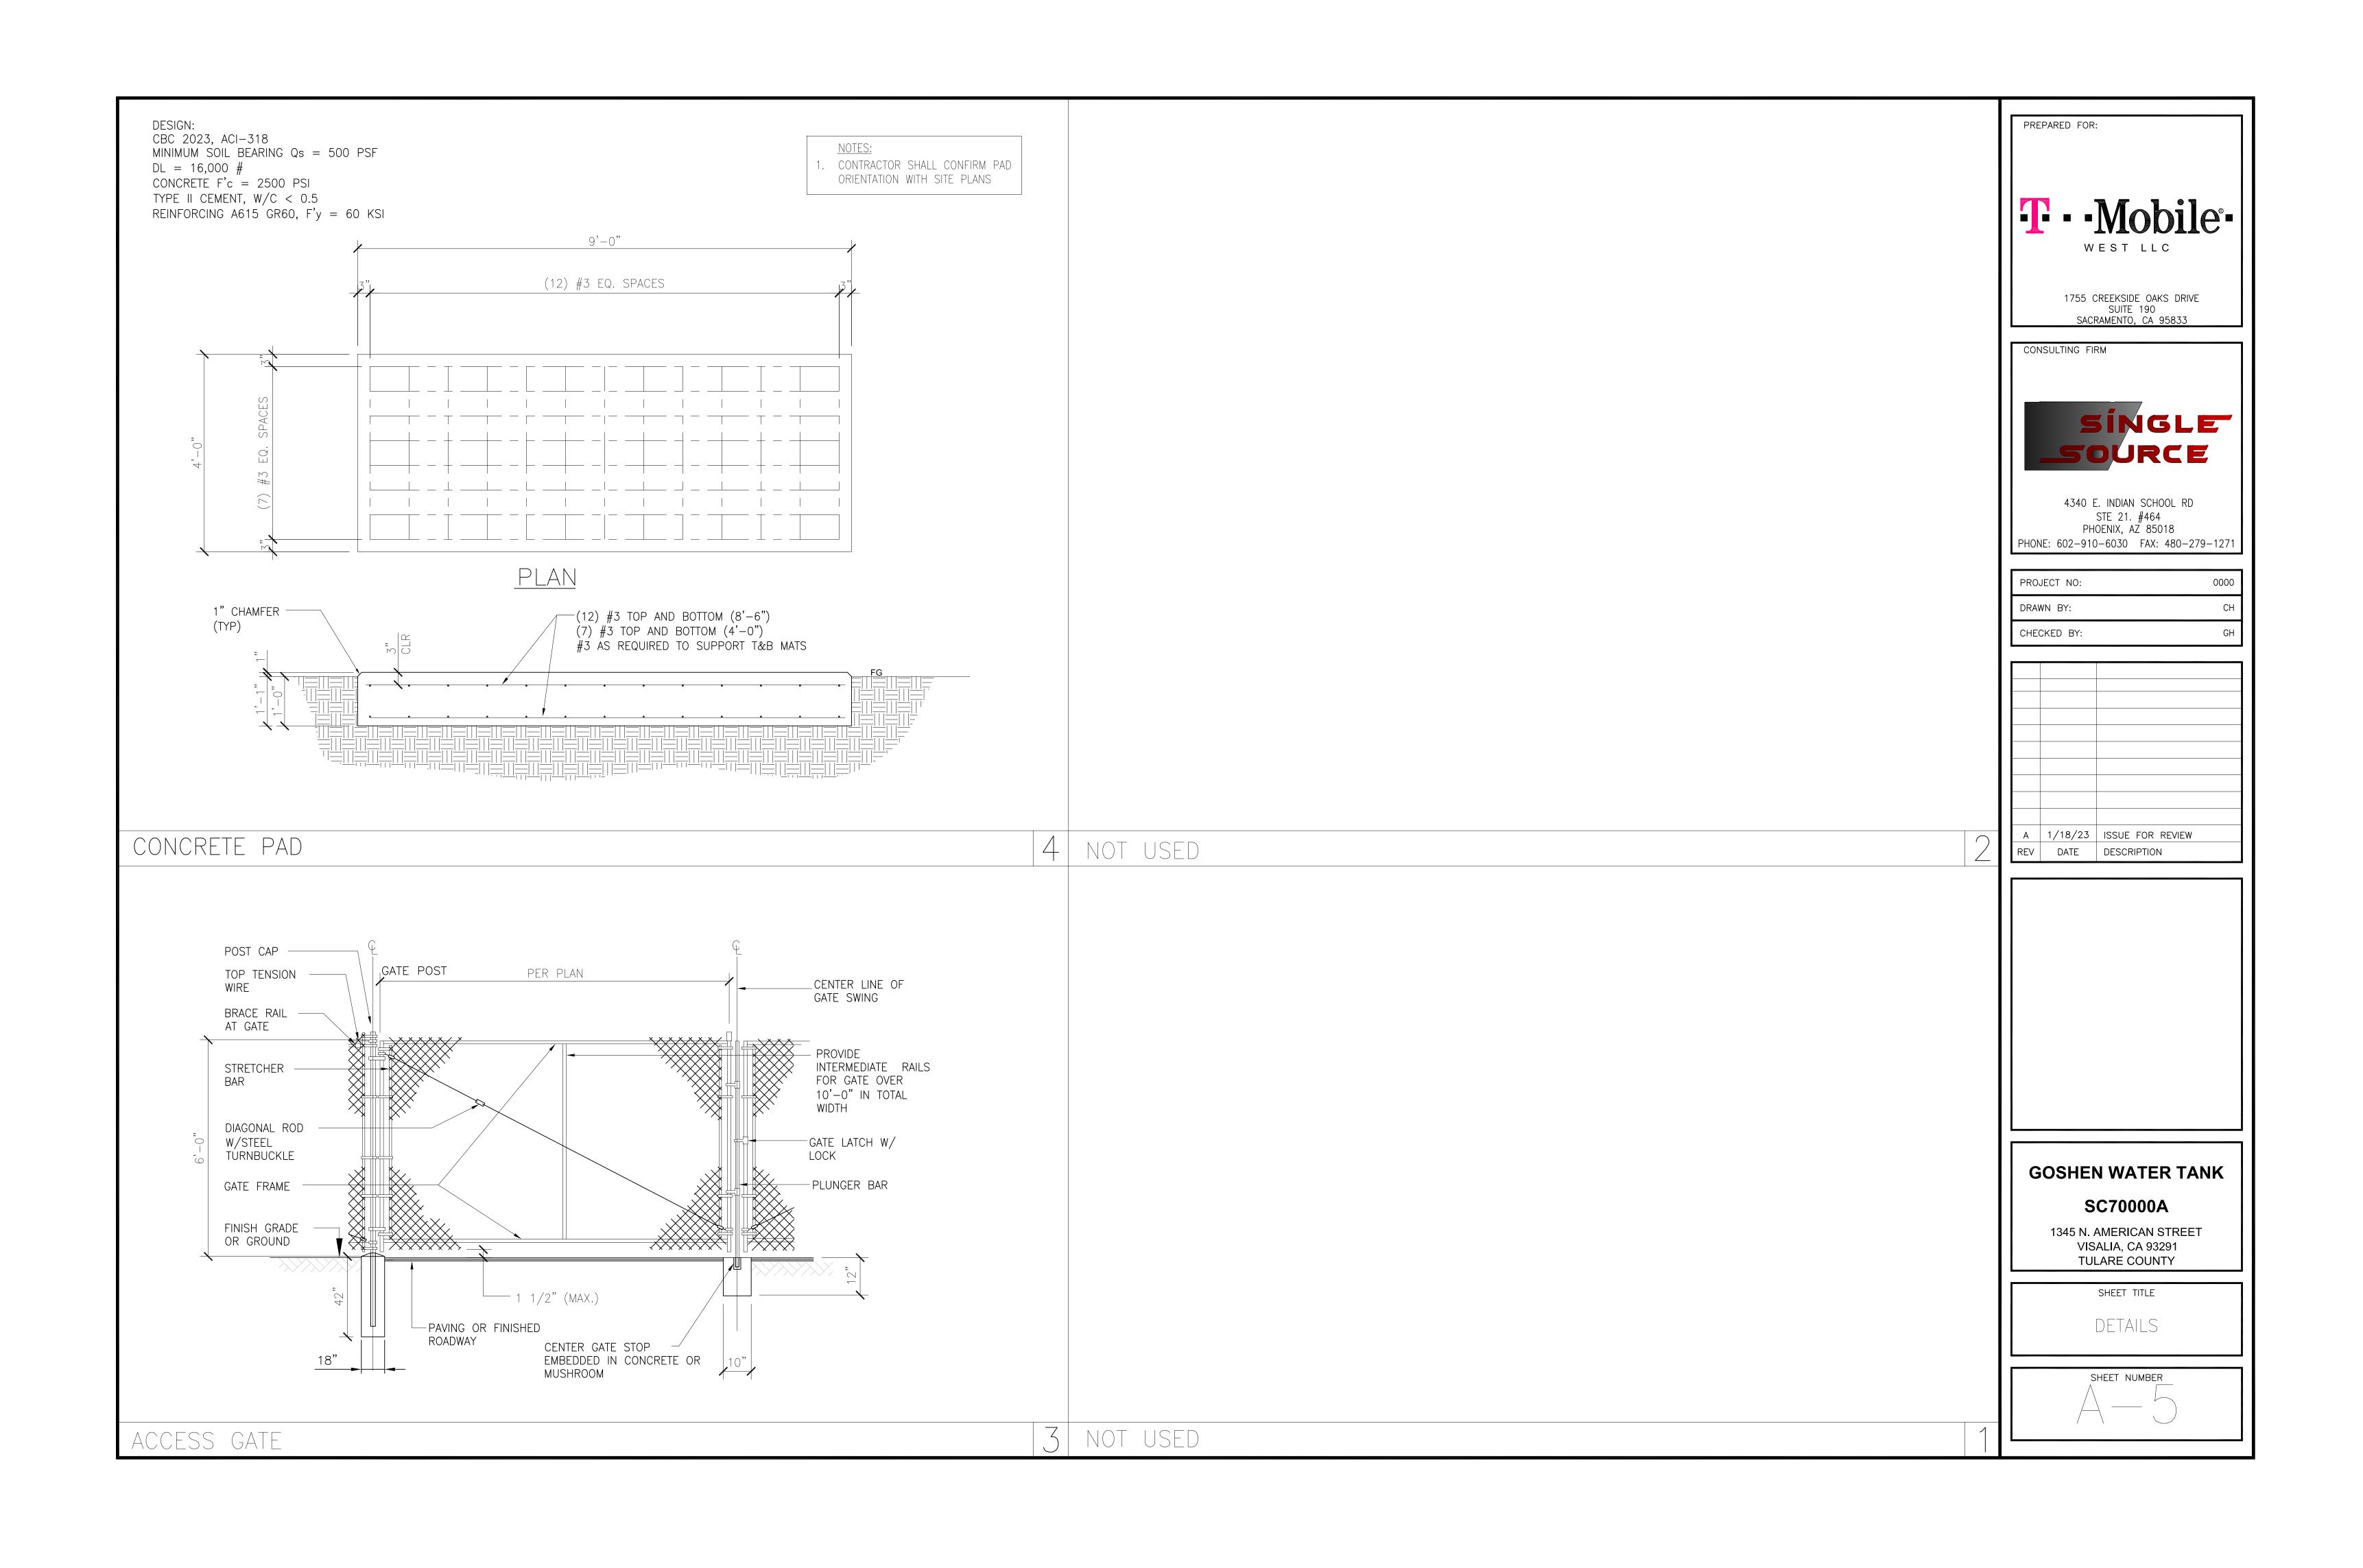

- 1. ALL SIGNS SHALL BE UV-RESISTANT FOR OUTDOOR USE.
- 2. ALL SIGNS SHALL HAVE A MINIMUM 5—YEAR GUARANTEE WITHOUT SHOWING ANY SIGNS OF FADING OR DEGRADATION
- 3. ALL SIGNS SHALL HAVE ROUNDED CORNERS WITH PRE-DRILLED HOLES AND WEATHER PROOF PRESSURE SENSITIVE ADHESIVE BACKING FOR MOUNTING.
- 4. ALL SIGNS SHALL BE PROVIDED PER THEIR SPECIFIC REQUIREMENTS, UNLESS OTHERWISE SPECIFIED DUE TO SIZE RESTRAINTS OR LANDLORD DEMANDS.

GENERAL SIGNAGE NOTES

NO SMOKING OR OPEN FLAMES WITHIN 25 FEET

SIGN REQUIREMENTS:

MATERIAL— 8 1/2"x11" 60MIL THICK WHITE PLASTIC.

COLOR AND LETTERING— PER OSHA 1910.145:

REGULATIONS OF ACCIDENT PREVENTION SIGNS AND TAGS.

MOUNTING — VERIFY MOUNTING LOCATION WITH LOCAL FIRE INSPECTOR

DANGER SIGNAGE


SPECIFICATIONS:

- 1. FONT STYLE USED:

 NUMBERS—HELVETICA BOLD EXTENDED


 LETTERS—HELVETICA BLACK BT
- 2. NUMBERS SHALL BE A MINIMUM OF 3-1/2" HIGH WITH 11/16" STOKE WIDTH
- 3. LETTERING FOR WHITE SPECIAL HAZARD BOX:
 ONE LINE: 1-3/4" HIGH WITH 9/16" STROKE WIDTH
 TWO LINES: 1-3/8" HIGH WITH 7/16" STROKE WIDTH
 THREE LINES: 1-1/4" HIGH WITH 3/8" STROKE WIDTH
- 4. NUMBERS AND LETTERS ARRANGED BY COLOR AS SHOWN ABOVE.
- 5. SIGN SHALL BE POSTED AT LOCATION APPROVED BY THE CITY'S FIRE DEPARTMENT

TANK SIGNAGE SPECIFICATIONS

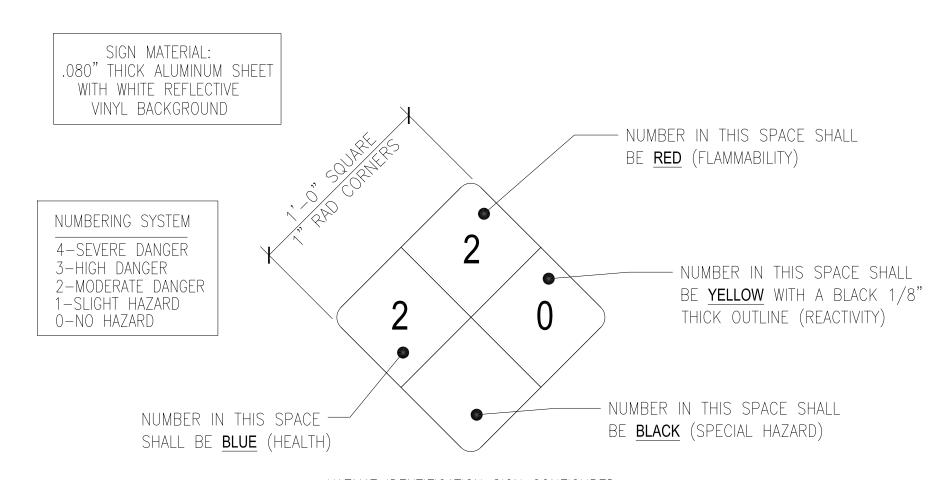

HAZMAT IDENTIFICATION SIGN CONFIGURED
FOR FUEL OIL #1 (GAS 068334-30-5)
(TYPICAL FOR DIESEL GENERATORS)
CONTRACTOR TO PROVIDE SIGN PER T-MOBILE STANDARDS

TANK SIGNAGE

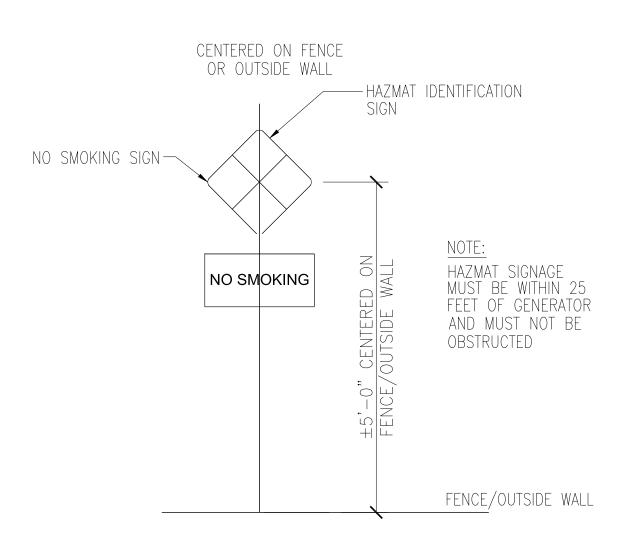

<u>HAZMAT SIGNAGE</u>

PREPARED FOR:

The Modile we still c


1755 CREEKSIDE OAKS DRIVE SUITE 190 SACRAMENTO, CA 95833

CONSULTING FIRM



4340 E. INDIAN SCHOOL RD STE 21. #464 PHOENIX, AZ 85018 PHONE: 602-910-6030 FAX: 480-279-1271

PROJECT NO:	0000
DRAWN BY:	СН
CHECKED BY:	GH

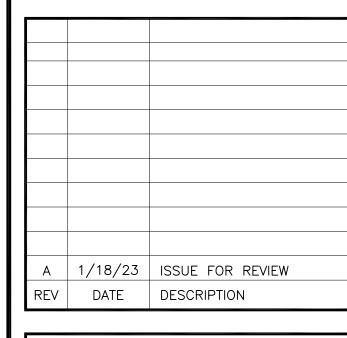


GOSHEN WATER TANK
SC70000A

1345 N. AMERICAN STREET VISALIA, CA 93291 TULARE COUNTY


SHEET TITLE

GENERATOR


SIGNAGE

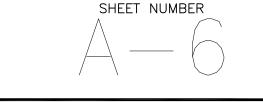


GENERATOR SIGNAGE

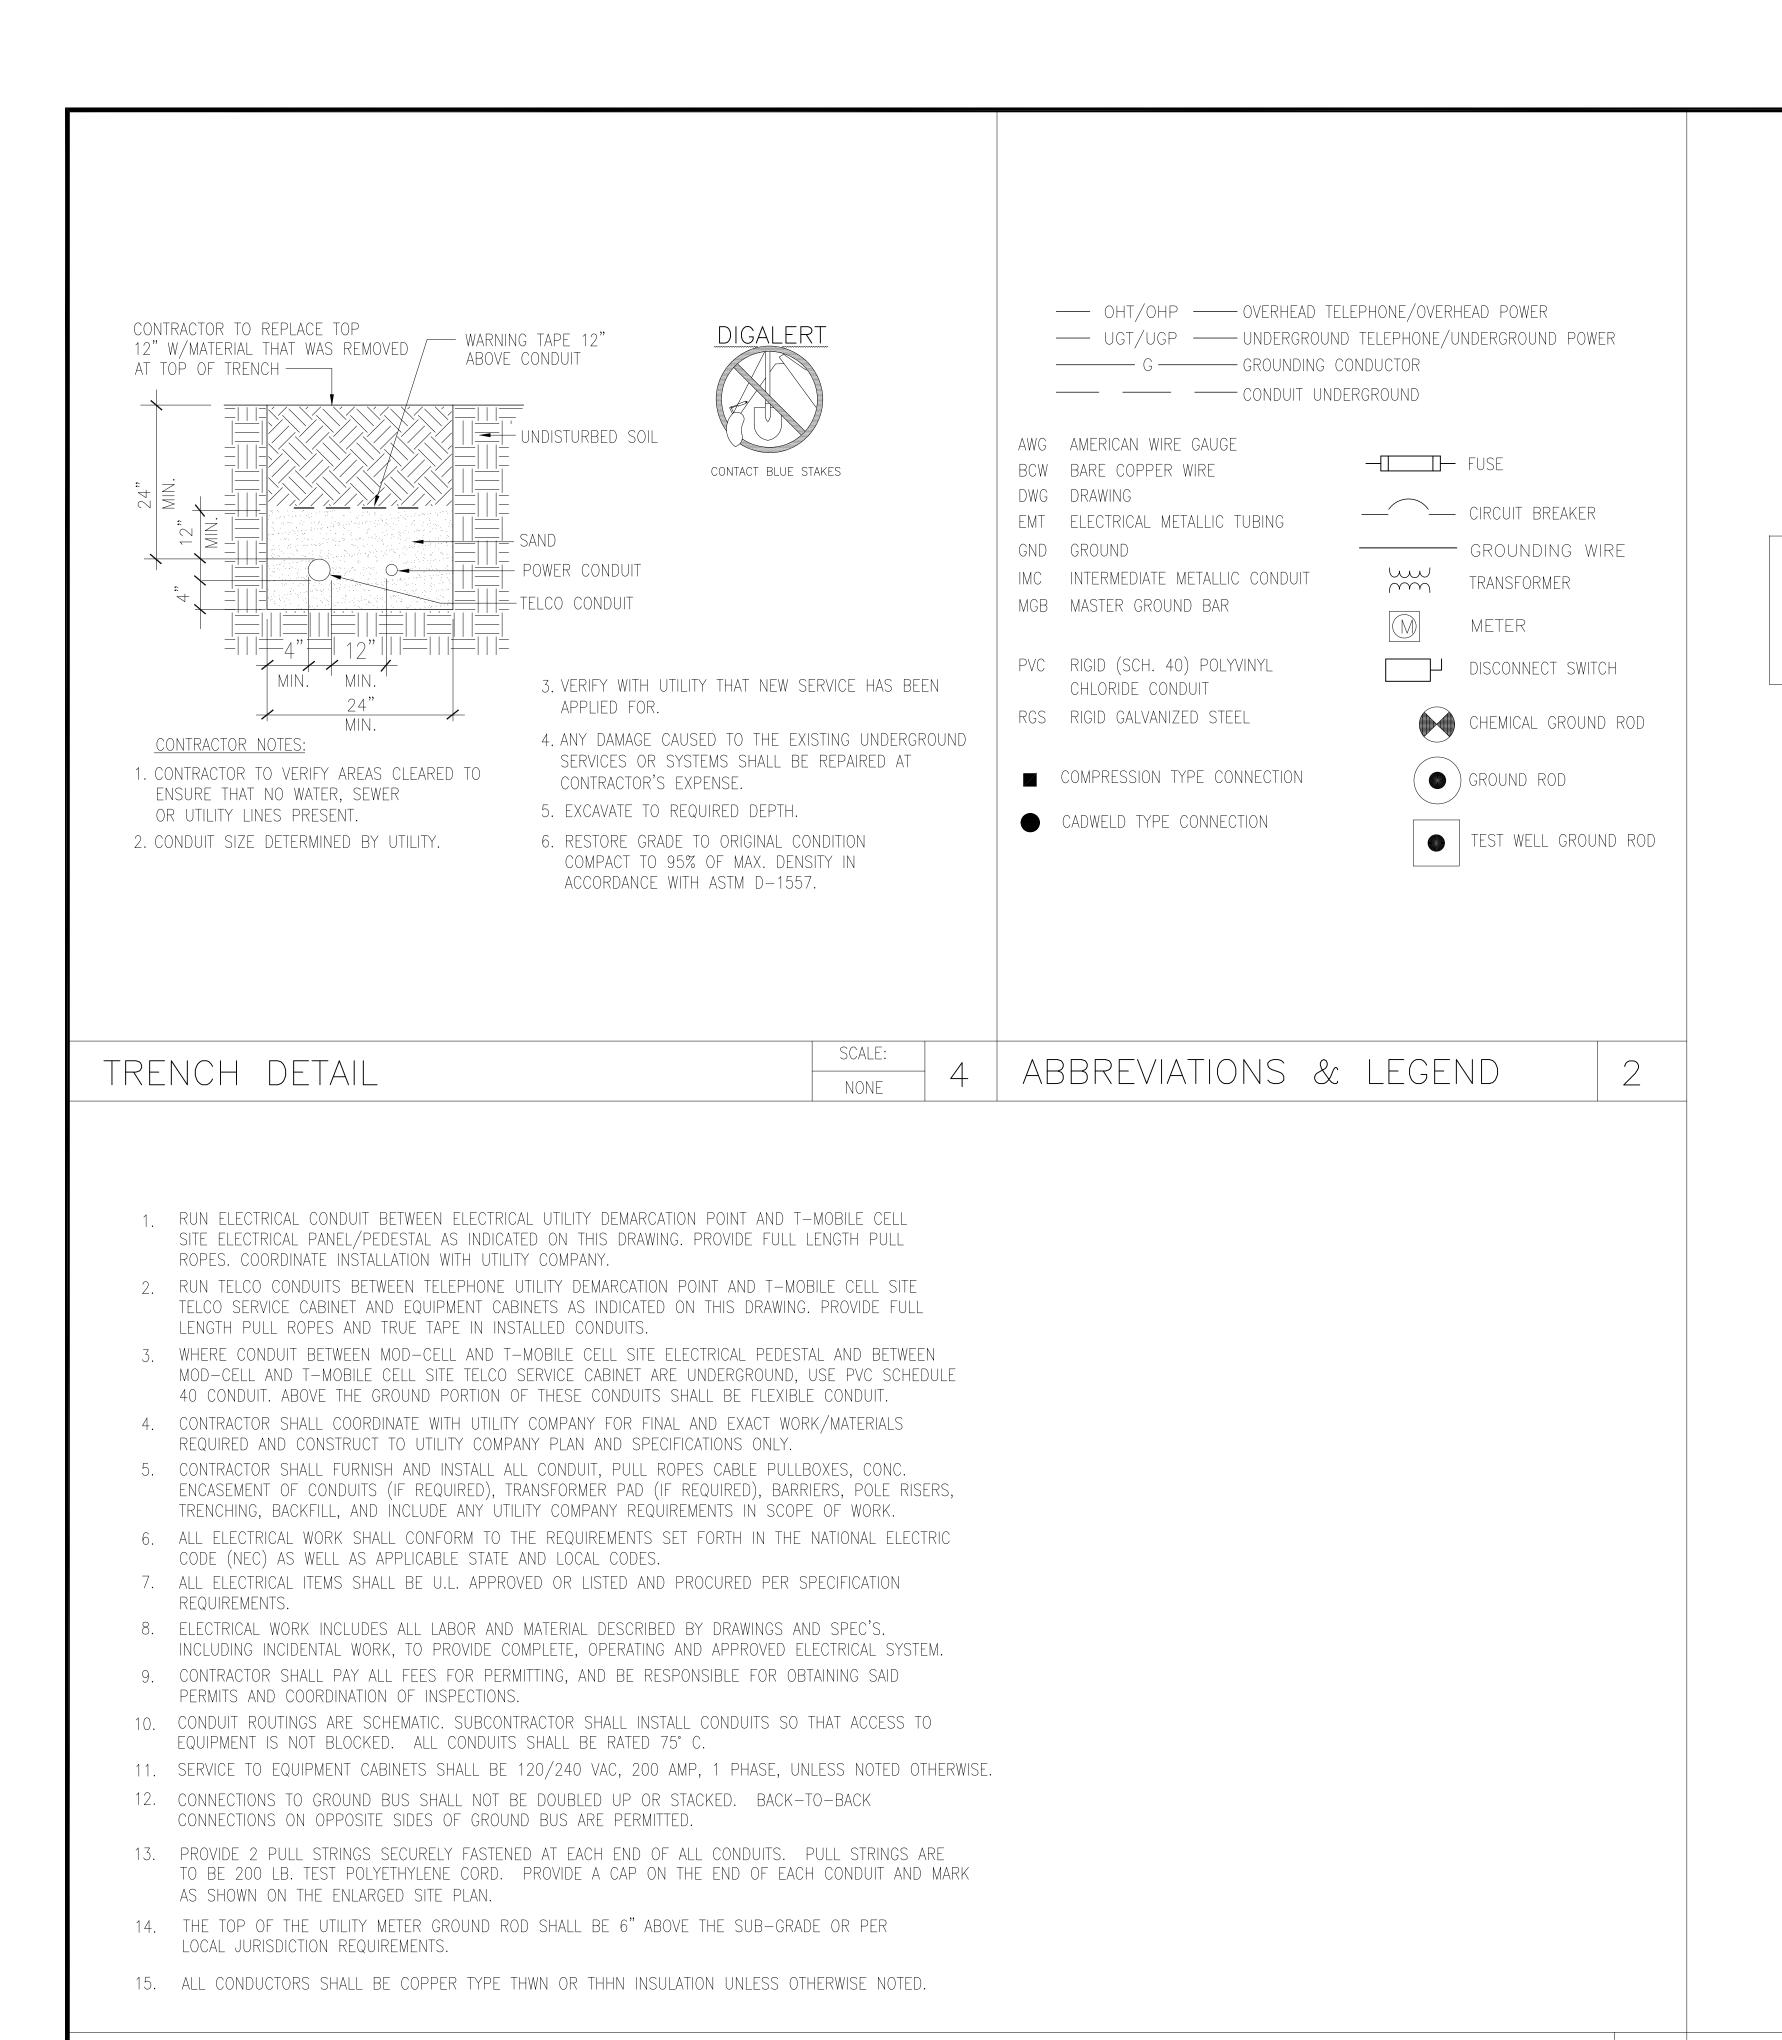

NOTE:
GC TO VERIFY STUB UP LOCATIONS
WITH GENERATOR SPECS. IF USING
EXISTING SLAB GC TO LB INTO
GENERATOR FOR ALL WIRING
CONNECTIONS.

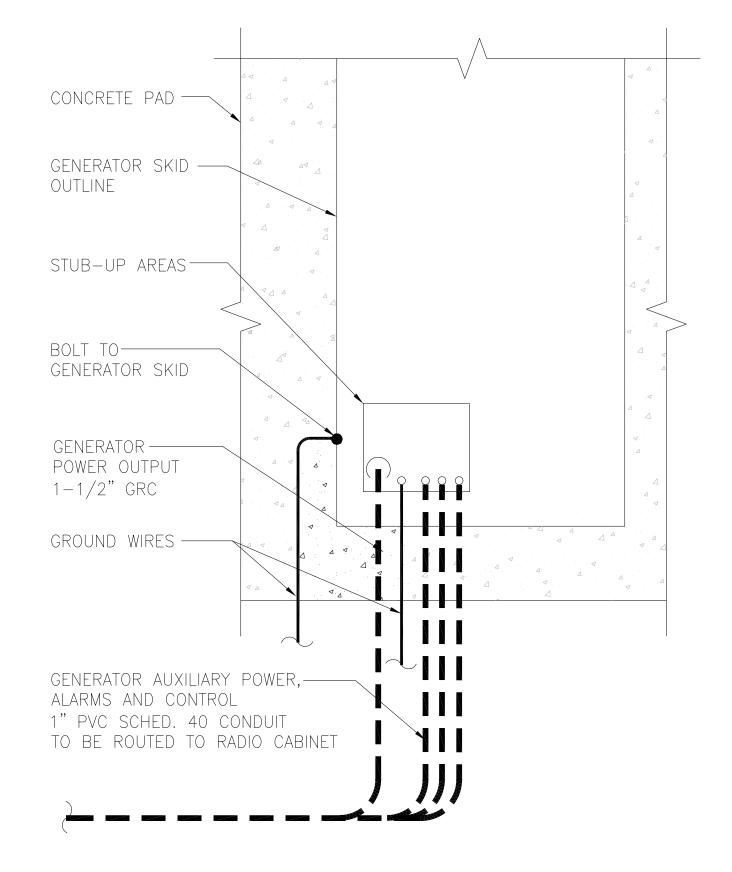

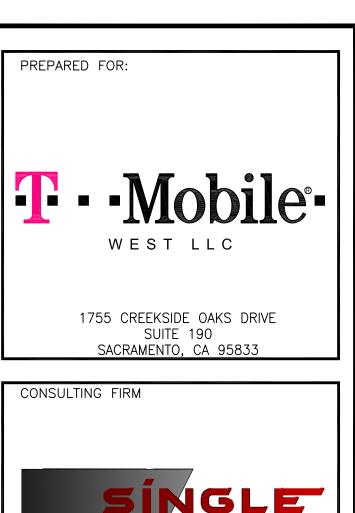

STAGLE

4340 E. INDIAN SCHOOL RD

STE 21. #464


PHOENIX, AZ 85018

PHONE: 602–910–6030 FAX: 480–279–1271

PROJECT NO: 0000

	PROJECT NO:	0000
	DRAWN BY:	СН
	CHECKED BY:	GH

Α	1/18/23	ISSUE FOR REVIEW
REV	DATE	DESCRIPTION

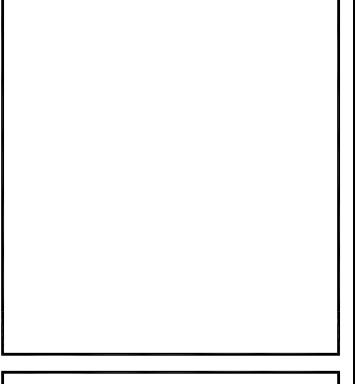

GOSHEN WATER TANK

SC70000A

1345 N. AMERICAN STREET VISALIA, CA 93291 TULARE COUNTY


SHEET TITLE
ELECTRICAL
DETAILS

SHEET NUMBER


CONDUIT ENTRY FOR GENERATOR INSTALLATIONS

NOTES:

- 1. SUBCONTRACTOR SHALL FIELD VERIFY, WITHIN THE SCOPE OF WORK, THAT ALL EXISTING CONDUITS, CONDUCTORS, CONDUIT STUB-UPS, AND ELECTRICAL EQUIPMENT/RATINGS ARE INSTALLED PER NEC AND LOCAL AUTHORITIES HAVING JURISDICTION.
- 2. FOR COMPLETE INTERNAL WIRING AND ARRANGEMENT REFER TO DRAWINGS PROVIDED BY EQUIPMENT MANUFACTURERS.
- 3. PROVIDE SIGNS AT SERVICE ENTRANCE EQUIPMENT AS REQUIRED BY NEC ARTICLE 702.8 INDICATING SITE HAS ON-SITE AUTOMATIC START STANDBY GENERATOR.
- 4. THIS SITE IS NOT REQUIRED BY A DETERMINING AGENCY TO BE A LEGALLY REQUIRED SYSTEM.
- 5. THE PROPOSED STANDBY GENERATOR IS <u>NOT</u> A SEPARATELY—DERIVED POWER SYSTEM.
- 6. THE GENERATOR SIZE HAS BEEN SPECIFIED BY THE CLIENT. THE CLIENT SHALL BE SOLELY RESPONSIBLE FOR ASSURING THAT THE LOAD APPLIED TO THE GENERATOR IS WITHIN THE GENERATOR'S RATING.
- 7. THE CONTRACTOR SHALL VERIFY THE AVAILABLE FAULT CURRENT WITH THE SERVING UTILITY AND SHALL USE THAT DATA TO CALCULATE THE AVAILABLE FAULT CURRENT AT THE AUTOMATIC TRANSFER SWITCH. THE AUTOMATING TRANSFER SWITCH SHALL BE SUITABLE FOR USE AT THE CALCULATED FAULT CURRENT.

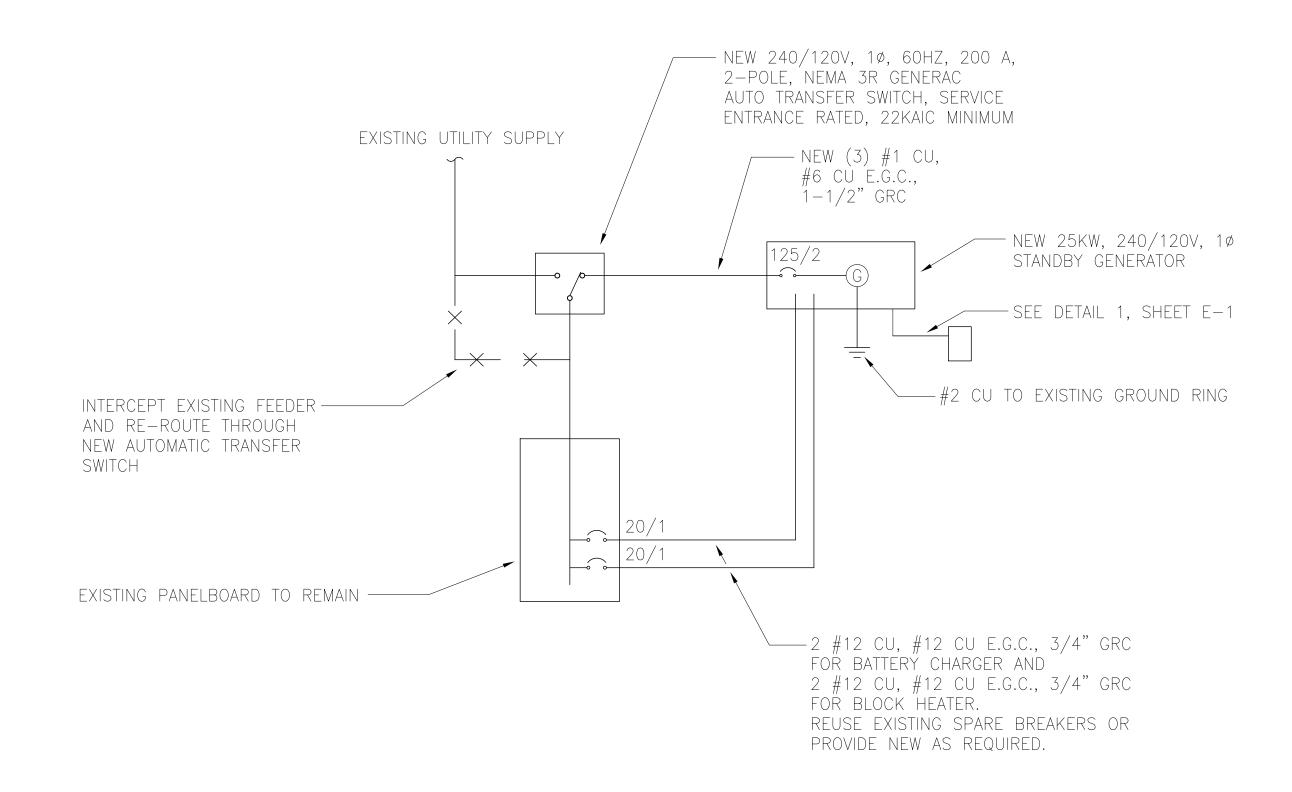

STANDBY GENERATOR SINGLE-LINE DIAGRAM

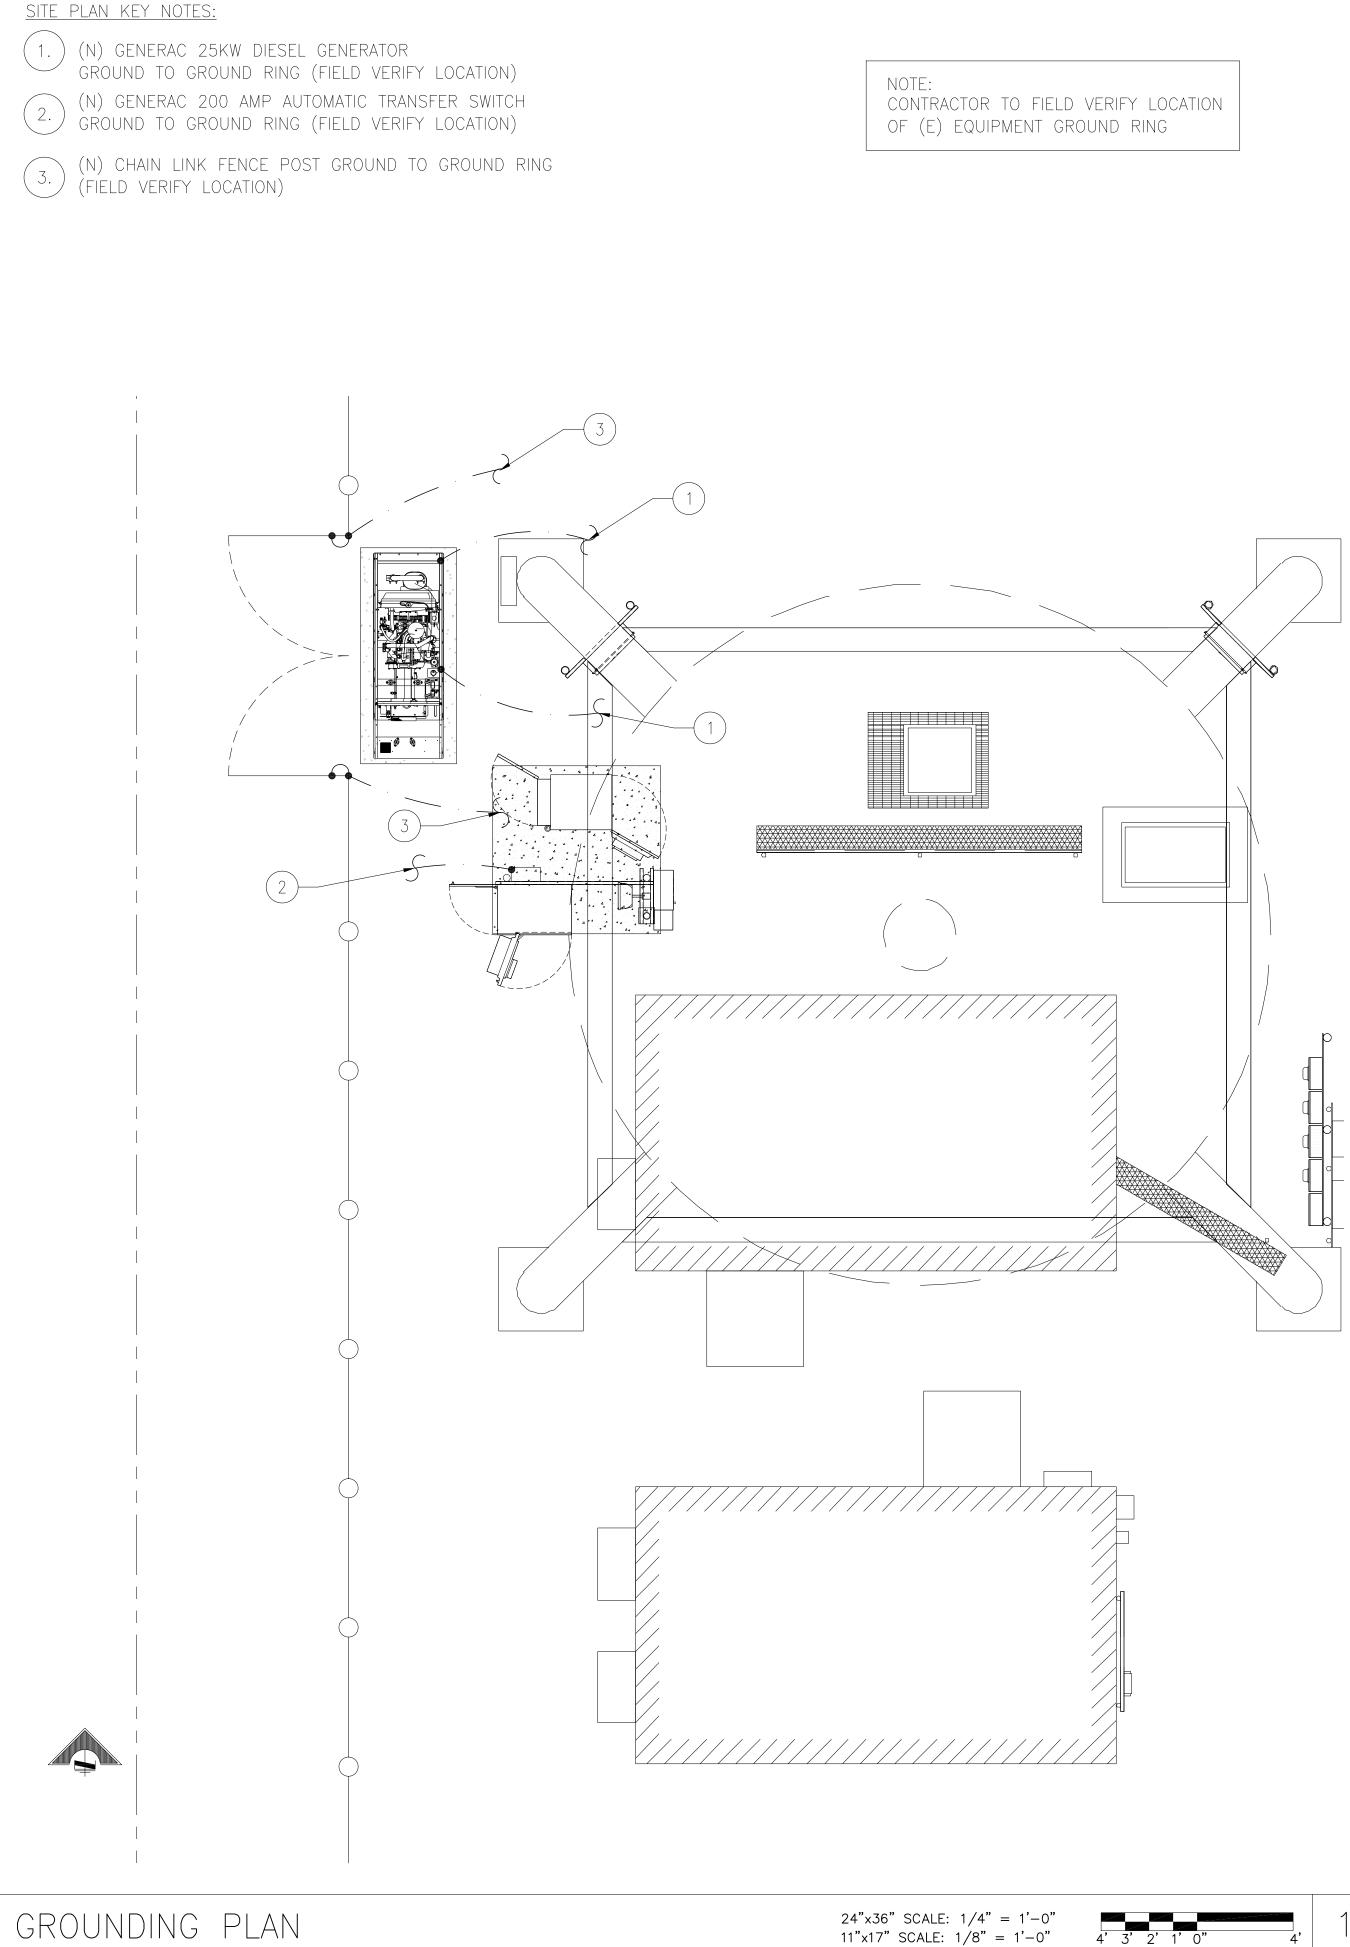

PREPARED FOR:

1755 CREEKSIDE OAKS DRIVE SUITE 190 SACRAMENTO, CA 95833

CONSULTING FIRM



4340 E. INDIAN SCHOOL RD STE 21. #464 PHOENIX, AZ 85018 PHONE: 602-910-6030 FAX: 480-279-1271

PROJECT NO: 0000 DRAWN BY: CHECKED BY:

A 1/18/23 ISSUE FOR REVIEW REV DATE DESCRIPTION

GOSHEN WATER TANK


SC70000A

1345 N. AMERICAN STREET VISALIA, CA 93291 TULARE COUNTY

SHEET TITLE

GROUNDING DETAILS

SHEET NUMBER

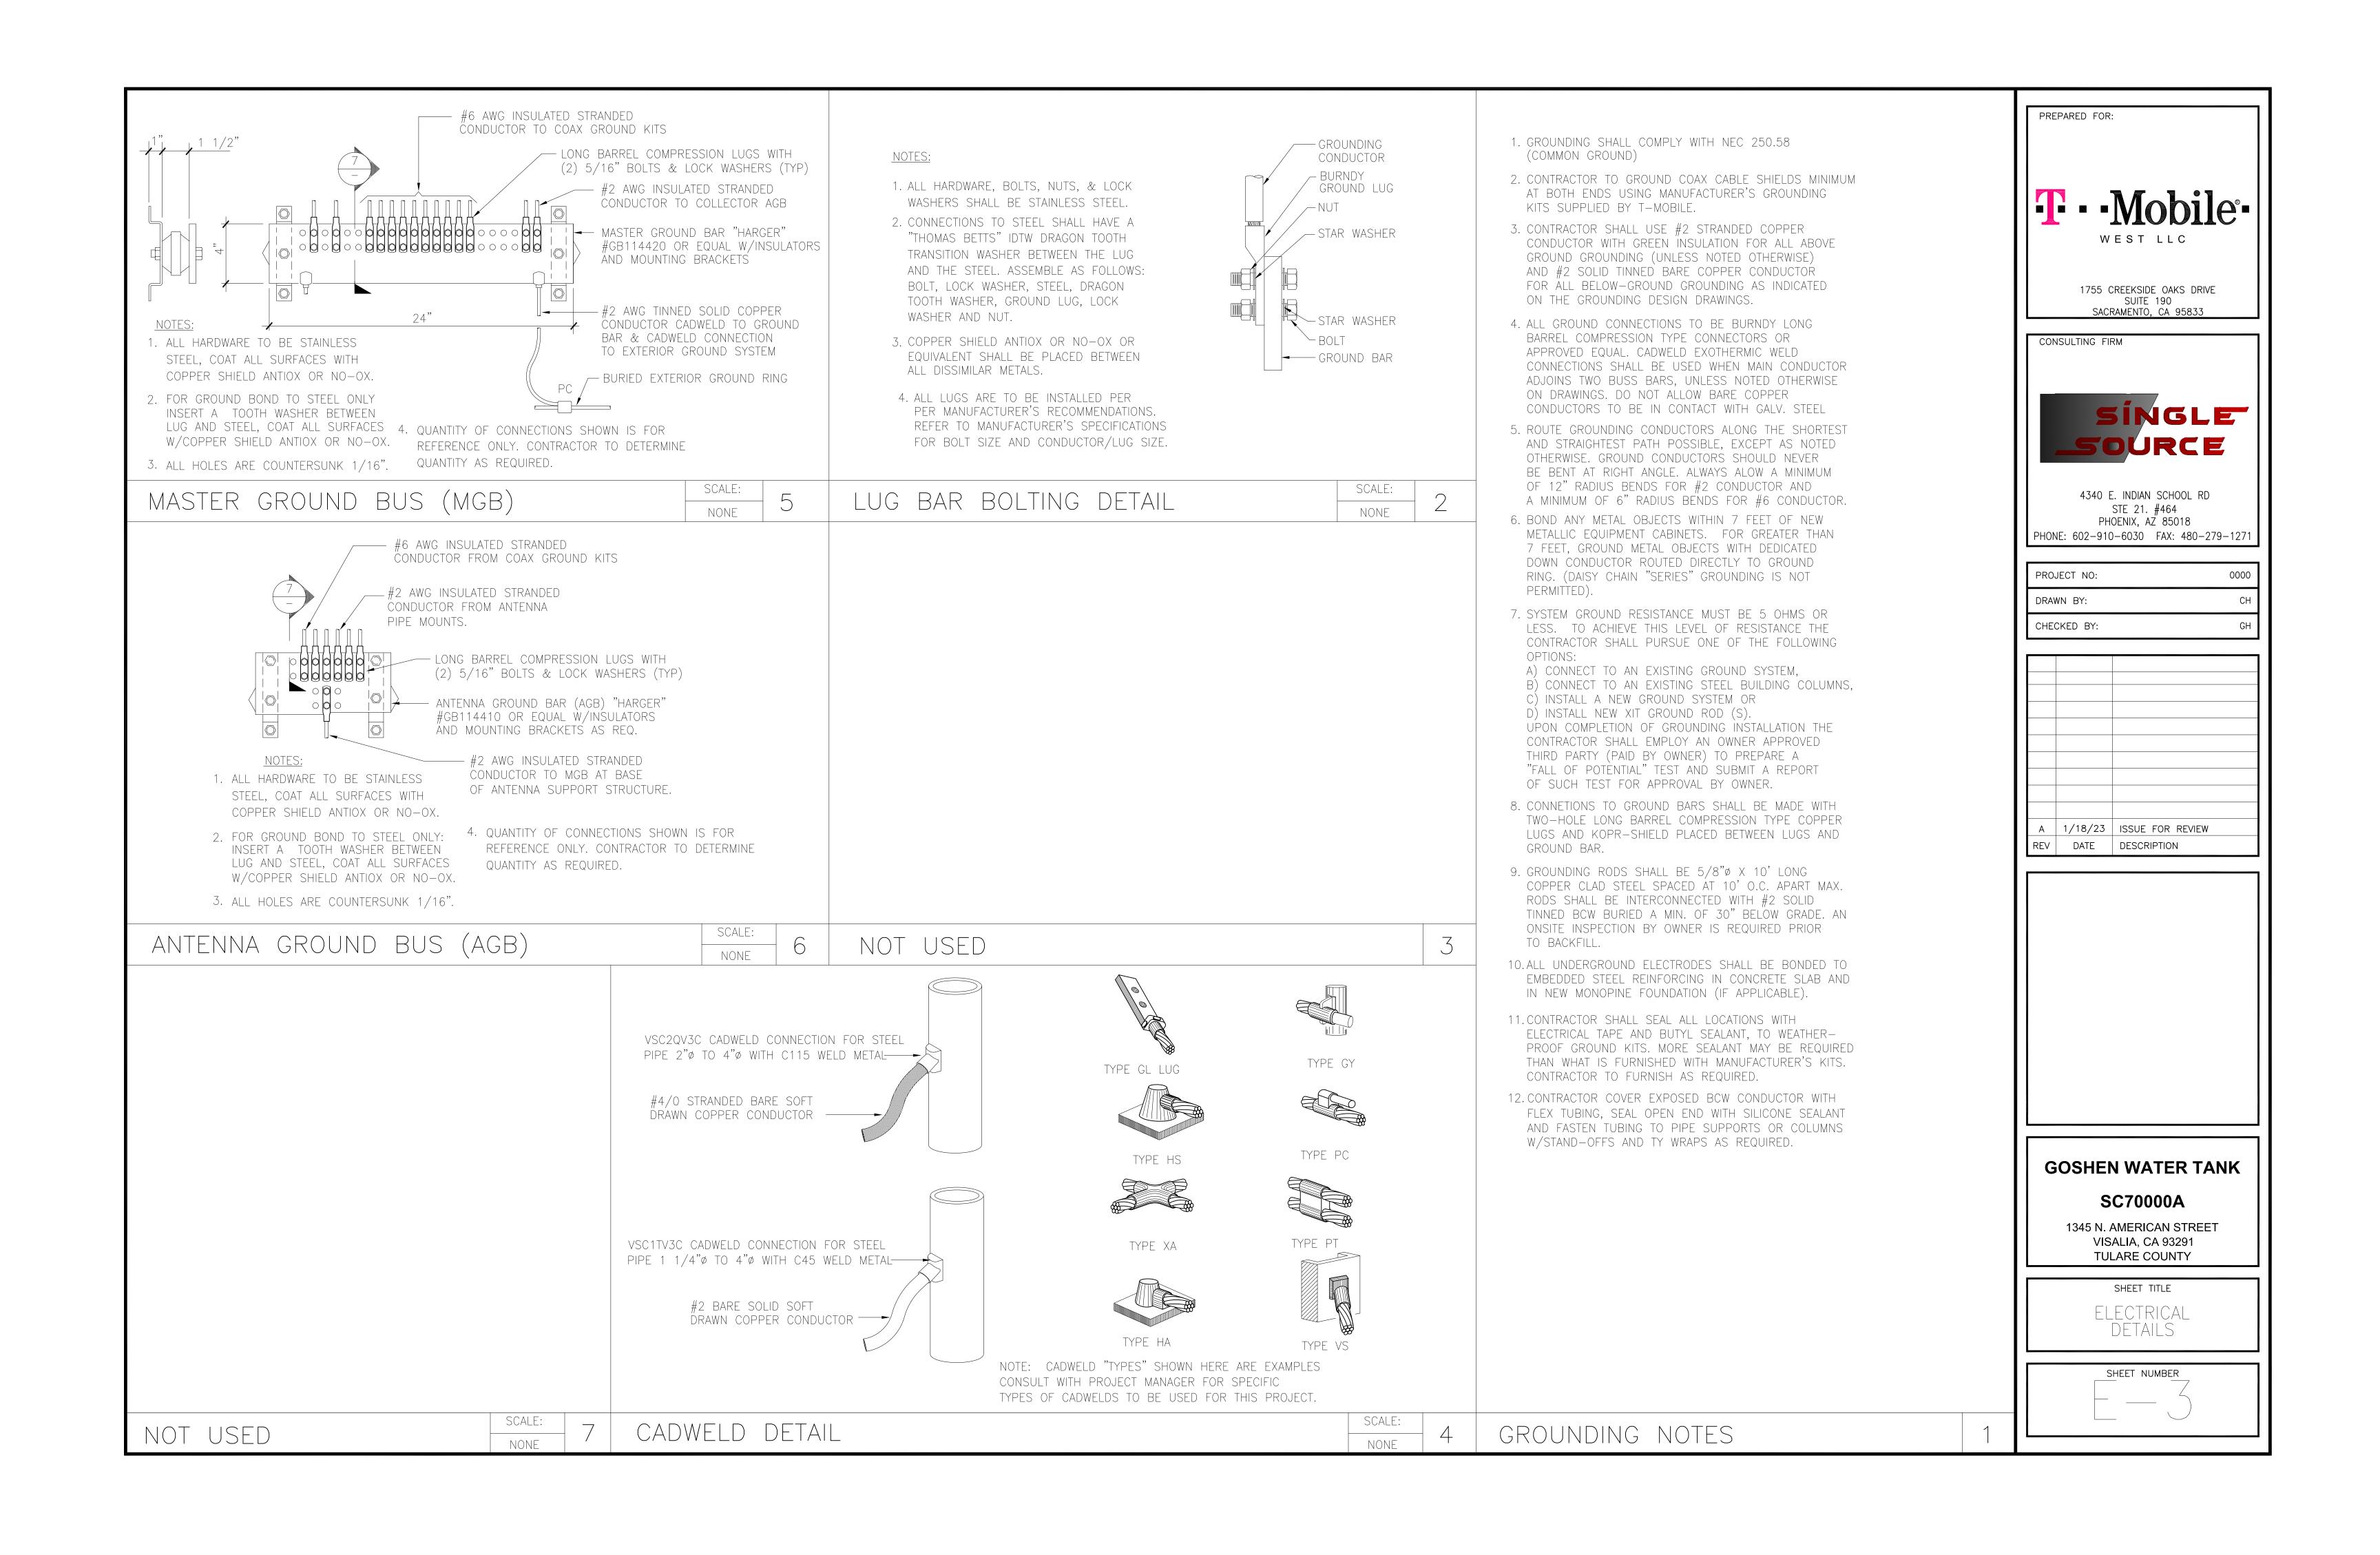

CITY OF VISALIA SITE PLAN REVIEW APPLICATION

Additional information and assistance in filling out this application can be found at the City of Visalia website (www.visalia.city) or by calling (559) 713-4440.



∞

This application MUST be filled out in its entirety and submitted with an acceptable site plan (see site plan minimum requirements & submittal details on Page 2). Failure to provide all requested information may result in rejection of your application and exclusion from the Site Plan Review agenda.

Site Plan Review meetings are held on Wednesdays at 9:00 a.m. online utilizing Microsoft Teams. The applicant or representative must be present.

Application submittal deadline are Thursday at 4:00 p.m. to be scheduled for the next available meeting. 02-08-2023 Maiestic Inn Renovation Project Project/Business Name: Project Description: Renovation of the existing Majestic Inn and Managers Residence/Office buildings into affordable housing units with Managers Residence/Office.) No (Site Plan Review Resubmittal: Yes (If Resubmittal, Previous Site Plan Review Number: Property Owner: **RH Community Builders** Applicant(s) Name: Machael Smith Project Address/Location: 4545 W. Noble Avenue, Visalia, CA Assessor Parcel Number: Building 1: 1,350 sf 0 8 7 - 3 3 0 - 0 4 0 Building 2: 6,230 sf 14,303 SF Parcel Size (Acreage or Square Feet): Building or Suite Square Footage: Building 3: 6,723 sf 1.60 acres --- THIS AREA FOR CITY STAFF USE ONLY ---Are There Any Proposed Building Modifications: Date Received: 02/08/2023 Estimated Cost of Modifications to Building: \$ 7 Million SPR Agenda: 02/15/2023 Item No. Describe All Proposed Building Modifications: Site: Re-seal/stripe parking lot; replace fencing/gates, landscaping, and exterior lighting; provide ADA SPR No. 23-024 Zone: C-R upgrades, signage and trash enclosure; remove existing swimming pool. Building Exteriors: Replace doors, windows, roofing, stair railings; repair stucco, trim/fascia, soffits; remove existing balcony separations; paint. No Historic District: Yes () Building Interiors: Set aside a percentage of units to be ADA-compliant; provide kitchenettes in each unit; replace doors, flooring, HVAC, electrical, insulation, lighting, millwork, drywall and plumbing fixtures; paint. AE (X) X/AE (Flood Zone: -- A SEPARATE, DETAILED OPERATIONAL STATEMENT IS HIGHLY RECOMMENDED FOR ALL SUBMITTALS --41-Unit Motel complex with 1 bed/1 bath Manager's Unit (originally building in 1962) Existing/Prior Building Use: Proposed Building Use: Affordable Housing, Multi-Family Monday - Friday, 8 AM - 5 PM (Case Management & Property Management); Weekends/Afterhours: On-Call Proposed Hours of Operation: Days of Week In Operation (Circle): \subset Su M Т W Th F Sa Live-In Staff: 1 Number of Employees Per Day: Existing Proposed Employees: 3-6 Number of Customers Per Day (Estimated): Existing Proposed Approximately 45 tenants N/A Predicted Peak Operating Hour: Describe Any Truck Delivery Schedule & Operations: N/A Please Identify Any Unique or Specific Traffic Patterns That Will Require Accommodations For Operations, Customers, or Employees (Provide Separate Attachment if Necessary):

Page 1 of 2 - Application continues on back of this page

N/A

Describe Any Special Events Planned for the Facility:

		SITE PLAN MINIMUM REQUIREMENTS	
	⇒ Submit a digital copy of the site plan(s) and com		(PDF format preferred, hard paper copies
TS	not accepted).	,,,	
SITE PLAN REQUIREMENTS	⇒ Digital copies must be clear, legible, and on a la	yout sized appropriately to convey all necessary	project information.
QUII	⇒ Site plan shall provide for and indicate all of the	following:	
N RE	- North arrow	- Existing & proposed structures -	Loading/unloading areas
PLA	- All existing & proposed site features	- Adjacent street names -	Accessible path of travel from right of way
SITE	 Site dimensions, including building Existing and proposed fencing at site 	Refuse enclosures & containersValley oak trees (show drip line)	Accessible path of travel from ADA stall Location and width of drive approaches to site
	- Public improvements (curbs, sidewalks,	- Existing & proposed landscaping -	Tentative maps shall adhere to requirements
	utility poles, hydrants, street lights, etc.)	- Parking stalls (include ADA)	of Visalia Municipal Code Section 16
	Applicant Information (Final comments will be maile	d to the name and address provided below)	
JRE	Name: Machael Smith	Signature of Owner or Authorized A	gent*
NATL	Address: 3040 N. Fresno Street		
SIG	City, State, Zip Fresno, CA 93703	Owrier	Date
IIRED	Phone: (559) 492-1373	Way May	2-9-23
REQUIRED SIGNATURE	Email: machael@rhcbfresno.com	Authorized Age/nt*	Date
	* If signed by an authorized agent , the "Agency Authori	zation" information below must be completed for thi	s application to be considered acceptable.
		AGENCY AUTHORIZATION	
		AGENOT AGTITORIZATION	
	OWNER:		
	NA 1 10 11		
	I, Machael Smith	, declare as follows; I am the owner of certa	ain real property bearing assessor's
	I, Machael Smith parcel number (APN):		ain real property bearing assessor's
	1,	, declare as follows; I am the owner of certa	ain real property bearing assessor's 040
	parcel number (APN):		
	parcel number (APN): 087 AGENT:	330	
JRM	parcel number (APN): 087 AGENT: I designate Wayne Rutledge an application for, and obtain a permit tothe		040
	parcel number (APN): 087 AGENT: I designate Wayne Rutledge		040
	parcel number (APN): 087 AGENT: I designate Wayne Rutledge an application for, and obtain a permit tothe	, to act as my duly authorized age Majestic Inn Renovation Project	040
	parcel number (APN):	, to act as my duly authorized age Majestic Inn Renovation Project is true and correct.	040
	parcel number (APN):	, to act as my duly authorized age Majestic Inn Renovation Project is true and correct.	040
	parcel number (APN):	, to act as my duly authorized age Majestic Inn Renovation Project is true and correct.	040
AGENCY AUTHORIZATION FORM	parcel number (APN):	, to act as my duly authorized age Majestic Inn Renovation Project is true and correct. February, 20_23	ent for all purposes necessary to file
	parcel number (APN):	, to act as my duly authorized age Majestic Inn Renovation Project is true and correct. February, 20_23 Signatures	ent for all purposes necessary to file
	parcel number (APN):		ent for all purposes necessary to file AGENT
	parcel number (APN):		ant for all purposes necessary to file AGENT Ave. Ste 110
	parcel number (APN):		ant for all purposes necessary to file AGENT Ave. Ste 110
	parcel number (APN):		ant for all purposes necessary to file AGENT Ave. Ste 110
	parcel number (APN):		ant for all purposes necessary to file AGENT Ave. Ste 110
	parcel number (APN):		ant for all purposes necessary to file AGENT Ave. Ste 110

RH Community Builders (RHCB) is sponsoring the Majestic Inn, a proposed rehabilitation of an existing 42-unit motel, originally built in1962, converting to permanent supportive housing targeting chronically homeless between 0-30% of AMI. The project site is located at 4545 W. Noble Avenue, Visalia, California, 93277, census tract 20.08. Financing for the project includes Homekey, HOME, Successor, HHIP, and HHAP funds.


RHCB will provide onsite Housing Transition and Tenancy/Sustaining Services. Guided by Housing First principles and best-practices, RHCB will work with tenants to develop a housing support plan during an intake session at the initiation of their lease. All support plans will be customized to fit their needs, with the ultimate goal of ensuring housing stability. Services will not be a condition of tenancy, but will be highly encouraged.

In addition to Community Supports, RHCB will provide Enhanced Care Management (ECM) services to residents of the Majestic. ECM services include high-touch, community based, in person care management and case coordination. Services will include coordination of acute, behavioral, oral, and long-term services for clients. RH Community Builders will provide individualized care, using a trauma informed approach and motivational interviewing, to encourage engagement.

Existing Use	Motel
	Affordable Housing, Multi-Family for people
Proposed Use	experiencing homelessness at or below 30% AMI
	M-F, 8-5 PM - Case management, Property
	management
Business Hours	Weekends/Afterhours – On call
Live-in Staff	Property manager or maintenance
Number of Employees	3-6
Number of Tenants	Approx. 45

The project will pursue Homekey funding and, if awarded, will be exempt from CEQA pursuant to AB 83¹ (2020). In addition to the CEQA exemption, AB 83 provides significant land-use streamlining for projects utilizing Homekey funds. This land use "exemption" is independent of the CEQA exemption and applies to all Homekey funded projects. All Homekey projects are eligible for such streamlining and are "deemed consistent and in conformity with any applicable local plan, standard, or requirement, and allowed as a permitted use, within the zone in which the structure is located, and shall not be subject to a conditional use permit, discretionary permit, or to any other discretionary reviews or approvals." (Health & Saf. Code, § 50675.1.1, subd. (g).)

¹ https://www.hcd.ca.gov/grants-funding/active-funding/homekey/docs/qa-homekey-ceqa-exemption-final.pdf

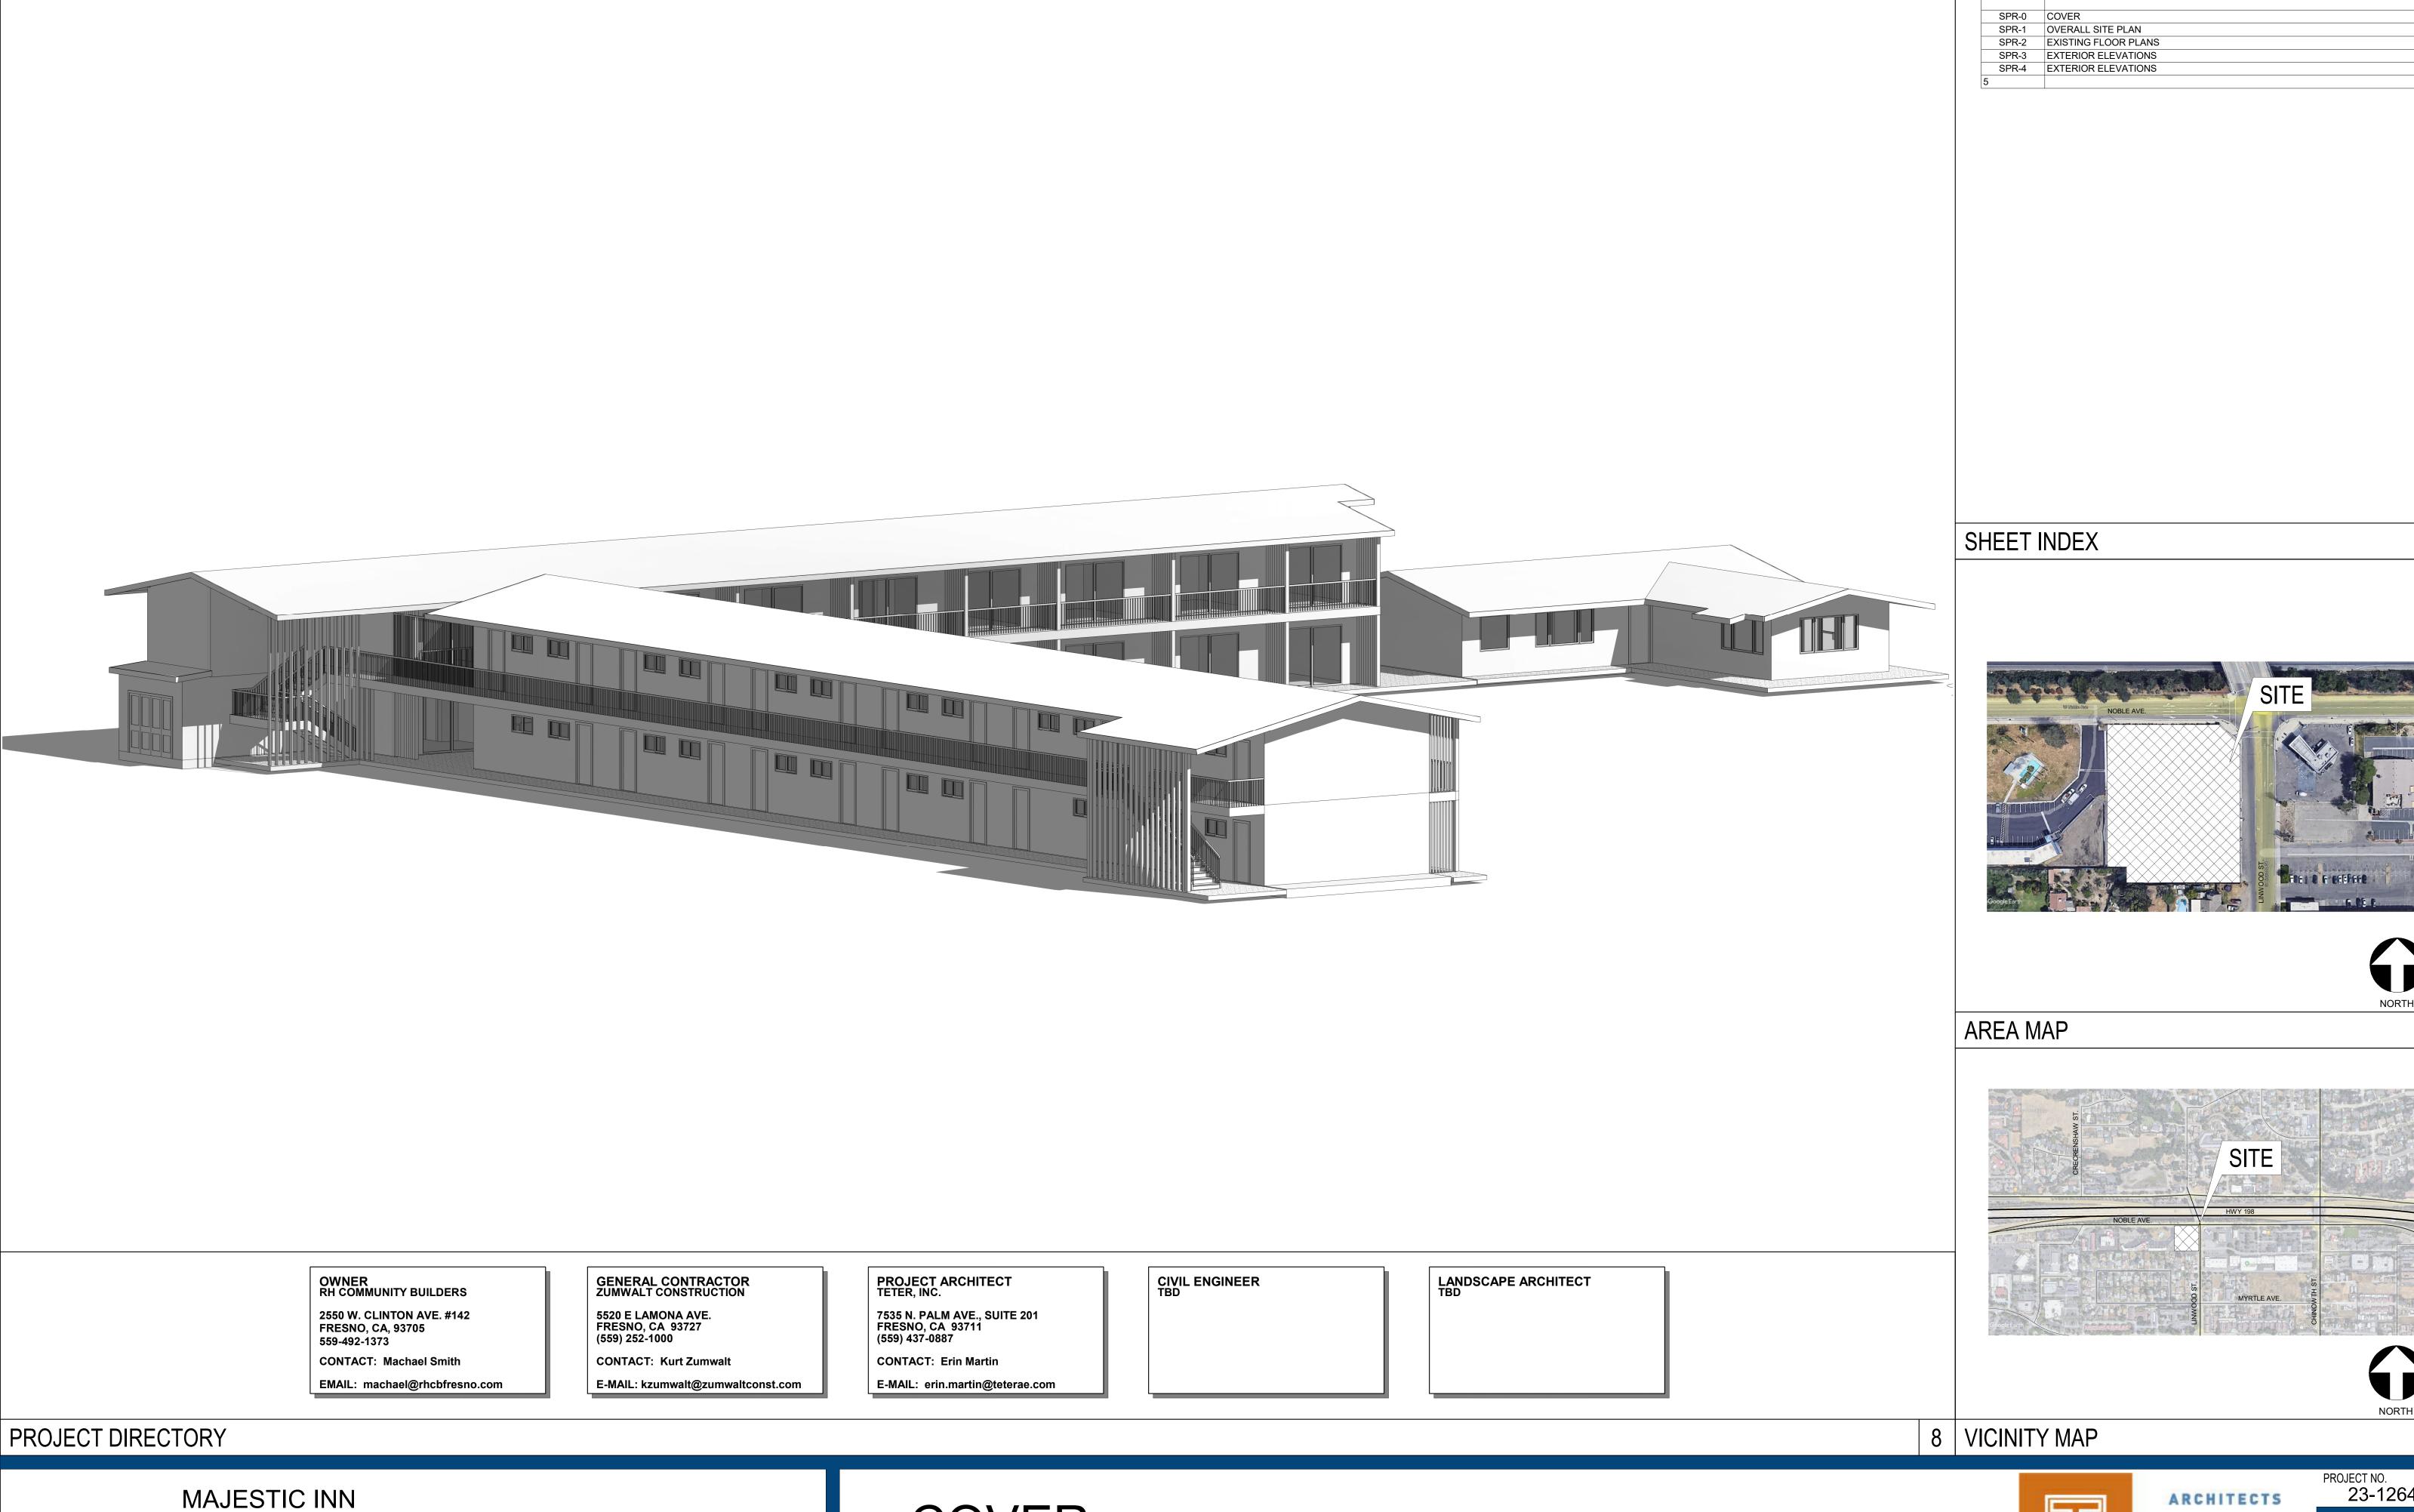


TETER

ARCHITECTS ENGINEERS CONNECTED PROJECT NO. **23-12641** DRAWING DATE: 01/26/23 SPR-0

NORTH

4545 W Noble Ave.

VISALIA, CA

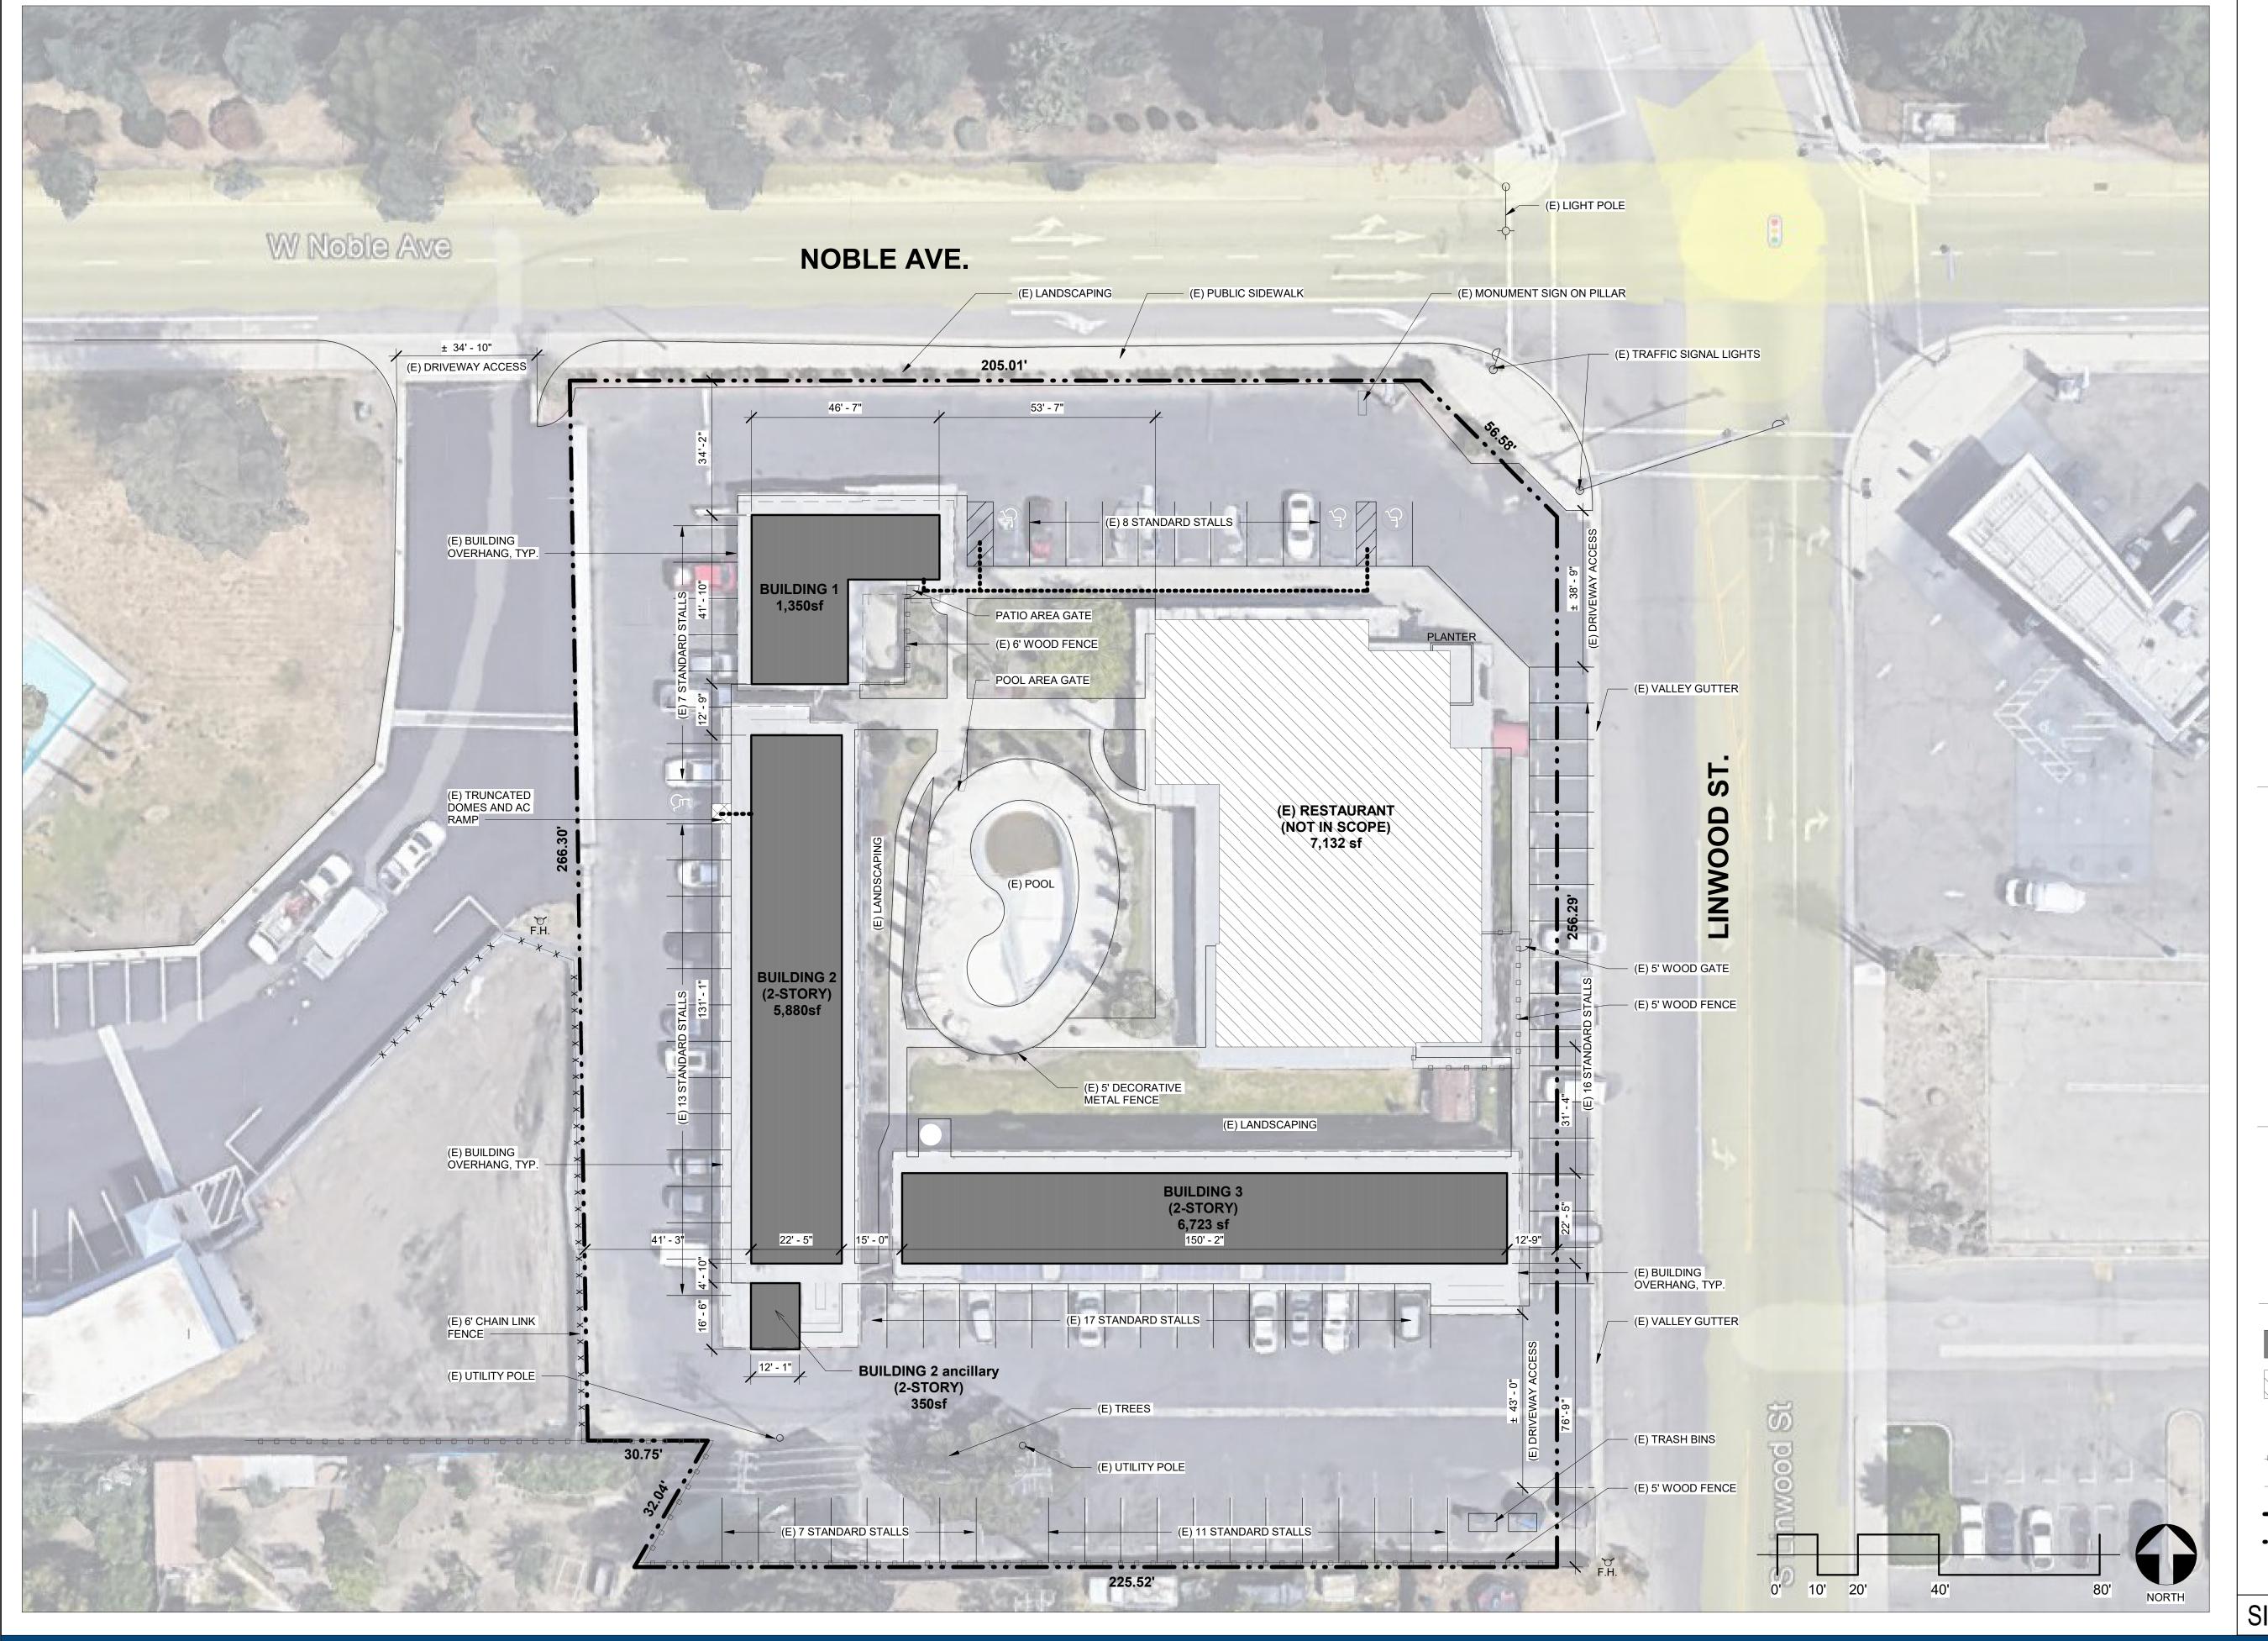

EXISTING STRUCTURES

BUILDING 1 (1 STORY)

1,350 sf

BUILDING 2 (2 STORIES) BUILDING 2 ancillary (2 STORIES) 2,940 sf per floor 200 sf first floor 100 sf second floor 6,230 sf total

BUILDING 3 (2 STORIES)

3,361.5 sf per floor 6,723 sf

(E) RESTAURANT

21,435 TOTAL SF

7,132 sf

PARKING TABULATION

EXISTING STANDARD PARKING EXISTING ACCESSIBLE PARKING

ALL EXISTING STANDARD PARKING SPACES ARE 16' X 9'

LEGEND

(E) BUILDING FOOTPRINT

(E) BUILDING FOOTPRINT (NOT IN SCOPE)

(E) WOOD FENCE

(E)FIRE HYDRANT

(E) CHAIN LINK FENCE

••••••• ACCESSIBLE P.O.T.

SITE INFORMATION

MAJESTIC INN


4545 W Noble Ave.


VISALIA, CA


OVERALL SITE PLAN






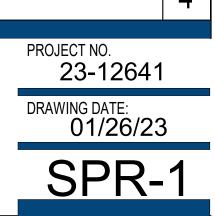

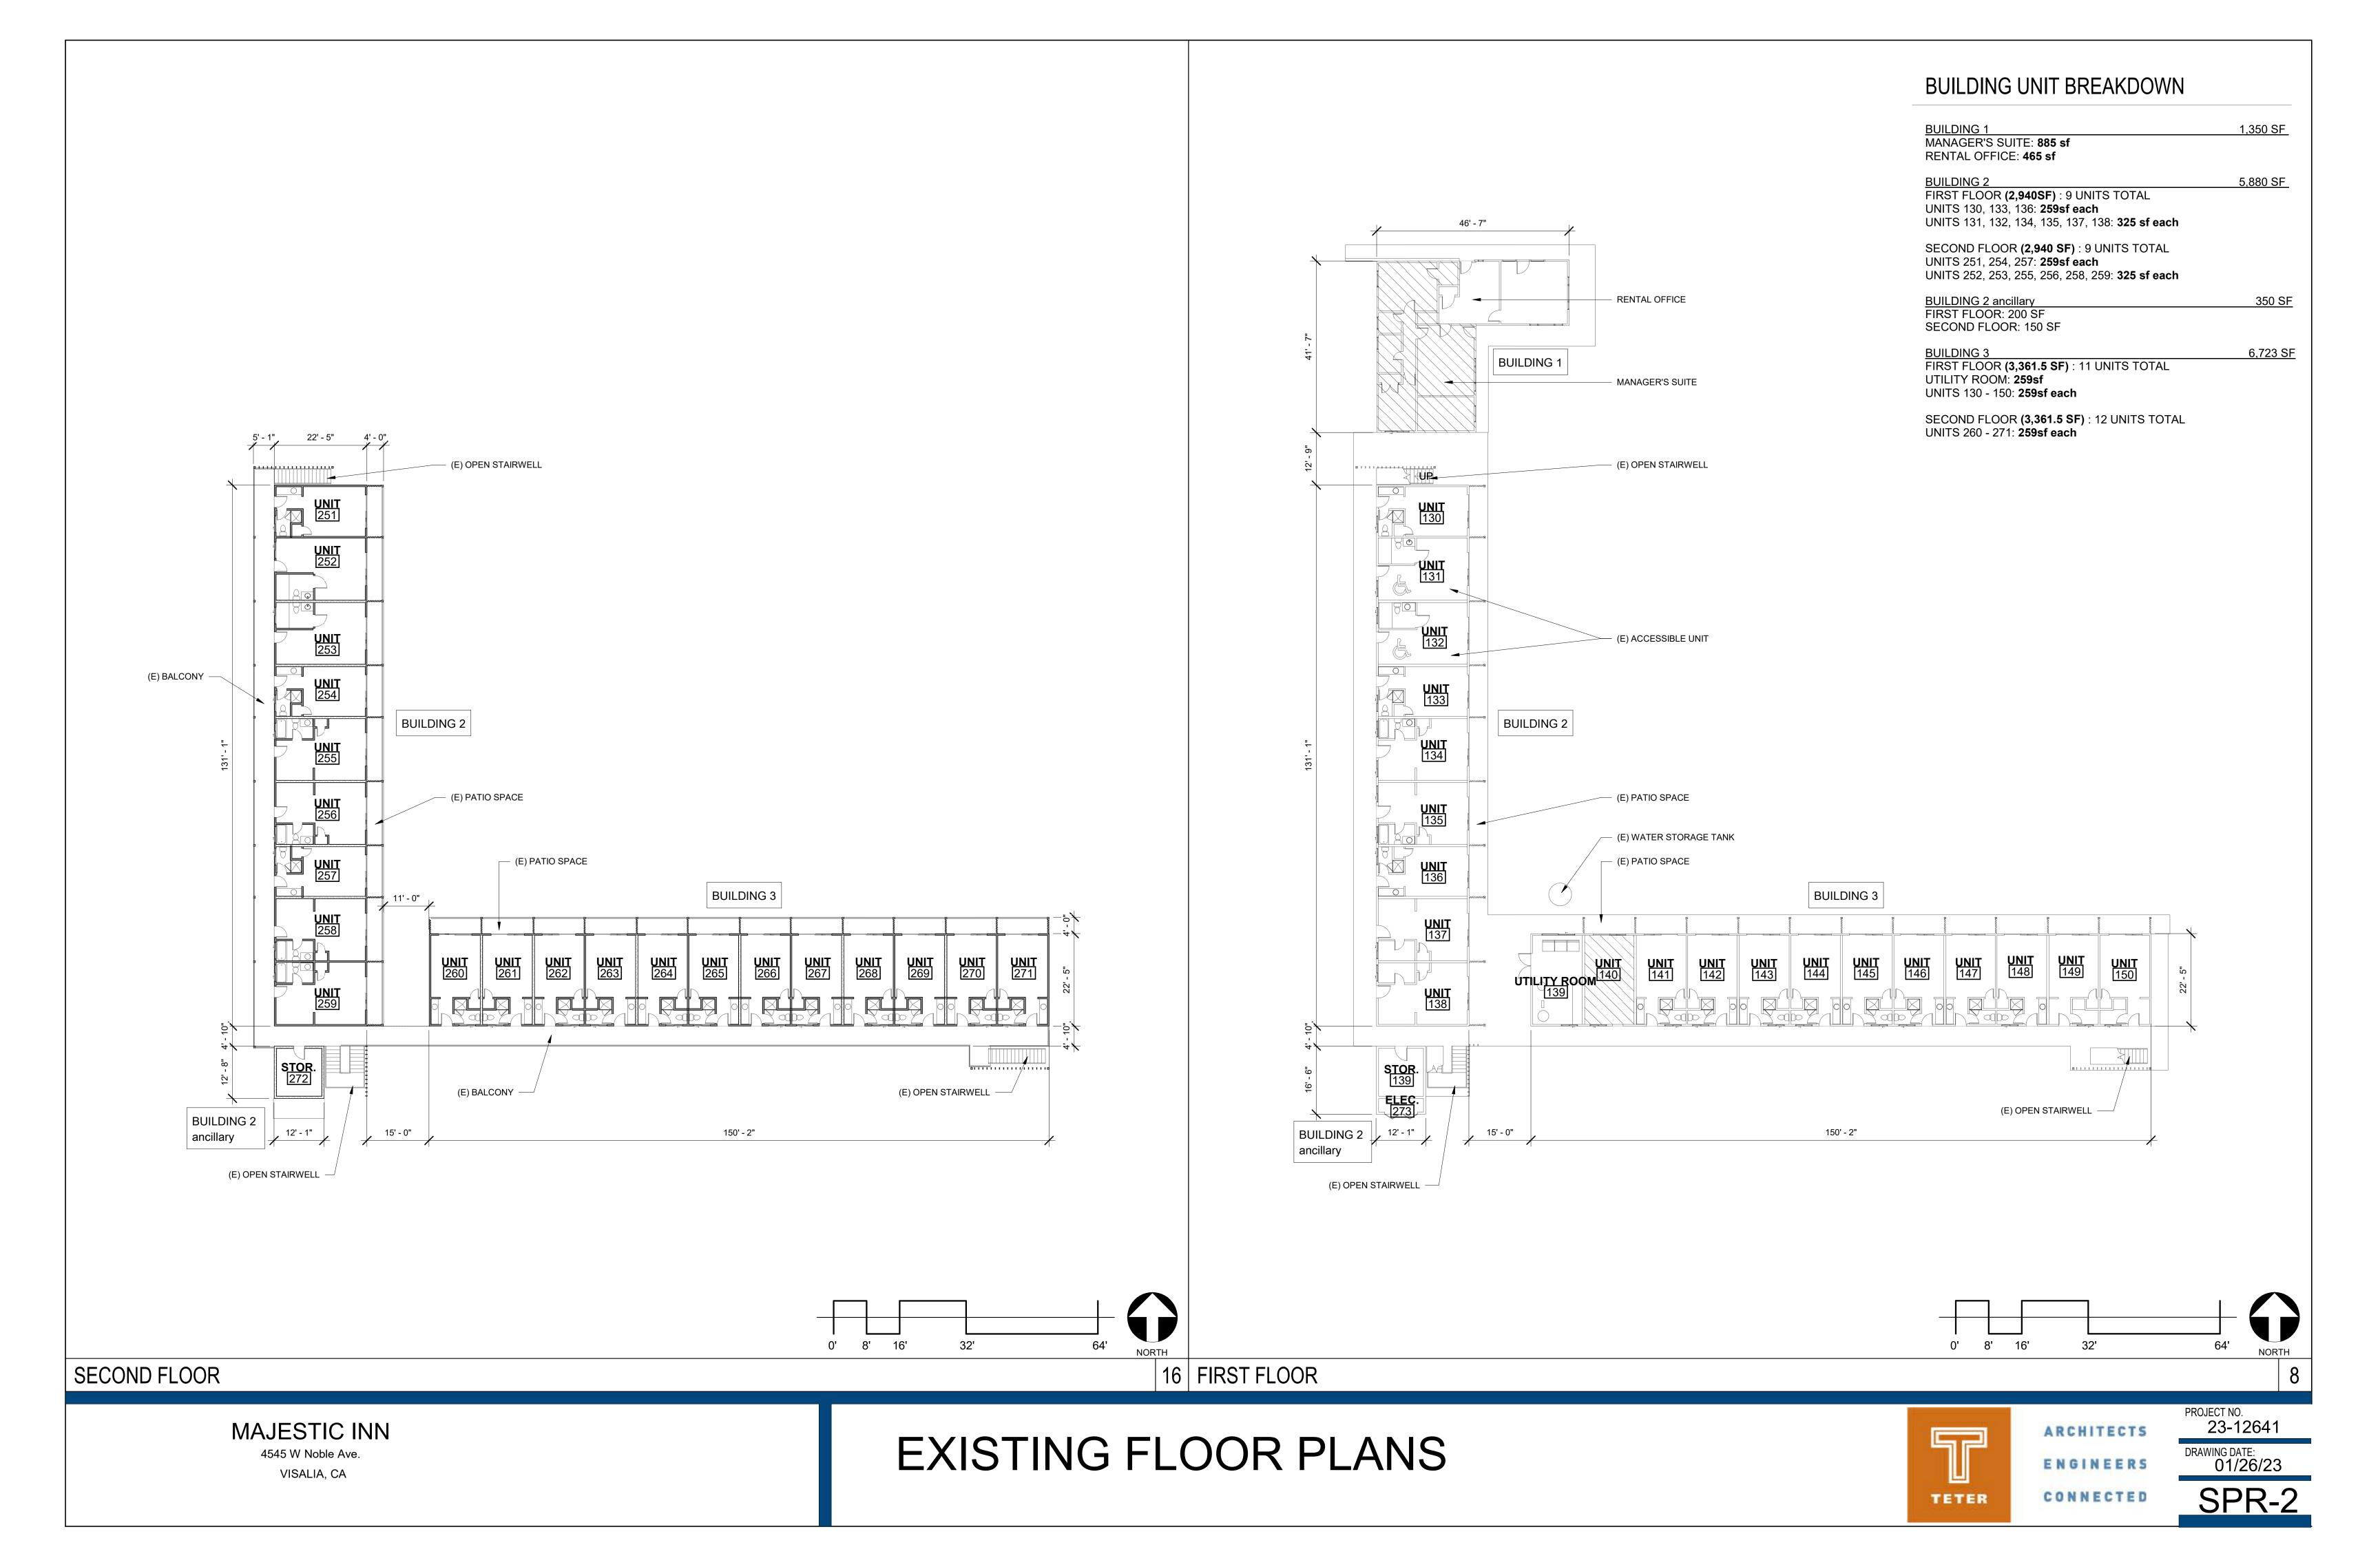

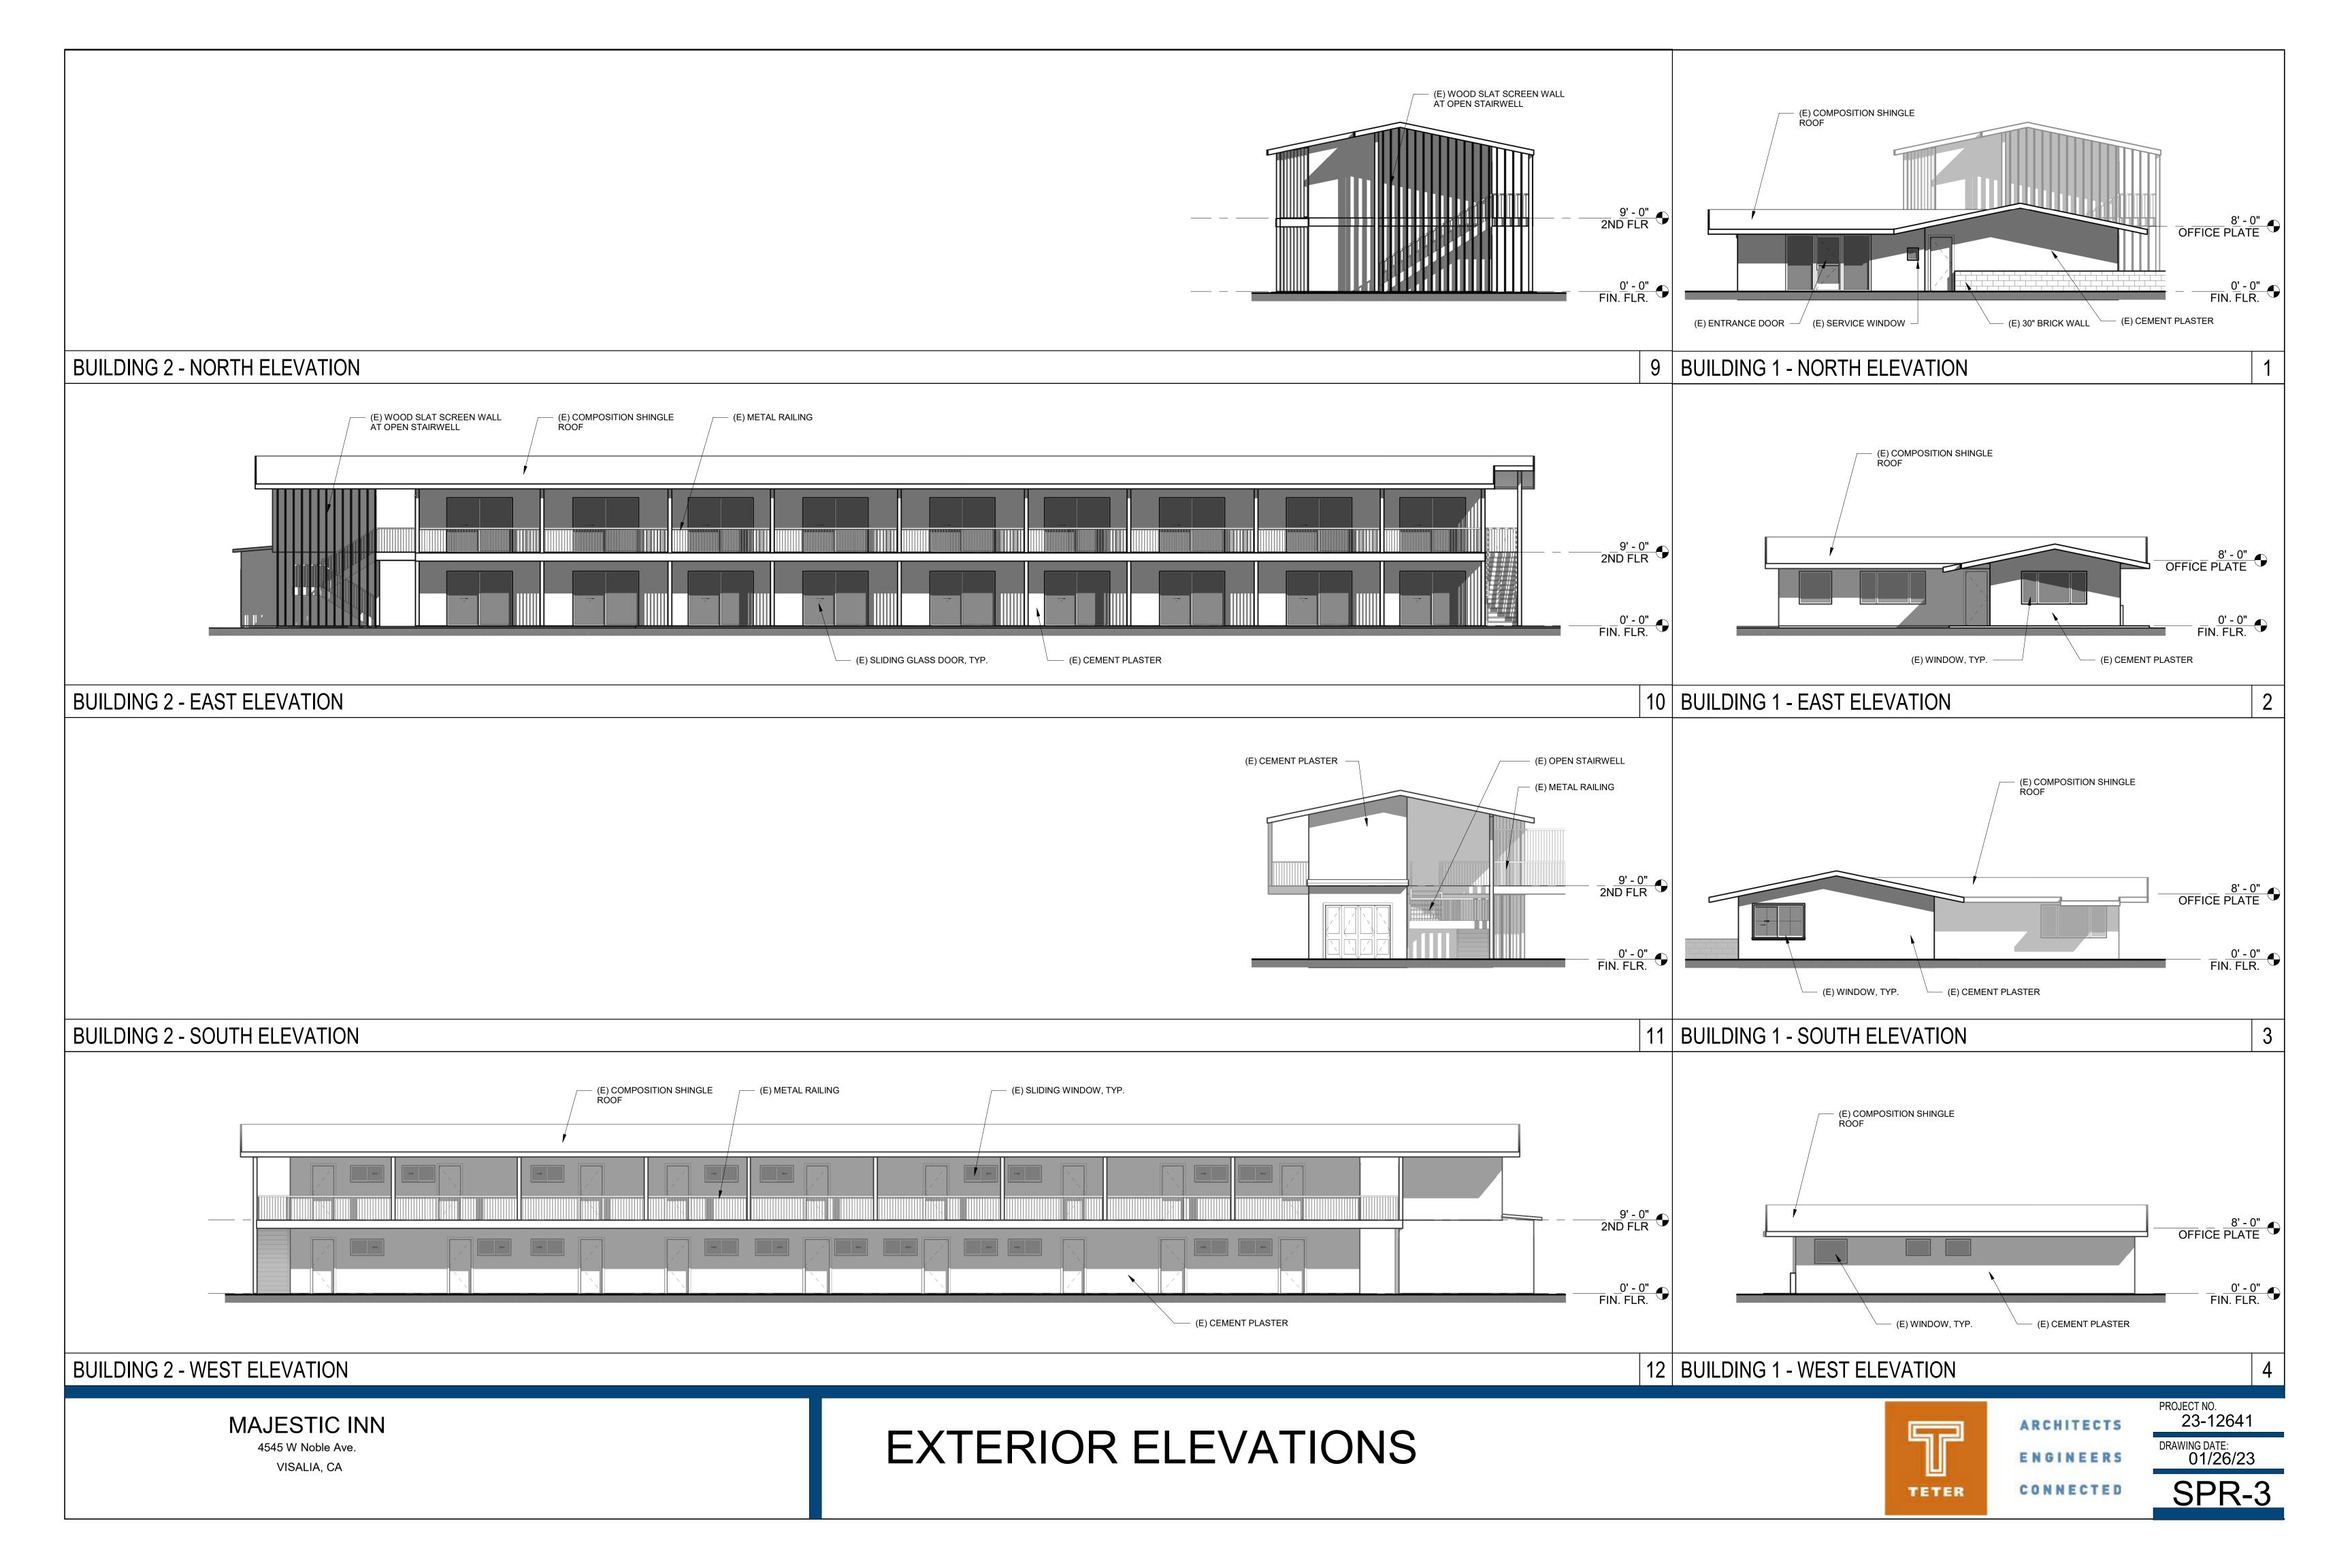

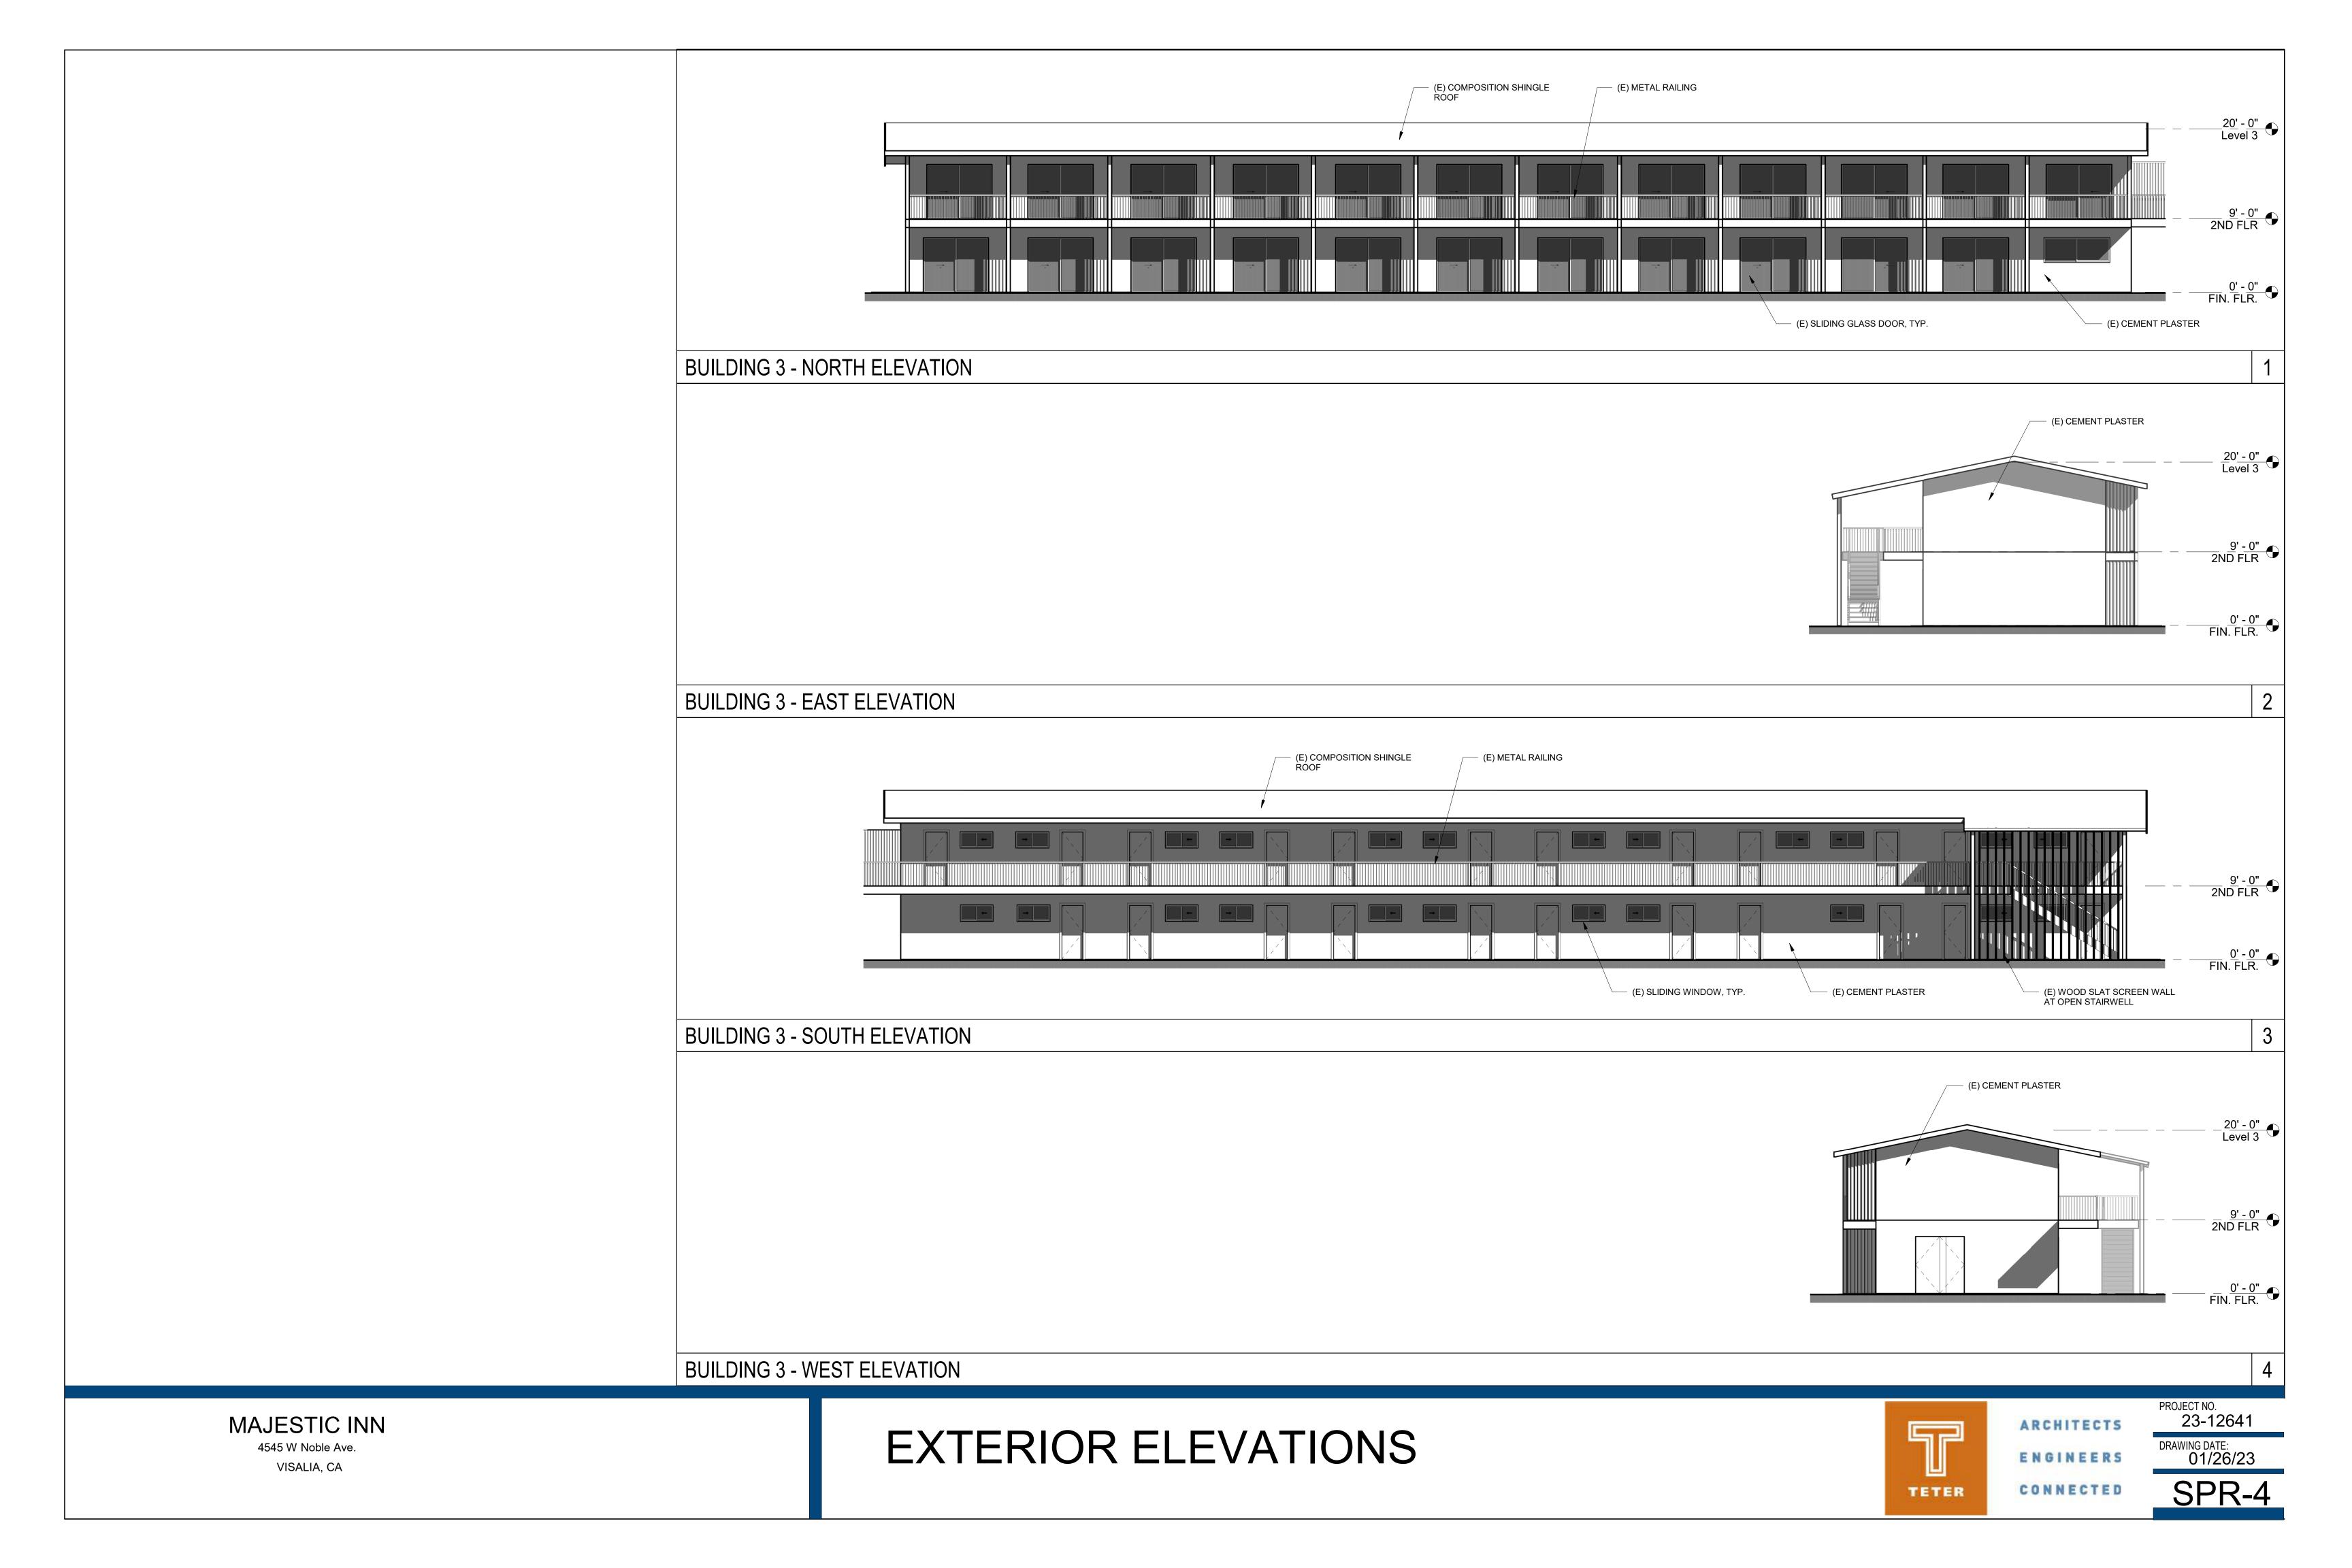

CITY OF VISALIA SITE PLAN REVIEW APPLICATION

Additional information and assistance in filling out this application can be found at the City of Visalia website (www.visalia.city) or by calling (559) 713-4440.



This application MUST be filled out in its entirety and submitted with an acceptable site plan (see site plan minimum requirements & submittal details on Page 2). Failure to provide all requested information may result in rejection of your application and exclusion from the Site Plan Review agenda.


Site Plan Review meetings are held on Wednesdays at 9:00 a.m. online utilizing Microsoft Teams. The applicant or representative must be present. Application submittal deadline are Thursday at 4:00 p.m. to be scheduled for the next available meeting. Project/Business Name: Project Description: SENERAL PROJECT INFORMATION Site Plan Review Resubmittal: If Resubmittal, Previous Site Plan Review Number: Property Owner: Applicant(s) Name: Project Address/Location: Assessor Parcel Number: Parcel Size (Acreage or Square Feet): Building or Suite Square Footage: (2005) Are There Any Proposed Building Modifications: --- THIS AREA FOR CITY STAFF USE ONLY ---Date Received: 02/09/2023 Estimated Cost of Modifications to Building: SPR Agenda: ______ 15/2023 | Item No. _ Describe All Proposed Building Modifications: Zone: C-MU SPR No. 23-025 Historic District: Yes No (X) AE X X/AE Flood Zone: -- A SEPARATE, DETAILED OPERATIONAL STATEMENT IS HIGHLY RECOMMENDED FOR ALL SUBMITTALS --Existing/Prior Building Use: Proposed Building Use: 8 AM to GPM Proposed Hours of Operation: & TRAFFIC INFORMATION SU M D W M P SQ Days of Week In Operation (Circle): Number of Employees Per Day: Existing Proposed Number of Customers Per Day (Estimated): Existing Proposed Predicted Peak Operating Hour: ILAN Describe Any Truck Delivery Schedule & Operations: OPERATIONS Please Identify Any Unique or Specific Traffic Patterns That Will Require Accommodations For Operations, Customers, or Employees (Provide Separate Attachment if Necessary): Describe Any Special Events Planned for the Facility:

Page 1 of 2 - Application continues on back of this page


SITE PLAN REQUIREMENTS	SITE PLAN MINIMUM REQUIREMENTS		
	Submit a digital copy of the site plan(s) and completed application on a flash drive or equivalent (PDF format preferred, hard paper copies		
	not accepted).		
	Digital copies must be clear, legible, and on a layout sized appropriately to convey all necessary project information.		
<u>0</u>	⇒ Site plan shall provide for and indicate all of the following:		
N	- North arrow - Existing & proposed structures - Loading/unloading areas		
5	- All existing & proposed site features - Adjacent street names - Accessible path of travel from right of way		
SITE	- Site dimensions, including building - Refuse endosures & containers - Accessible path of travel from ADA stall - Existing and proposed fencing at site - Valley oak trees (show drip line) - Location and width of drive approaches to site		
	 Existing and proposed fencing at site Public improvements (curbs, sidewalks, Existing & proposed landscaping Location and width of drive approaches to site Tentative maps shall adhere to requirements 		
	utility poles, hydrants, street lights, etc.) - Parking stalls (include ADA) of Visalia Municipal Code Section 16		
, A.S.	Applicant Information (Final comments will be mailed to the name and address provided below)		
JRE	Name: Serucindo Ledesma Signature of Owner or Authorized Agent		
M	Address: 2323 N Vickie Ct		
Sign	City, State, Zip Vi Salia (,1 43242 Owner Date		
REQUIRED SIGNATURE	Phone: 559 3345945		
Egu	Email: Qn L Multile 1559 augman . Len Authorized Agent* Date		
~	· If signed by an authorized agent, the "Agency Authorization" information below must be completed for this application to be considered acceptable.		
	AGENCY AUTHORIZATION		
	OWNER:		
3	Jaime Aguet I,, declare as follows; I am the owner of certain real property bearing assessor's		
	parcel number (APN):		
	_394-250-028		
	AGENT:		
	I designate Servando Hedes manto act as my duly authorized agent for all purposes peressary to file		
Σ	I designate SLTUAND HULD MO to act as my duly authorized agent for all purposes necessary to file an application for, and obtain a permit to MULCLETENT BUSINUS TO SQT N BUT KESTICET		
5	relative to the property mentioned herein.		
OIL	I declare under penalty of perjury the foregoing is true and correct.		
AGENCY AUTHORIZATION FORM	2/6/2023		
	Executed this day of		
	OWNER Signatures		
SENC	OWNER Signatures AGENT		
¥	Jaine Aguet		
	Signature of Olimature of Agent		
	2323 NVICKIE CT		
	Owner Mailing Address Agent Mailing Address		
	1000 324 1046		
	Owner Phone Number Agent Phone Number Agent Phone Number		
	- Agent - Horie Hallinger		
_	Page 2 of 2		

We are planing to use the building for an automobile Repair Shop. Repair Like Transmissions Brakes oil Changes Carbulator mofflers Engines air Conditions Diagnostics Tires

Google Maps

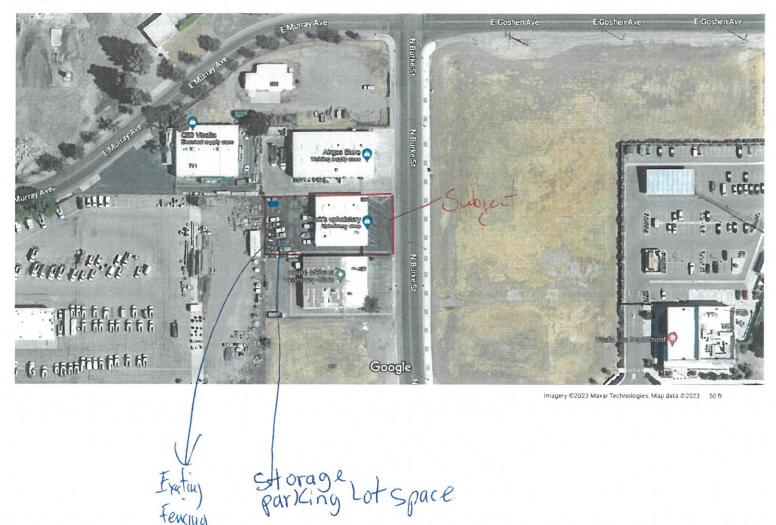

Burke

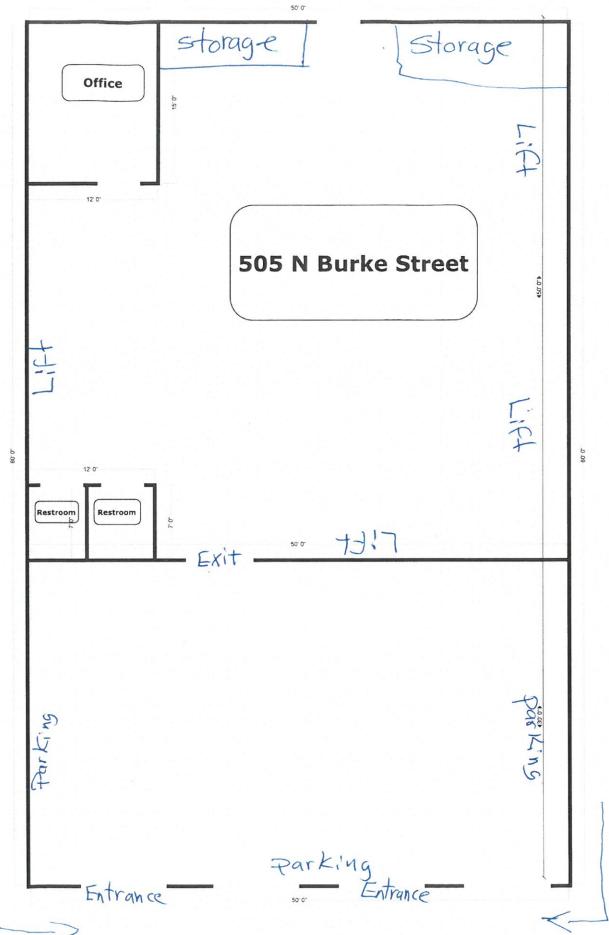

CITY OF VISALIA SITE PLAN REVIEW APPLICATION

Additional information and assistance in filling out this application can be found at the City of Visalia website (www.visalia.city) or by calling (559) 713-4440.



This application MUST be filled out in its entirety and submitted with an acceptable site plan (see site plan minimum requirements & submittal details on Page 2). Failure to provide all requested information may result in rejection of your application and exclusion from the Site Plan Review agenda.

Site Plan Review meetings are held on Wednesdays at 9:00 a.m. online utilizing Microsoft Teams. The applicant or representative must be present.

Application submittal deadline are Thursday at 4:00 p.m. to be scheduled for the next available meeting.

Z	Project/Business Name: JC LZU Capital LLC	Date: 02/09/2023	
	Project/Business Name: JC LZV Capital LLC Project Description: MRDICAL CLINIC		
01		p.	
GENERAL PROJECT INFORMATION	Site Plan Review Resubmittal: Yes No If Resubmittal, Previous Site Pl	lan Review Number:	
INFO	Property Owner: JC LIU Capital LLC		
OJECT	Applicant(s) Name:		
L PR	Project Address/Location: 2318 W SULLINGS	SE NA	
NERA	Assessor Parcel Number: 1 2 1 1 0 0 0 8 5		
GE	Parcel Size (Acreage or Square Feet): Building or Suite So	quare Footage: 2/24e	
	Are There Any Proposed Building Modifications: Yes No	THIS AREA FOR CITY STAFF USE ONLY	
	Estimated Cost of Modifications to Building:	Date Received: 02/09/2023	
	Describe All Proposed Building Modifications:	SPR Agenda: 02/15/2023 Item No	
		Zone: O-PA SPR No. 23-026	
		Historic District: Yes No	
		Flood Zone: X X AE X/AE	
	A SEPARATE, DETAILED OPERATIONAL STATEMENT IS HIGHLY RECOM	MENDED FOR ALL SUBMITTALS	
	Existing/Prior Building Use:		
	Proposed Hours of Operation:		
& TRAFFIC INFORMATION	Days of Week In Operation (Circle): Su M T W Th F Sa		
RMA	Number of Employees Per Day: Existing Proposed	30	
N.	Number of Customers Per Day (Estimated): Existing Proposed	1 100	
AFFIC	Predicted Peak Operating Hour:		
	Describe Any Truck Delivery Schedule & Operations:		
OPERATIONS			
PERA	Please Identify Any Unique or Specific Traffic Patterns That Will Require Accommodations For Operations, Customers, or Employees		
0		.,,,,,,,,,,,,,,,,,,,,,,,,,,,,,,,,,,,,,,	
1	(Provide Separate Attachment if Necessary):		
	(Provide Separate Attachment if Necessary):		
	(Provide Separate Attachment if Necessary):		

	SITE PLAN MINIMUM REQUIREMENTS				
	Submit a digital copy of the site plan(s) and completed application on a flash drive or equivalent (PDF format preferred, hard paper copies				
NES	not accepted).				
SITE PLAN REQUIREMENTS	Digital copies must be clear, legible, and on a layout sized appropriately to convey all necessary project information.				
UR					
REO	⇒ Site plan shall provide for and indicate all of the following: - Existing & proposed structures " - Loading/unloading areas				
M	- All existing & proposed site features - Adjacent street names - Accessible path of travel from right of way				
TE P	- Site dimensions, including building - Refuse enclosures & containers - Accessible path of travel from ADA stall				
S	- Existing and proposed fencing at site - Valley oak trees (show drip line) - Location and width of drive approaches to site				
	 Public improvements (curbs, sidewalks, - Existing & proposed landscaping - Tentative maps shall adhere to requirements utility poles, hydrants, street lights, etc.) - Parking stalls (include ADA) of Visalia Municipal Code Section 16 				
	Applicant Information (Final comments will be mailed to the name and address provided below)				
JRE	Name: JC LIU Capital LLC Signature of Owner or Authorized Agent*				
NAT	Address: 2346 W. Sunnyside Ave JONATHAN C. LIU 02/09/2023				
SIG	City, State, Zip Visalia, CA 93277 Owner Julius Lis Date				
RED	Phone: (559) 731 5087 2 2 9 23				
REQUIRED SIGNATURE	Email: Jonathan CLIU. E gmail. conthorized Agent Date				
æ	* If signed by an authorized agent , the "Agency Authorization" information below must be completed for this application to be considered acceptable.				
	The state of the s				
	AGENCY AUTHORIZATION				
	OWNER:				
	I, JONATHAN C. LIU declare as follows; I am the owner of certain real property bearing assessor's				
	parcel number (APN):				
10°					
	AGENT:				
	I designate to act as my duly authorized agent for all purposes necessary to file				
an application for, and obtain a permit to relative to the property mentioned herein. I declare under penalty of perjury the foregoing is true and correct. Executed this					
				Ĕ	Executed this day of
				YAI	Signatures ACENT
				SEN	OWNER Signatures AGENT
¥					
to j	Signature of Owner Signature of Agent				
5- 8	2346 W. Sunnyside Avenue 870 W. CENTER				
	Owner Mailing Address Agent Mailing Address				
i i i	Visalia, CH 73211 VISALIA 73211				
	(SS9) 731 5087 559 280 1024				
61,	Owner Phone Number Agent Phone Number				

Page 2 of 2

